
# STATE OF MAINE DEPARTMENT OF TRANSPORTATION






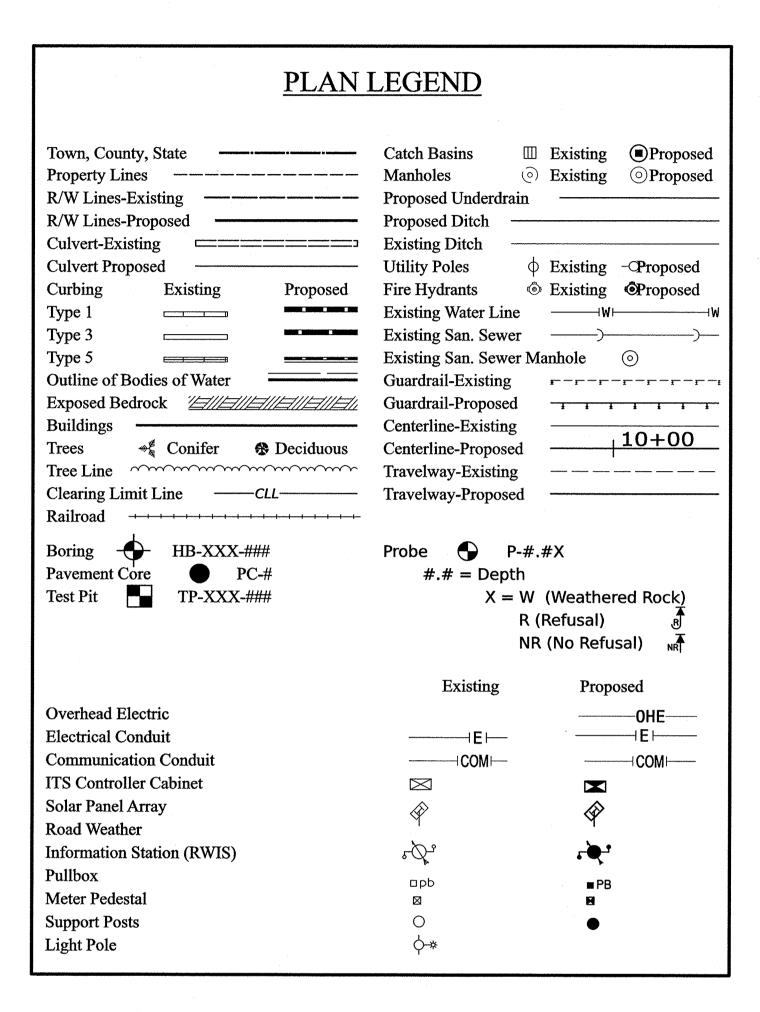

# MACHIAS TO CALAIS

WASHINGTON COUNTY
DOWNEAST COASTAL US ROUTE 1 IMPROVEMENT PROJECT
FEDERAL AID PROJECT 2663013

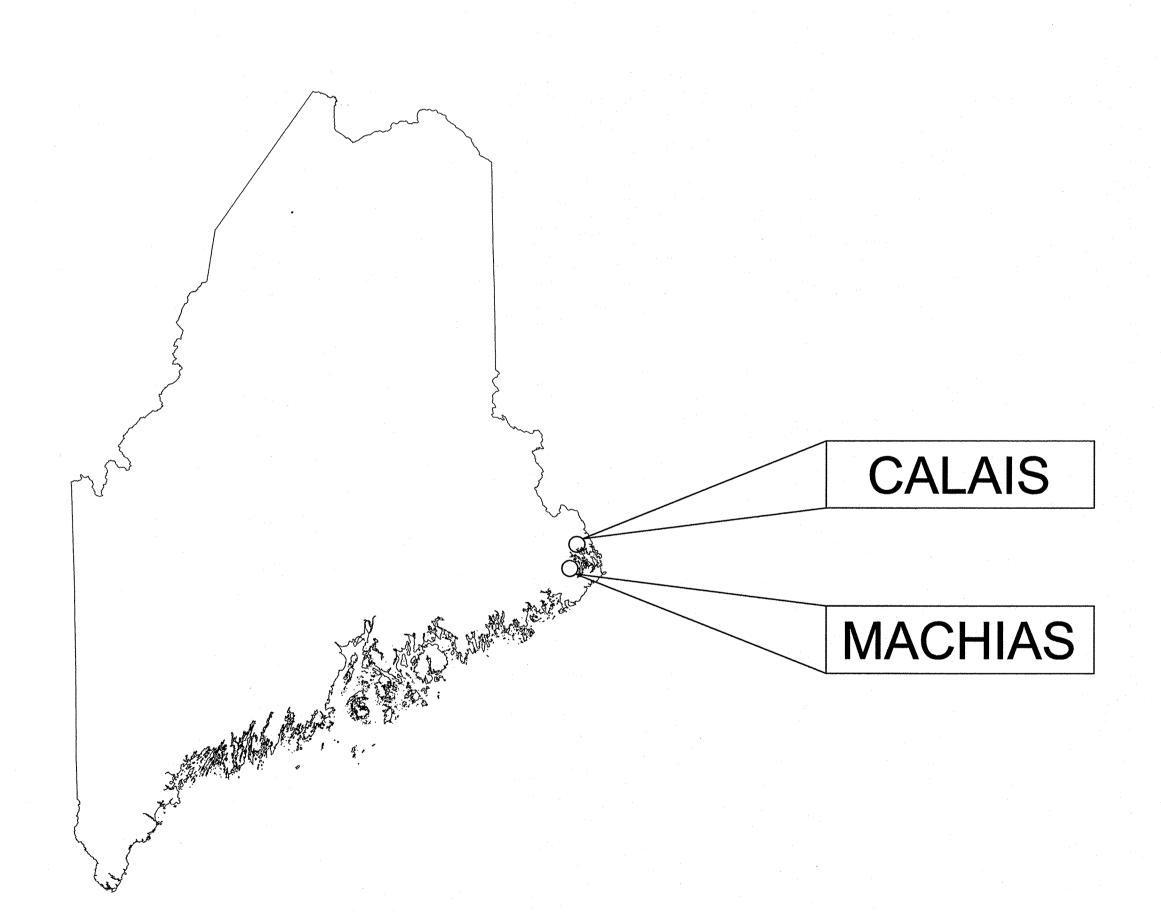

PROJECT LOCATION:	CALAIS-MACHIAS - US ROUTE 1
PROGRAM AREA:	REGIONAL PROGRAM
SCOPE OF WORK:	THIS PROJECT WILL INSTALL TWO NEW ROAD WEATHER INFORMATION STATIONS (RWIS), THREE ICY CURVE WARNING SYSTEMS, AND CURVE WARNING SIGNING UPGRADES AT SIX LOCATIONS.

## INDEX OF SHEETS

Description	Sheet No
Title Sheet	1
General Notes	
Location Map	
Details	
Sign Summary	
Equipment Plans	

DEFINITION OF THE MACHIAS TO

SHEET NUMBER

SHEET

- 2. CONSTRUCTION SHALL BE IN CONFORMANCE WITH THE LATEST EDITION OF THE MAINEDOT STANDARD DETAILS AND THE MAINEDOT BEST MANAGEMENT PRACTICES FOR EROSION AND SEDIMENT CONTROL (LATEST EDITION AND REVISIONS) UNLESS OTHERWISE INDICATED IN THESE PLANS.
- 3. NO FORMAL SURVEY WAS CONDUCTED FOR THE DESIGN OF THIS PROJECT. CONDUITS AND PULL BOXES WERE NOT ASSIGNED GPS COORDINATES. DESIGN WAS BASED ON AERIAL PHOTOGRAPHY, AND FIELD INVESTIGATION CONDUCTED BY MAINEDOT.
- 4. ALL NON-PAVED AREAS DISTURBED DURING CONSTRUCTION SHALL BE LOAMED AND SEEDED, UNLESS OTHERWISE DIRECTED BY THE RESIDENT. ALL PAVED AREAS DISTURBED DURING CONSTRUCTION SHALL BE REPAIRED BY THE CONTRACTOR. COSTS FOR REPAIR OF DISTURBED AREAS SHALL BE INCIDENTAL TO OTHER CONTRACT ITEMS.
- 5. THE CONTRACTOR SHALL CONTACT DIG SAFE PRIOR TO ANY EXCAVATION WORK.
- 6. THE CONTRACTOR SHALL INSTALL A GROUNDING SYSTEM FOR EACH ELECTRICAL INSTALLATION THAT FOLLOWS LOCAL, STATE, AND NEC GUIDELINES. THE CONTRACTOR SHALL VERIFY A READING THAT MEETS MANUFACTURERS RECOMMENDATIONS UPON INSTALLATION. IN THE EVENT OF ONE OR TWO STANDARD COPPER GROUND RODS ARE INSUFFICIENT TO MEET THE MANUFACTURER'S GROUNDING REQUIREMENTS, THE CONTRACTOR SHALL INSTALL A CHEMICAL GROUND ELECTRODE SYSTEM. THE CHEMICAL GROUND ELECTRODE SYSTEM SHALL EITHER BE EPA APPROVED OR PLACED IN EPA APPROVED AND IEC 62561 BENCHMARK-EXCEEDING GROUND ENHANCEMENT MATERIAL.
- 7. THE CONTRACTOR SHALL STAKE OUT THE LOCATION OF ALL PROPOSED WOOD POLES, SIGN SUPPORTS AND RWIS EQUIPMENT AND REQUEST APPROVAL FROM THE RESIDENT PRIOR TO ORDERING MATERIALS.

#### TEMPORARY TRAFFIC CONTROL:

- 1. ALL TRAFFIC CONTROL EQUIPMENT, DEVICES, AND TEMPORARY TRAFFIC CONTROLS SHALL CONFORM TO THE 2009 EDITION OF THE FEDERAL HIGHWAY ADMINISTRATION (FHWA) MANUAL ON UNIFORM TRAFFIC CONTROL DEVICES (MUTCD), CHAPTER 6 AND THE LATEST EDITION OF THE MAINEDOT STANDARD DETAILS.
- 2. ALL TEMPORARY TRAFFIC CONTROL SIGNS, SIGN SUPPORT STRUCTURES, CHANNELIZING DEVICES, FLASHING ARROW PANELS (FAP), PORTABLE CHANGEABLE MESSAGE SIGNS (PCMS) AND OTHER TRAFFIC CONTROL EQUIPMENT ALONG THE ROADSIDE SHALL MEET OR EXCEED MANUAL FOR ASSESSING SAFETY HARDWARE (MASH) 2016, TEST LEVEL 3 (TL-3) IF MANUFACTURED AFTER DECEMBER 31, 2019. ALL OTHER TRAFFIC CONTROL EQUIPMENT SHALL MEET OR EXCEED NCHRP 350 TL-3.
- 3. ALL TEMPORARY TRAFFIC CONTROL SIGNS SHALL HAVE ASTM D4956 TYPE VII, TYPE VIII OR TYPE IX SUPER HIGH INTENSITY OR PRISMATIC FLUORESCENT RETROREFLECTIVE SHEETING AND SHALL BE MAINTAINED IN LIKE-NEW CONDITION. ALL ORANGE CONSTRUCTION SIGNS SHALL BE FLUORESCENT ORANGE WITH TYPE IX SHEETING. PLACEMENT OF CONSTRUCTION SIGNS SHALL BE ADJUSTED TO AVOID OBSTRUCTING EXISTING SIGNS AND TO ENSURE PROPER SIGHT LINES TO THE CONSTRUCTION SIGNS AS DETERMINED BY THE RESIDENT.
- 4. ANY SIGNS, EQUIPMENT, OR DEVICES FOUND TO BE DAMAGED OR UNSERVICEABLE SHALL BE REPLACED AT THE CONTRACTOR'S EXPENSE.
- 5. ALL SHOULDER AND LANE CLOSURES SHALL REQUIRE APPROVAL OF THE RESIDENT A MINIMUM OF TWO WORKING DAYS IN ADVANCE OF THE CLOSURE.
- 6. IF WORK IS TO BE CONDUCTED AT NIGHT, THE CONTRACTOR SHALL SUBMIT A LIGHTING PLAN FOR NIGHT WORK TO THE RESIDENT FOR APPROVAL.

#### **GUARDRAIL PROTECTION:**

1. IF THE CONTRACTOR ELECTS TO REMOVE A SEGMENT OF GUARDRAIL FOR ACCESS TO THE WORK AREA, THE CONTRACTOR SHALL RESET THE GUARDRAIL AT THE END OF THE WORKDAY. ALTERNATIVELY, THE CONTRACTOR SHALL PROTECT THE TEMPORARY BLUNT END WITH A SUITABLE CRASH CUSHION. CRASH CUSHIONS INSTALLED FOR THE CONTRACTOR'S CONVENIENCE WILL NOT BE PAID FOR BUT WILL BE CONSIDERED INCIDENTAL TO THE MAINTENANCE OF TRAFFIC CONTROL DEVICES ITEM.

#### RIGHT-OF-WAY


1. RIGHTS-OF-WAY WHERE NOTED IN THE PLANS WAS TAKEN FROM RECORD PLANS AND APPROXIMATED ON THE SITE PLANS. NO SURVEY OR BENCHMARKING WAS APPLIED TO THE RIGHT-OF-WAY INFORMATION SHOWN IN THE PLANS.

ESTIMATED QUANTITIES								
ITEM NO.	ITEM DESCRIPTION	QUANTITY						
626.11	PRECAST CONCRETE JUNCTION BOX	2 EA						
626.21	METALLIC CONDUIT (2-INCH)	30 LF						
626.21	METALLIC CONDUIT (3-INCH)	30 LF						
626.22	NON-METALLIC CONDUIT (2-INCH)	105 LF						
626.22	NON-METALLIC CONDUIT (3-INCH)	105 LF						
629.05	HAND LABOR, STRAIGHT TIME	8 HR						
643.972	WOOD POLE	6 EA						
645.11	DEMOUNT REGULATORY, WARNING, CONFIRMATION AND ROUTE MARKER ASSEMBLY SIGNS	41 EA						
645.292	REGULATORY, WARNING, CONFIRMATION AND ROUTE MARKER ASSEMBLY SIGNS TYPE II	470 SF						
652.34	CONE	75 EA						
652.35	CONSTRUCTION SIGNS	258 SF						
652.361	MAINTENANCE OF TRAFFIC CONTROL DEVICES	1 LS						
652.38	FLAGGER	400 HR						
652.41	PORTABLE-CHANGEABLE MESSAGE SIGN	1 EA						
654.51	ELECTRICAL SERVICE CONNECTION: WHITING	1 LS						
654.51	ELECTRICAL SERVICE CONNECTION: PERRY	1 LS						
654.531	MICRO-CLIMATE ROAD WEATHER INFORMATION SYSTEM: WHITING	1 EA						
654.531	MICRO-CLIMATE ROAD WEATHER INFORMATION SYSTEM: PERRY	1 EA						
654.61	ACTUATED CURVE WARNING SYSTEM: WHITING 1	1 LS						
654.61	ACTUATED CURVE WARNING SYSTEM: WHITING 2	1 LS						
654.61	ACTUATED CURVE WARNING SYSTEM: PERRY	1 LS						
656.75	TEMPORARY SOIL EROSION AND WATER POLLUTION CONTROL	1 LS						
	MOBILIZATION	1 LS						

PROJ. MANAGER	R. BARROWS	ВУ	DATE
DESIGN-DETAILED	D. SCHANDEL	J. ROBERT	8/15/2025
CHECKED-REVIEWED	D. SCHANDEL	M. SUENNEN 8/15/2025	8/15/2025
DESIGN2-DETAILED2			
DESIGN3-DETAILED3			
REVISIONS 1			
1 0 0 0 0 0 0 0 0 0 0 0 0 0 0 0 0 0 0 0			
REVISIONS 2			
REVISIONS 3			
REVISIONS 4			

SHEET NUMBER



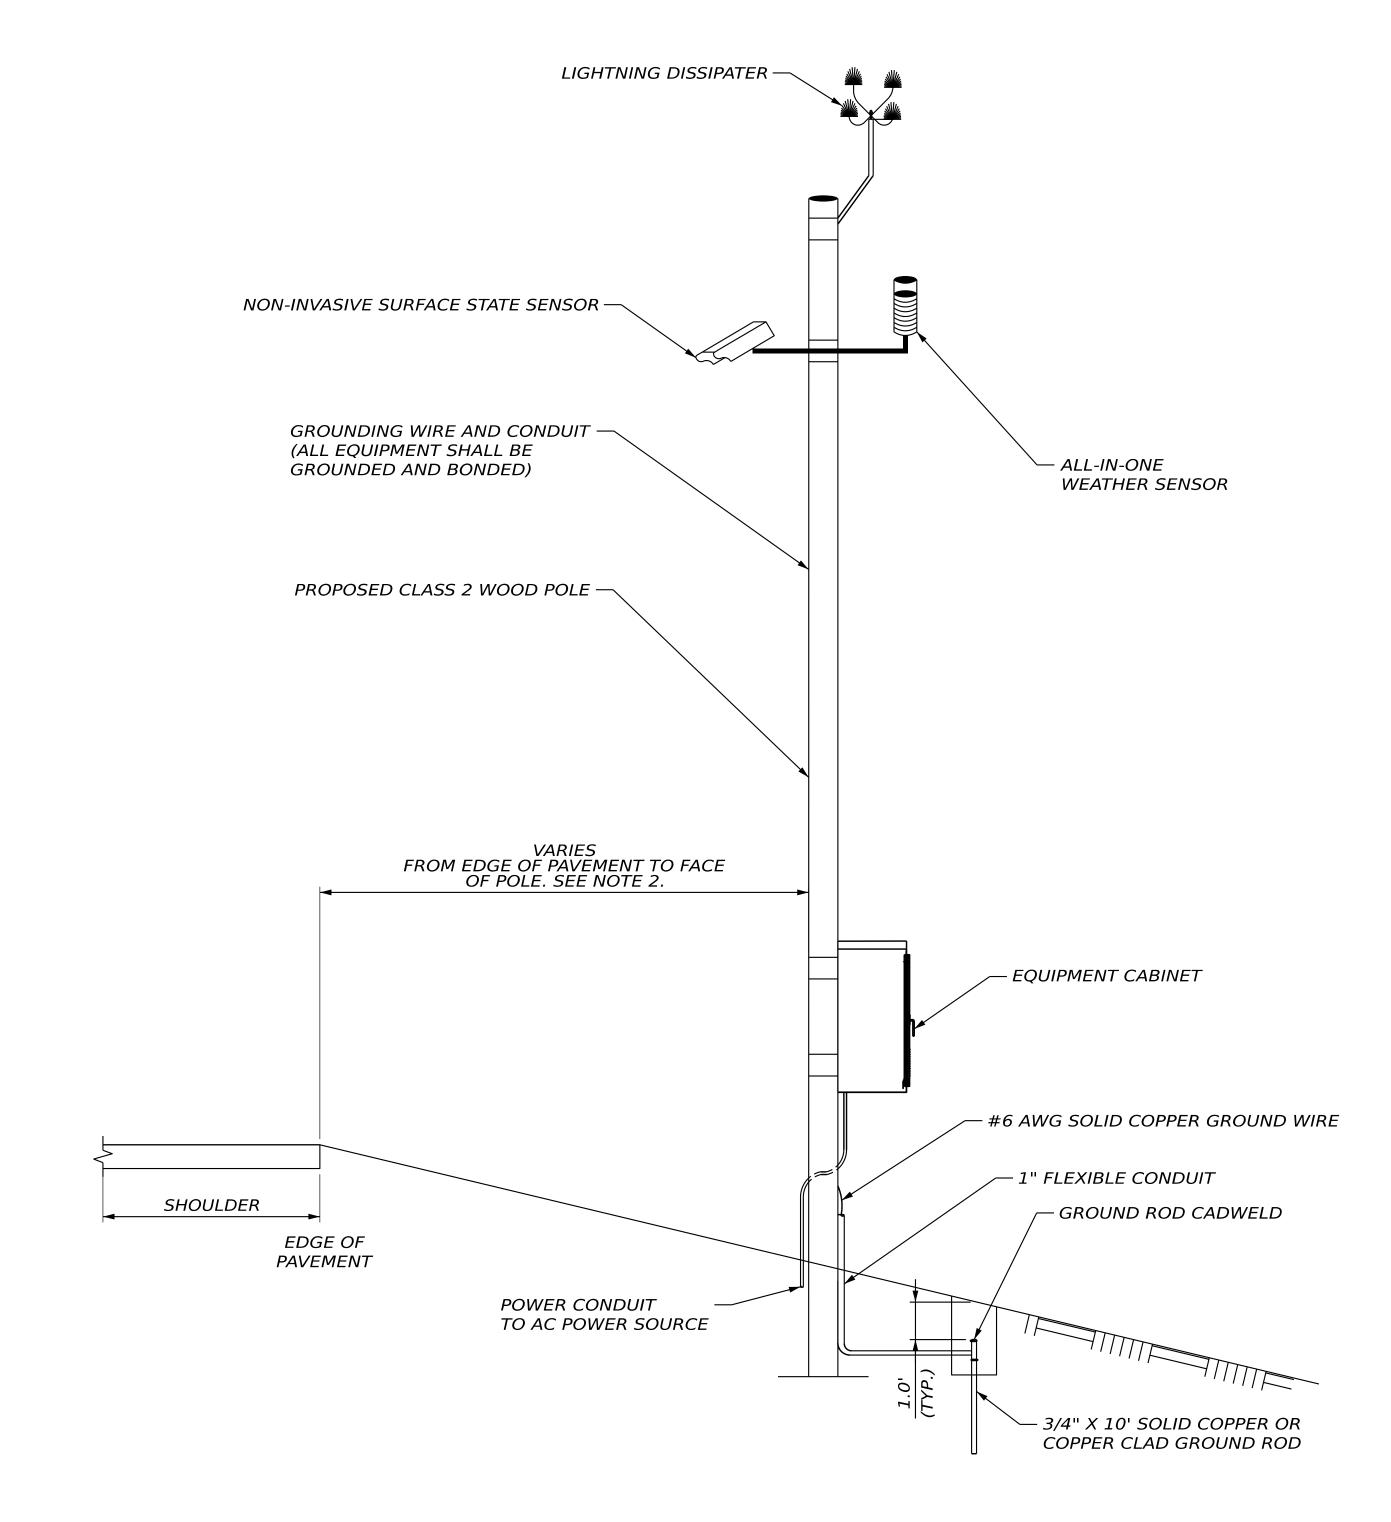


# MICRO-CLIMATE ROAD WEATHER INFORMATION STATION WOOD POLE DETAIL NOT TO SCALE

HIGH GAIN CELLULAR ANTENNA RWIS SENSORS RWIS SENSORS COAXIAL CABLE CELLULAR ETH. CABLE RWIS CONTROLLER MODEM ETH. CABLE TVSS PROTECTION ETH. CABLE FOR EQUIPMENT POWER CABINET CIRCUIT BREAKERS GROUND

# CELLULAR RWIS NOT TO SCALE

└─ 120 VAC POWER SERVICE

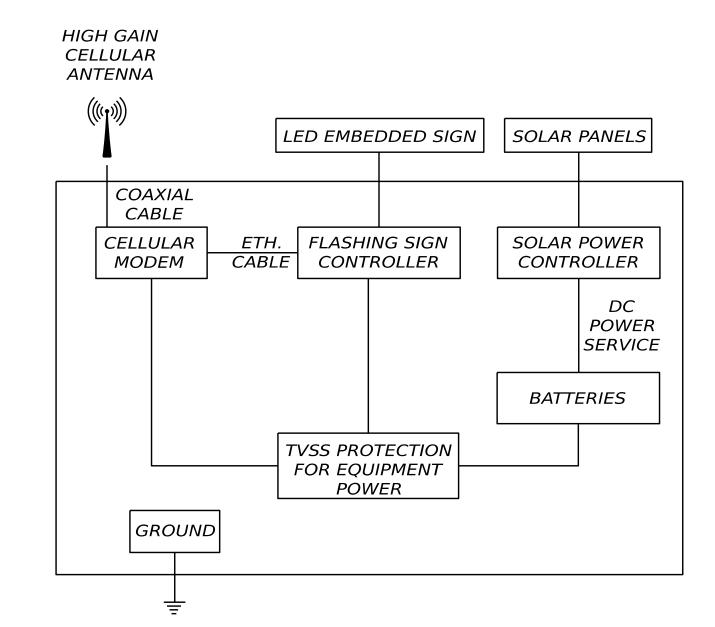

# CELLULAR ICY CURVE WARNING SIGN NOT TO SCALE

#### NOTES:

- 1. HEIGHT OF EQUIPMENT PER MANUFACTURER'S STANDARDS AND RECOMMENDATION. THE CONTRACTOR'S SUBMITTAL SHALL INCLUDE THE PROPOSED HEIGHTS OF THE RWIS SUPPORT POLES.
- 2. SEE INDIVIDUAL RWIS PLAN SHEETS FOR MORE DETAILS ON OFFSET FROM EDGE OF PAVEMENT.


DEPARTI

<b>∠</b> ►	DESIGN-DE LAILED	D. SCHANDEL
	CHECKED-REVIEWED	D. SCHANDEL
)	DESIGN2-DETAILED2	
	DESIGN3-DETAILED3	
	REVISIONS 1	
	REVISIONS 2	
	REVISIONS 3	
	REVISIONS 4	
	FIELD CHANGES	

DETAILS (01 OF 02)

SHEET NUMBER


4

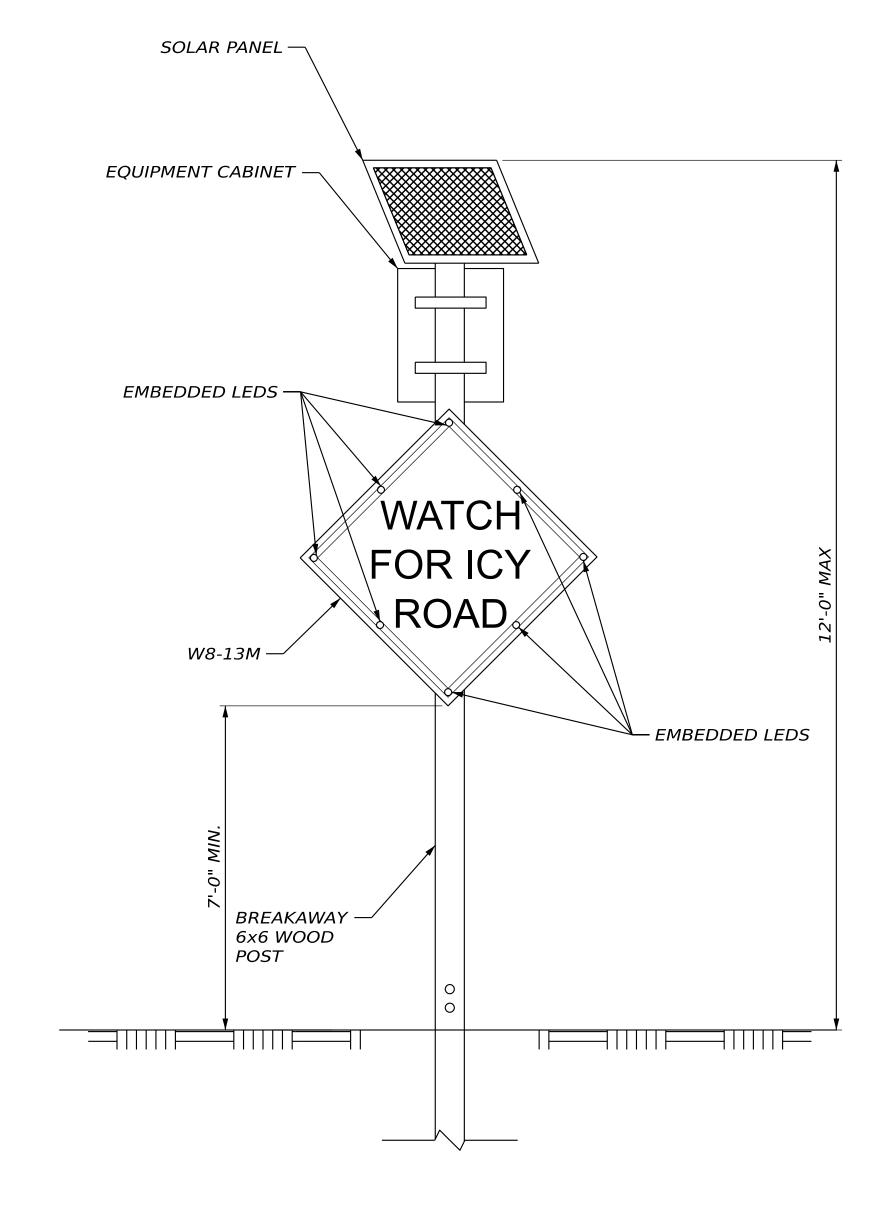

# ACTUATED CURVE WARNING ASSEMBLY NOT TO SCALE

## <u>NOTES:</u>

- 1. SEE INDIVIDUAL ICY CURVE WARNING PLAN SHEETS FOR MORE DETAILS SIGN PLACEMENT LOCATION.
- 2. SEE CABINET BLOCK DIAGRAMS ON DETAILS (01 OF 02) FOR MORE DETAILS ON THE POWER AND COMMUNICATIONS CONNECTIONS IN THE EQUIPMENT CABINET.
- 3. GROUND MOUNTED SIGN POSTS SHALL BE WOOD.
- 4. ALL SIGN SUPPORTS SHALL BE BREAKAWAY.
- 5. SIGN DIMENSIONS, LEGEND, AND FLASHING ASSEMBLY SHALL BE COMPLIANT WITH THE 11TH EDITION OF THE MANUAL ON UNIFORM TRAFFIC CONTROL DEVICES (MUTCD).
- 6. SEE SIGN SUMMARY SHEET FOR MORE DETAILS ON SIGN AND LEGEND SIZING.

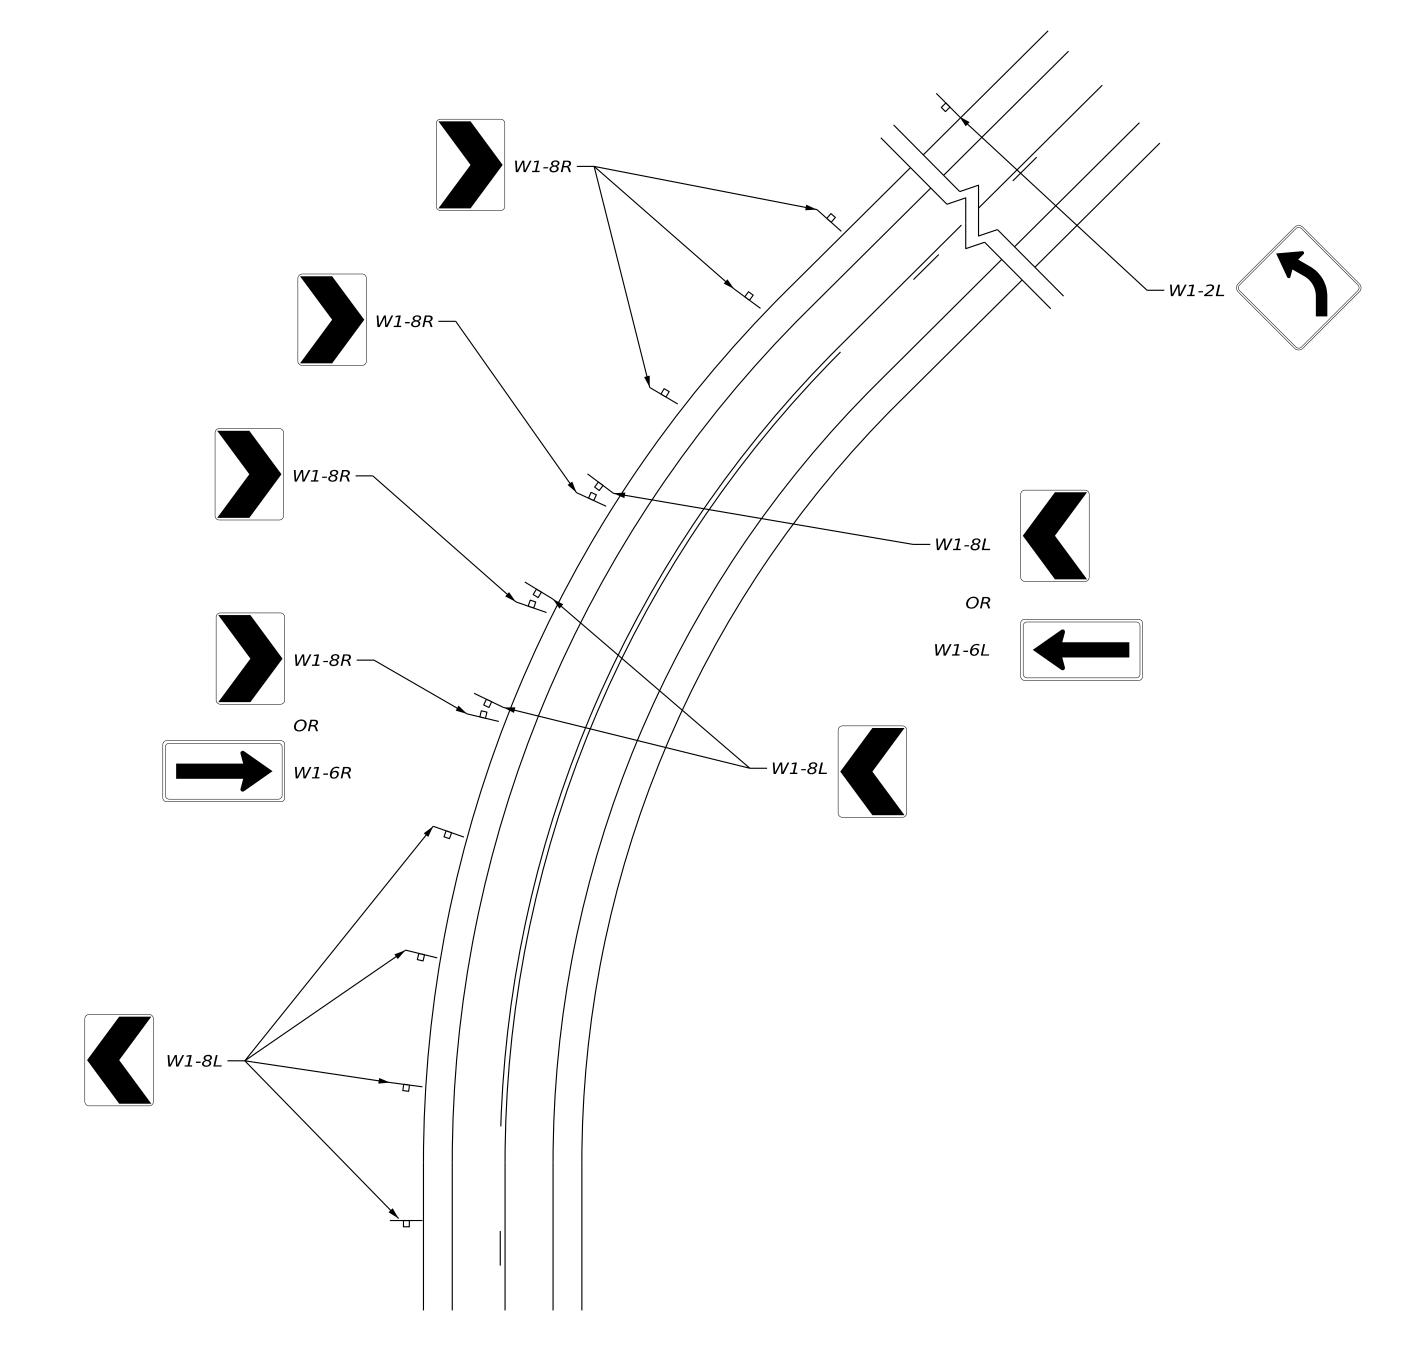

# CURVE WARNING LAYOUT DETAIL

NOT TO SCALE

#### NOTES:

- 1. SEE INDIVIDUAL CURVE WARNING LOCATION SHEETS FOR MORE DETAILS ON SIGN SPACING AND LOCATIONS.
- 2. ANY SIGNS MOUNTED IN AN ISLAND SHALL BE INSTALLED WITH AN ISLAND POST SLEEVE AND MEET THE REQUIREMENTS OF MAINEDOT STANDARD DETAIL 645(09)C.
- 3. ALL SIGNS SHALL BE MOUNTED ON WOOD POSTS.
- 4. ALL SIGN POSTS SHALL BE MADE BREAKAWAY AND MEET THE REQUIREMENTS SHOWN IN MAINEDOT STANDARD DETAIL 645(09)B.
- 5. SEE SIGN SUMMARY SHEET FOR SIGN DIMENSIONS AND SIZES.

SHEET NUMBER

Identifi-	Size o	of Sign	<u> </u>	Text D	imensions	(Inches)	Number of	Со	Ior	Border	Area in	
cation Number	Width	Height	Text	Letter Height	Vertical Spacing	Arrow RTE.MKR.	Signs	Back- ground	Legend Border	Radius	Square Feet	Post
W1-6R	48"	24"		SHSB	SHSB	SHSB	2	YELLOW	BLACK	SHSB	8.00 (16.00)	MOUNT ON 4"x4" WOOD POST
W1-6L	48"	24"					2	YELLOW	BLACK		8.00 (16.00)	MOUNT ON 4"x4" WOOD POST
W1-8R	18"	24"					36	YELLOW	BLACK		3.00 (108.00)	MOUNT ON 4"x4" WOOD POST
W1-8L	18"	24"					36	YELLÖW	BLACK		3.00 (108.00)	MOUNT ON 4"x4" WOOD POST
V1-8R(OS)	24"	36"					5	YELLOW	BLACK		6.00 (30.00)	MOUNT ON 4"x4" WOOD POST
V1-8L(OS)	24"	36"					5	YELLÖW	BLACK		6.00 (30.00)	MOUNT ON 4"x4" WOOD POST
W1-2L	36"	36"					9	YELLOW	BLACK		9.00 (81.00)	MOUNT ON 4"x6" WOOD POST
W1-2R	36"	36"					9	YELLOW	BLACK		9.00 (81.00)	MOUNT ON 4"x6" WOOD POST
W8-13M WITH MBEDDED LEDS	36"	36"	WATCH FOR ICY ROAD	5C	3.75"	-	6	YELLOW	BLACK	2.25"	9.00 54.00	MOUNT ON 6"x6" BREAKAWAY WOOD POST

Identifi-	Size o	of Sign		Text D	imensions	(Inches)	Number of	Co	olor	Border	Area in		AINE NSPORTATION		HIGHWAY PLAN
cation Number	Width	Height	Text	Letter Height	Vertical Spacing	Arrow RTE.MKR.	Signs	Back- ground	Legend Border	Radius	Square Feet	Post	E PORT	2663000	HBH
													STATE OF MAINE DEPARTMENT OF TRANSPO	PROJECT NO. 2663	WIN 26630.00
													WS BY DATE  J. ROBERT 8/15/2025  JEL M. SUENNEN 8/15/2025		
													DJ. MANAG SIGN-DETA ECKED-REY		REVISIONS 3 REVISIONS 4
													MACHIAS TO CALAIS		SIGN SUMMARY SHEET
													SHEE		
ו IEXt - מכר	mensionווע	is snail Co.	nform to "Standard Hig	nway Sign	5 BOOK" - 2	∠U1∠ EAITIO	11.						OF	17	



ITEM NO.	EQUIPMENT AND WORK ITEMS	QUANTITY
626.11	PRECAST CONCRETE JUNCTION BOX	1 EA
626.21	METALLIC CONDUIT (2-INCH)	15 LF
626.21	METALLIC CONDUIT (3-INCH)	15 LF
626.22	NON-METALLIC CONDUIT (2-INCH)	45 LF
626.22	NON-METALLIC CONDUIT (3-INCH)	45 LF
643.972	WOOD POLE	2 EA
654.51	ELECTRICAL SERVICE CONNECTION: WHITING	1 LS
654.531	MICRO-CLIMATE ROAD WEATHER INFORMATION SYSTEM: WHITING	1 EA


## NOTES:

- 1. THE CONTRACTOR SHALL INSTALL THE RWIS SENSORS PER THE MANUFACTURER'S RECOMMENDATIONS.
- 2. THE CONTRACTOR SHALL PROVIDE A METAL CONDUIT RISER ON THE PROPOSED UTILITY POLE FOR SECONDARY POWER SERVICE CONNECTION THAT EXTENDS A MINIMUM OF 7' ABOVE GRADE.
- 3. THE CONTRACTOR SHALL PROVIDE A SECOND METAL CONDUIT RISER ON THE PROPOSED UTILITY POLE FOR FUTURE COMMUNICATION CONNECTION.

0 25 50 1" = 25'-0" \* - RIGHT-OF-WAY INFORMATION FROM STATE HIGHWAY PROJECT #99-H, DATED NOVEMBER 1935.

SHEET NUMBER

7

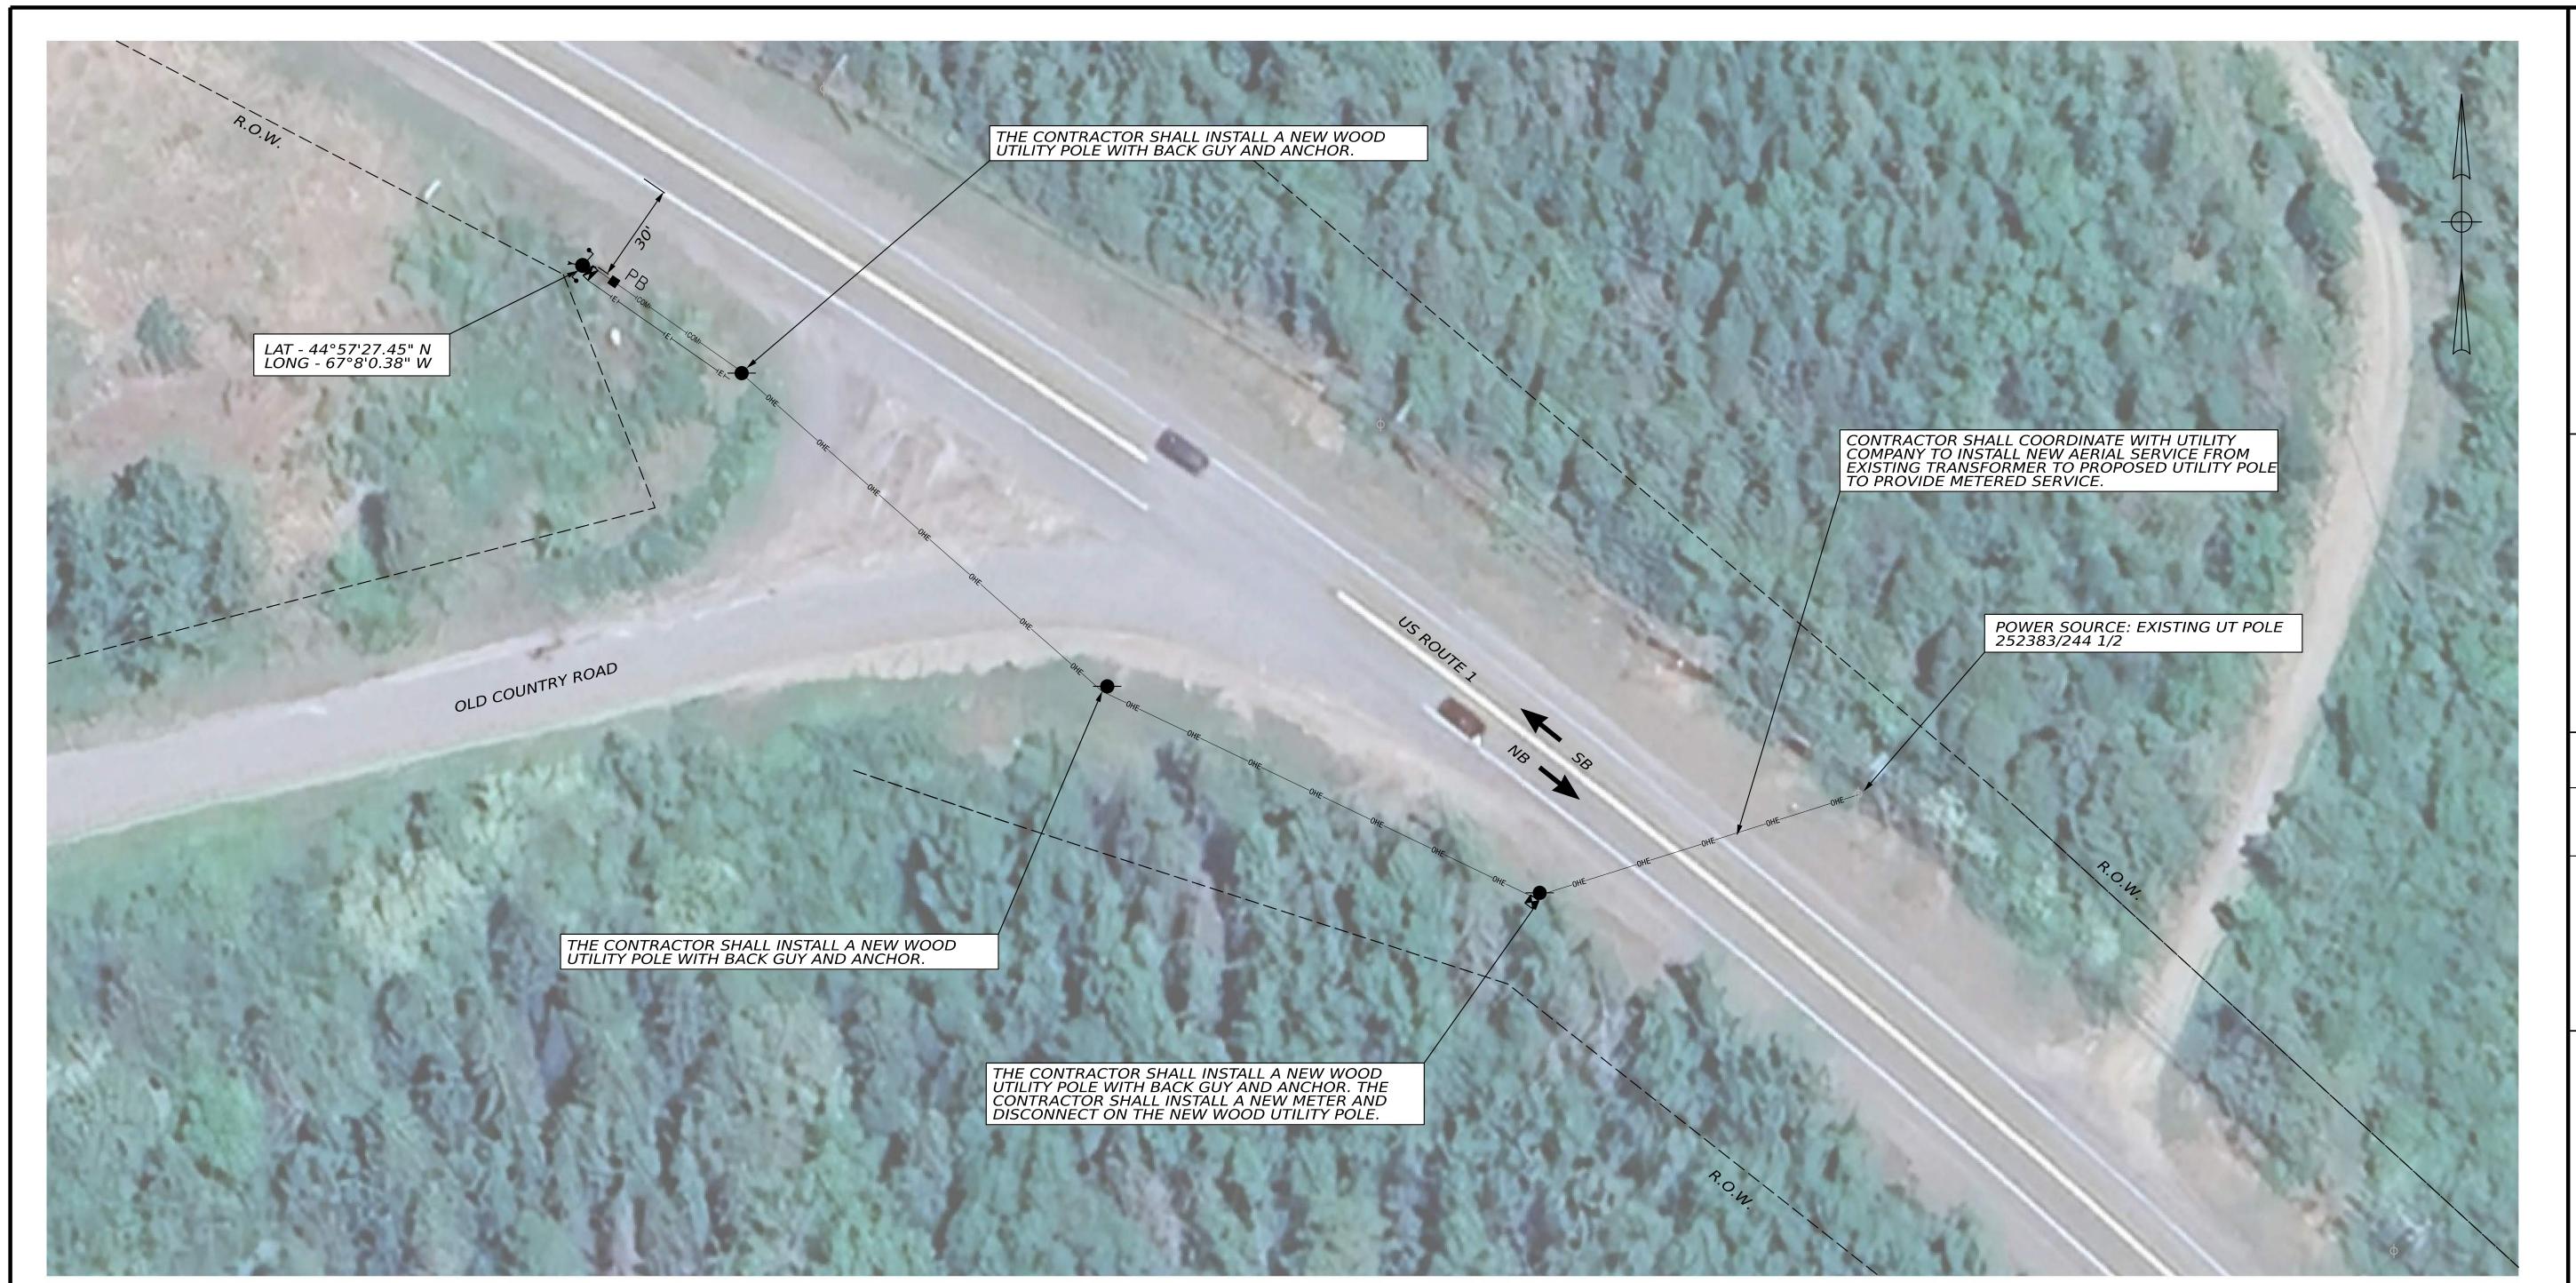

ITEM NO.	EQUIPMENT AND WORK ITEMS	QUANTITY
626.11	PRECAST CONCRETE JUNCTION BOX	1 EA
626.21	METALLIC CONDUIT (2-INCH)	15 LF
626.21	METALLIC CONDUIT (3-INCH)	15 LF
626.22	NON-METALLIC CONDUIT (2-INCH)	60 LF
626.22	NON-METALLIC CONDUIT (3-INCH)	60 LF
643.972	WOOD POLE	4 EA
654.51	ELECTRICAL SERVICE CONNECTION: PERRY	1 LS
654.531	MICRO-CLIMATE ROAD WEATHER INFORMATION SYSTEM: PERRY	1 EA


## **NOTES:**

- 1. THE CONTRACTOR SHALL INSTALL THE RWIS SENSORS PER THE MANUFACTURER'S RECOMMENDATIONS.
- 2. THE CONTRACTOR SHALL PROVIDE A METAL CONDUIT RISER ON THE PROPOSED UTILITY POLE FOR SECONDARY POWER SERVICE CONNECTION THAT EXTENDS A MINIMUM OF 7' ABOVE GRADE.
- 3. THE CONTRACTOR SHALL PROVIDE A SECOND METAL CONDUIT RISER ON THE PROPOSED UTILITY POLE FOR FUTURE COMMUNICATION CONNECTION.

\* - RIGHT-OF-WAY INFORMATION FROM FEDERAL PROJECT F 5(3), DATED JANUARY 1950.

0 25 50 1" = 25'-0" SHEET NUMBER

8

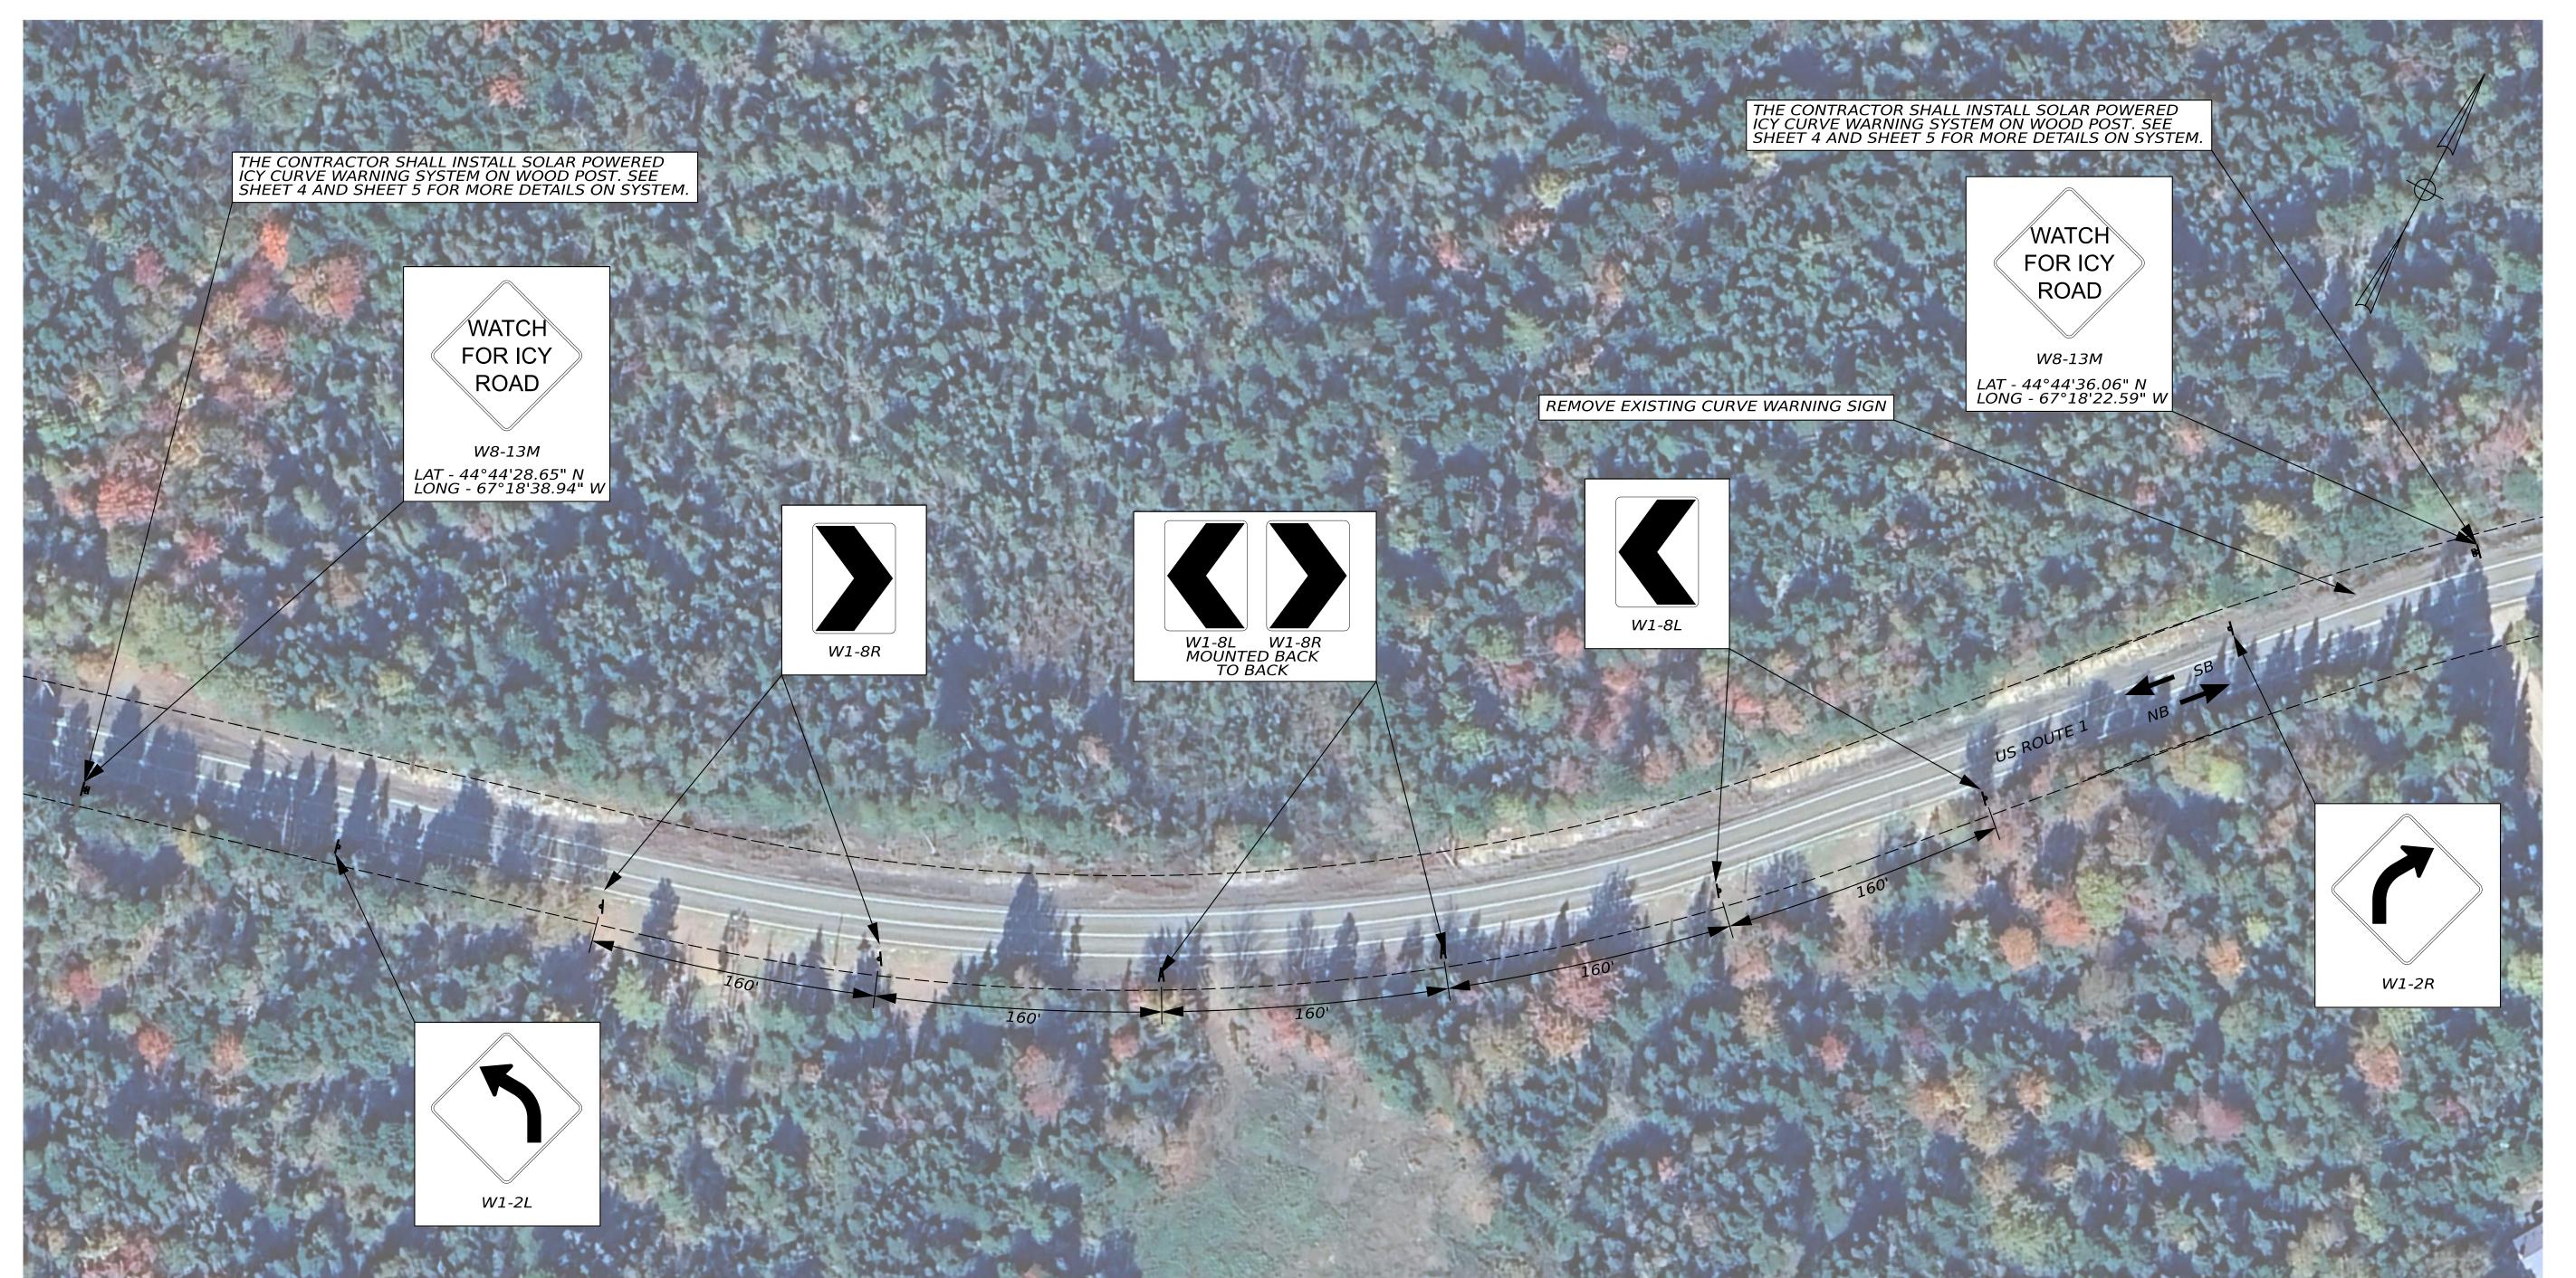

	ITEM NO.	EQUIPMENT AND WORK ITEMS	QUANTI
	645.106	DEMOUNT REGULATORY, WARNING, CONFIRMATION, AND ROUTE MARKER ASSEMBLY SIGN	1 EA
	645.292	REGULATORY, WARNING, CONFIRMATION AND ROUTE MARKER ASSEMBLY SIGNS TYPE II	42 SF
	654.61	ACTUATED CURVE WARNING SYSTEM: WHITING 1	1 LS
•			

NOTES:


1. SIGNS SHALL BE INSTALLED A MINIMUM OF 6'-0" FROM EDGE OF PAVEMENT OR AS DIRECTED BY THE RESIDENT.

2. CURVE WARNING SIGN UPGRADE LOCATION: US ROUTE 1 BEGIN MILE POINT 264.71 TO END MILE POINT 264.85.

\* - RIGHT-OF-WAY INFORMATION FROM STATE HIGHWAY PROJECT #99-G, DATED SEPTEMBER 1934.

0 50 100 1" = 50'-0" SHEET NUMBER


9

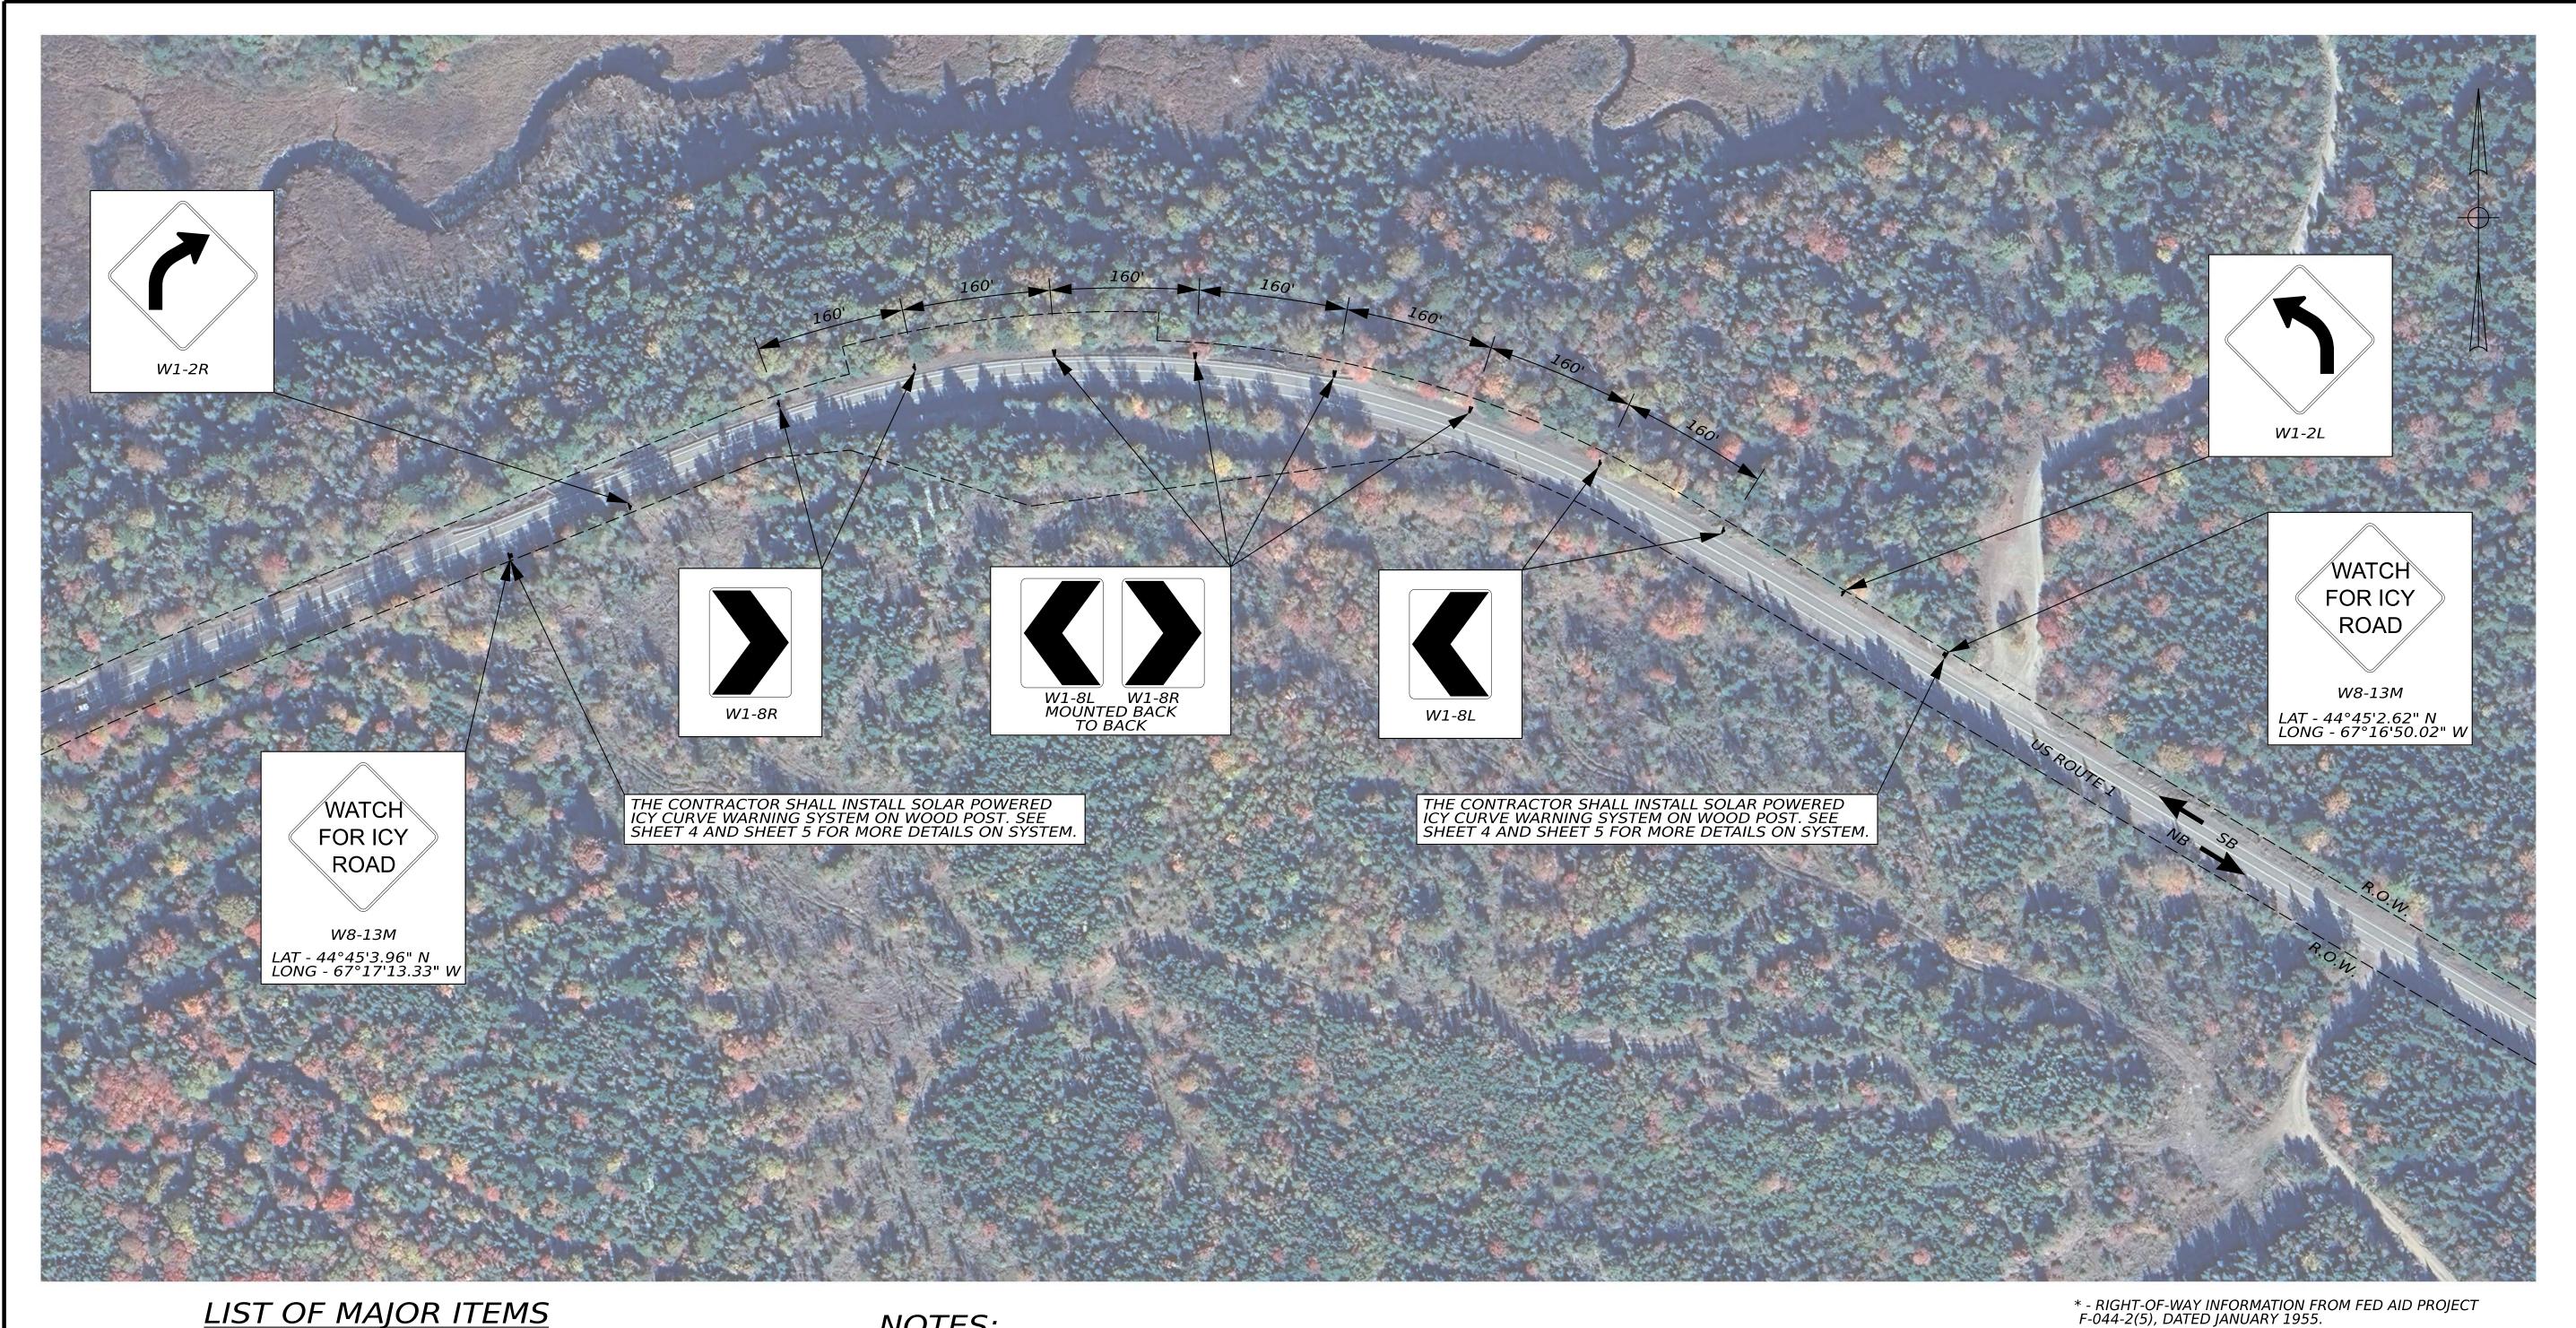


ITEM NO.	EQUIPMENT AND WORK ITEMS	QUANTITY
645.292	REGULATORY, WARNING, CONFIRMATION AND ROUTE MARKER ASSEMBLY SIGNS TYPE II	54 SF
654.61	ACTUATED CURVE WARNING SYSTEM: WHITING 2	1 LS

## NOTES:

- SIGNS SHALL BE INSTALLED A MINIMUM OF 6'-0" FROM EDGE OF PAVEMENT OR AS DIRECTED BY THE RESIDENT.
- CURVE WARNING SIGN UPGRADE LOCATION: US ROUTE 1 BEGIN MILE POINT 266.09 TO END MILE POINT 266.24.

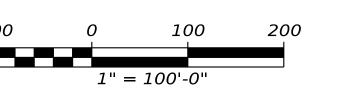

SHEET NUMBER

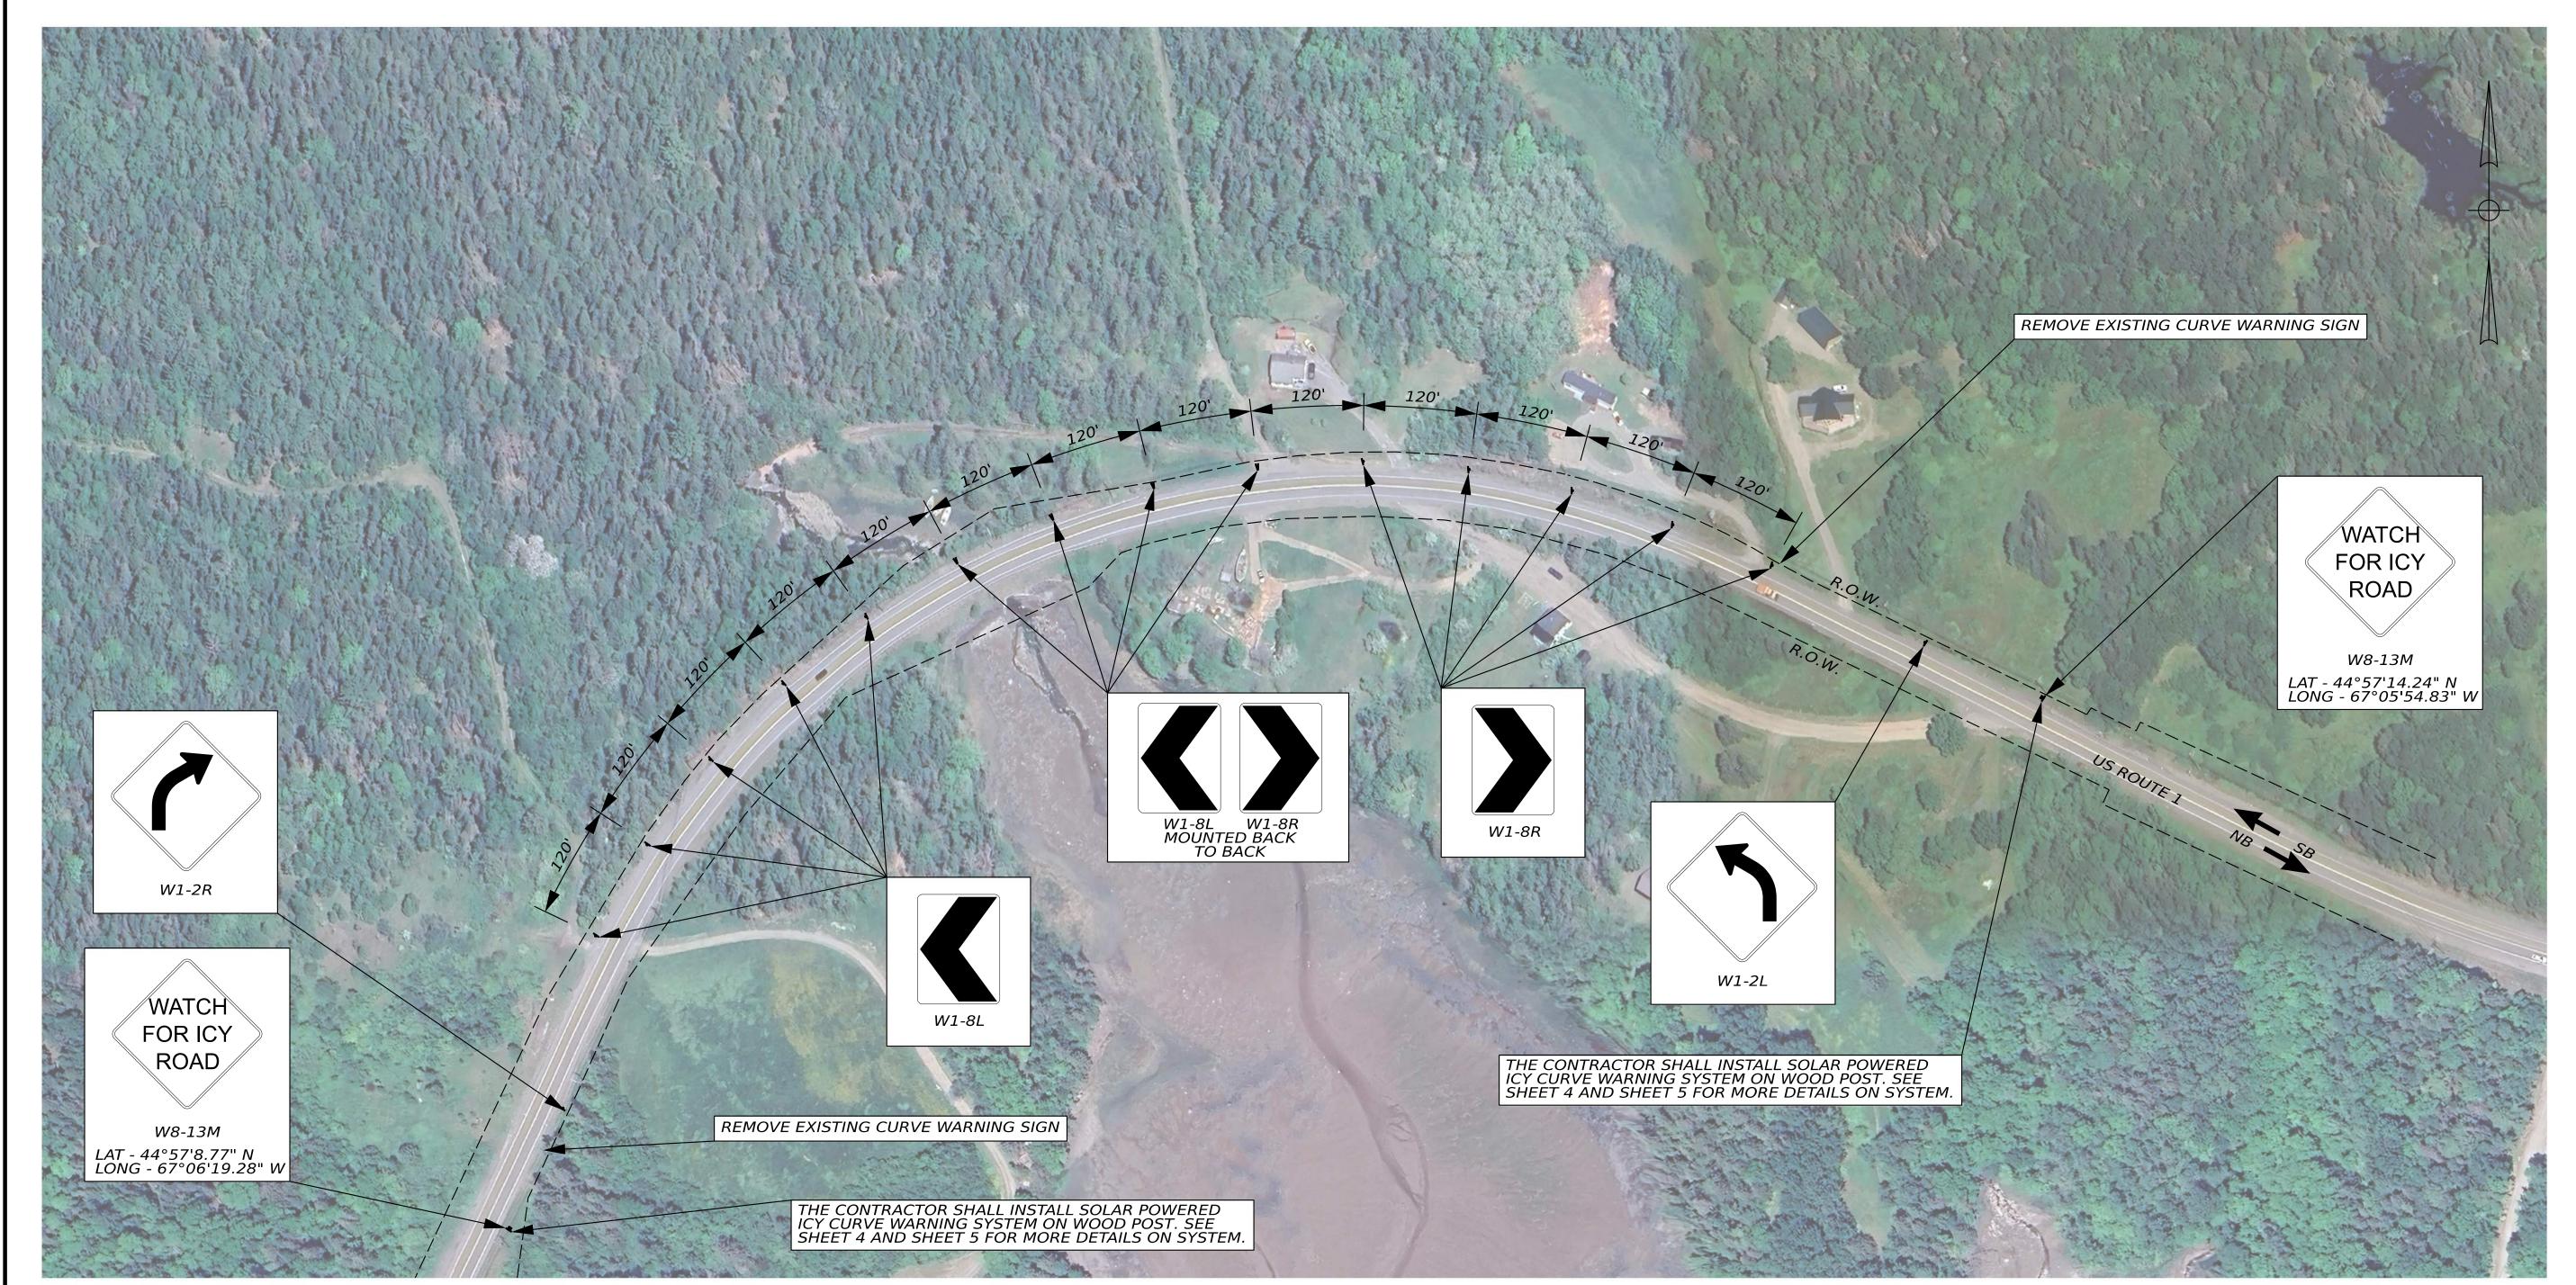

ITEM NO.	EQUIPMENT AND WORK ITEMS	QUANTI
645.106	DEMOUNT REGULATORY, WARNING, CONFIRMATION, AND ROUTE MARKER ASSEMBLY SIGN	2 EA
645.292	REGULATORY, WARNING, CONFIRMATION AND ROUTE MARKER ASSEMBLY SIGNS TYPE II	72 SF
654.61	ACTUATED CURVE WARNING SYSTEM: PERRY 1	1 LS

NOTES:

1. SIGNS SHALL BE INSTALLED A MINIMUM OF 6'-0" FROM EDGE OF PAVEMENT OR AS DIRECTED BY THE RESIDENT.


2. CURVE WARNING SIGN UPGRADE LOCATION: US ROUTE 1 BEGIN MILE POINT 291.02 TO END MILE POINT 291.23

\* - RIGHT-OF-WAY INFORMATION FROM FEDERAL AID NO F-FG-044-2(23), DATED APRIL 1985.

1" = 100'-0"

SHEET NUMBER

11

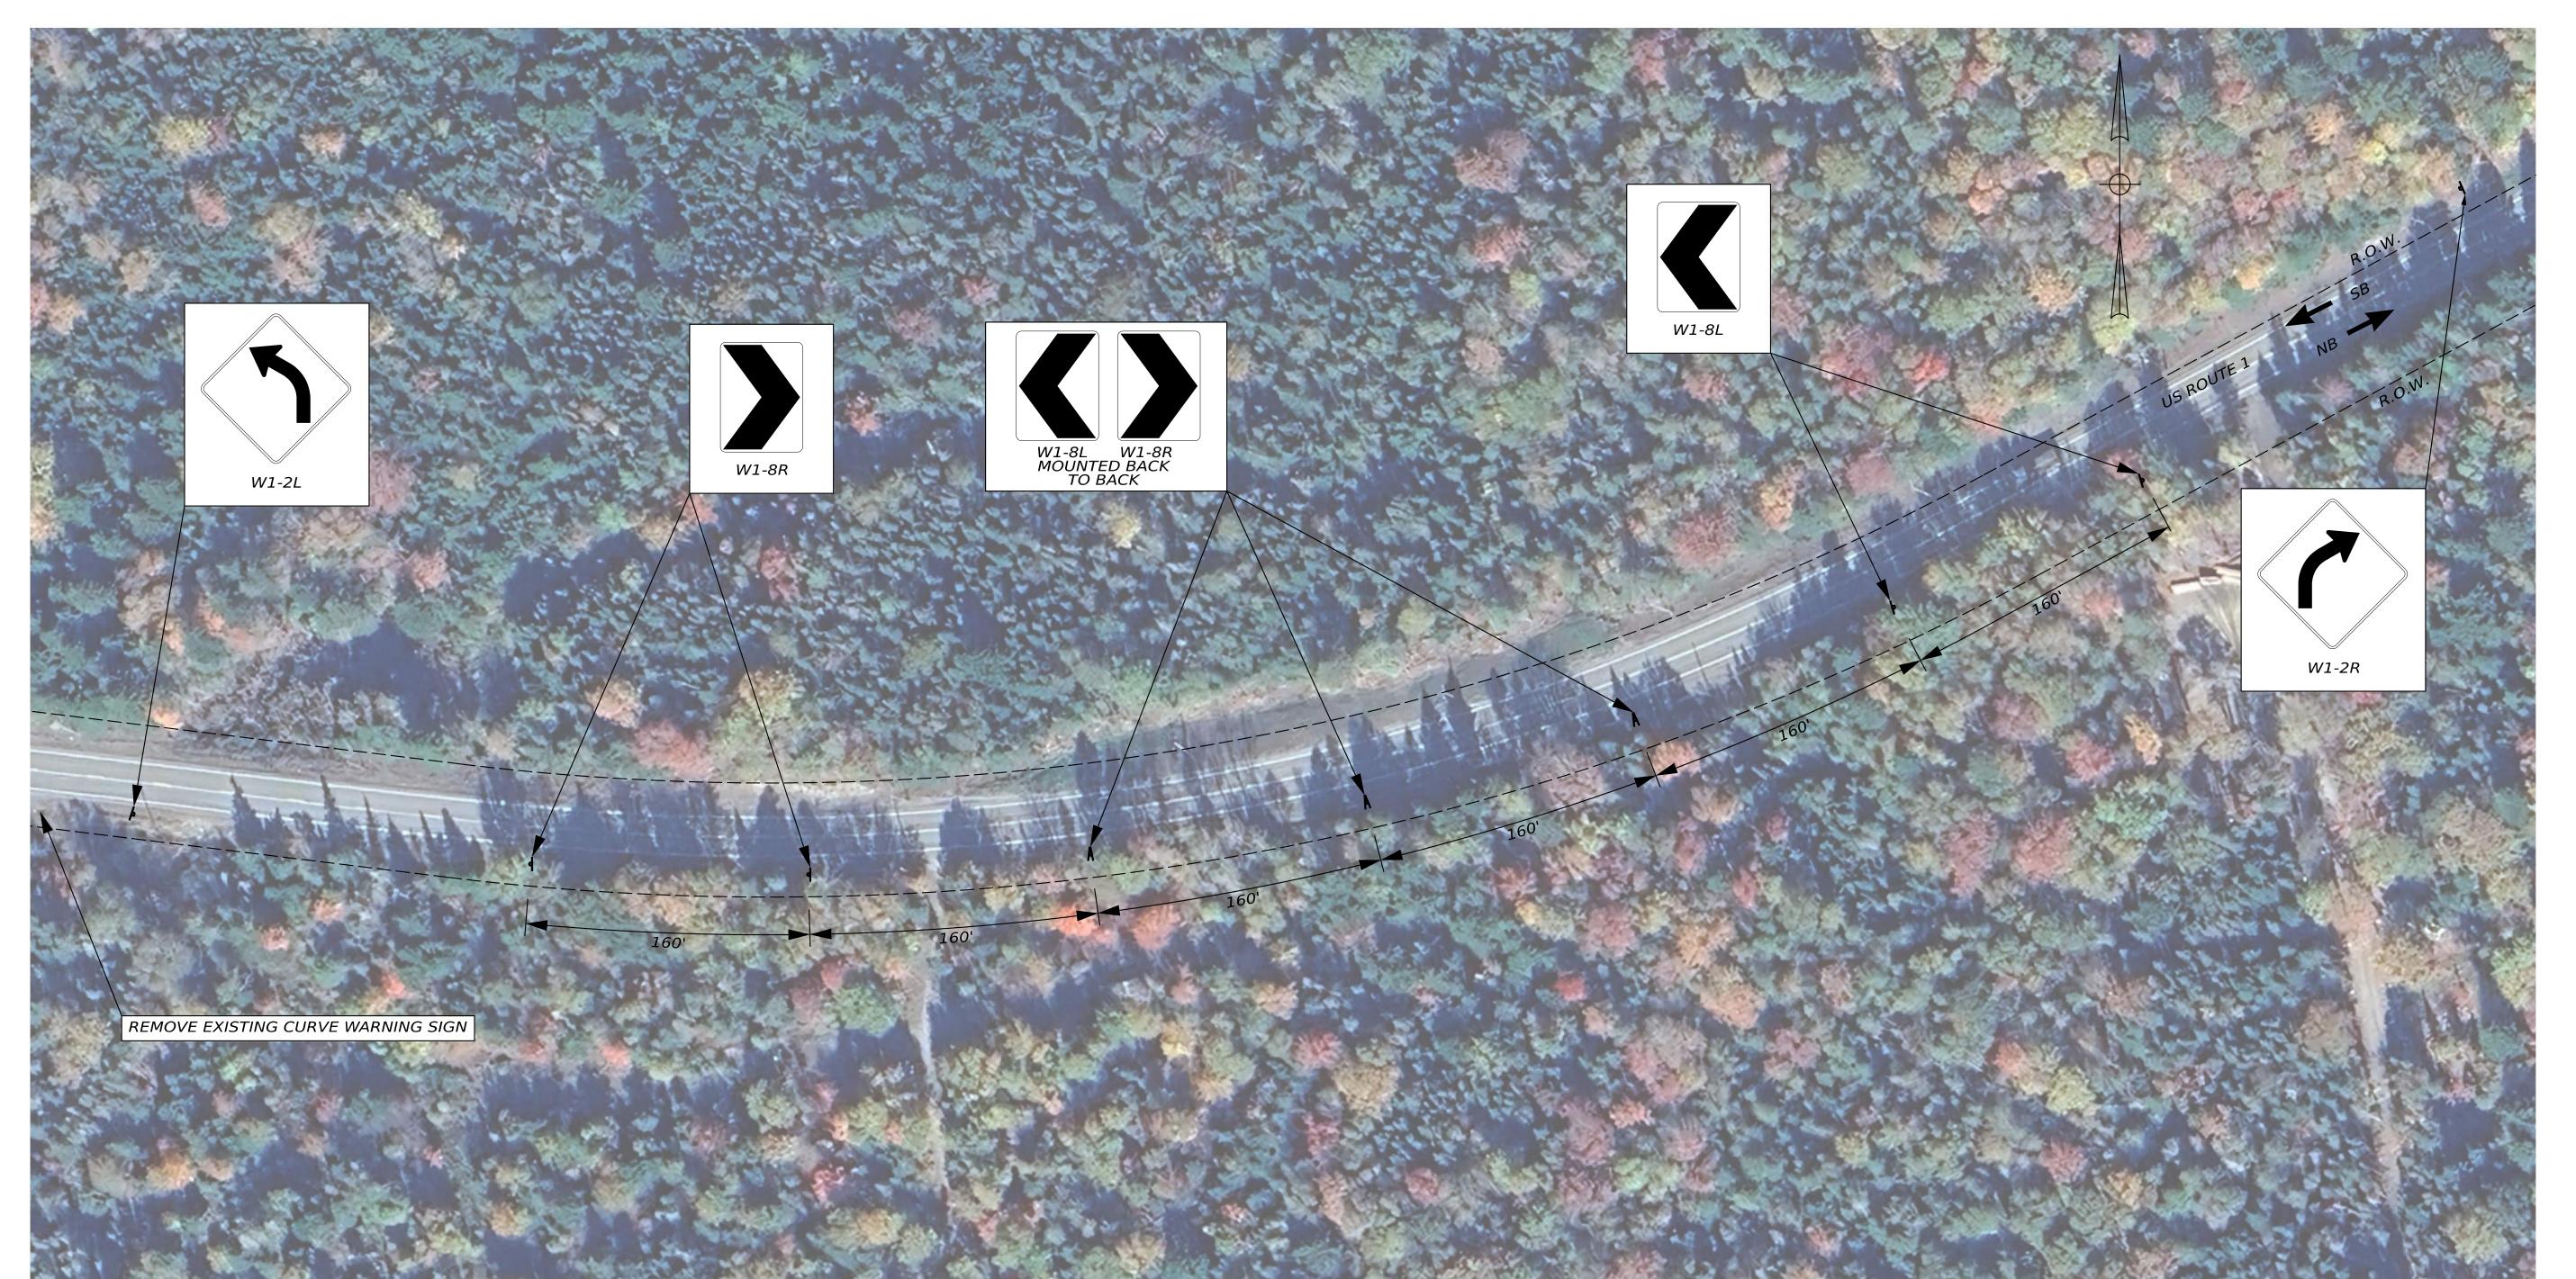

ITEM NO.	EQUIPMENT AND WORK ITEMS	QUANTIT
645.106	DEMOUNT REGULATORY, WARNING, CONFIRMATION, AND ROUTE MARKER ASSEMBLY SIGN	1 EA
645.292	REGULATORY, WARNING, CONFIRMATION AND ROUTE MARKER ASSEMBLY SIGNS TYPE II	48 SF

<u>NOTES:</u>


1. SIGNS SHALL BE INSTALLED A MINIMUM OF 6'-0" FROM EDGE OF PAVEMENT OR AS DIRECTED BY THE RESIDENT.

2. CURVE WARNING SIGN UPGRADE LOCATION: US ROUTE 1 BEGIN MILE POINT 264.02 TO END MILE POINT 264.18.

\* - RIGHT-OF-WAY INFORMATION FROM STATE HIGHWAY PROJECT #99-G, DATED SEPTEMBER 1934.

0 50 100 1" = 50'-0" SHEET NUMBER

12

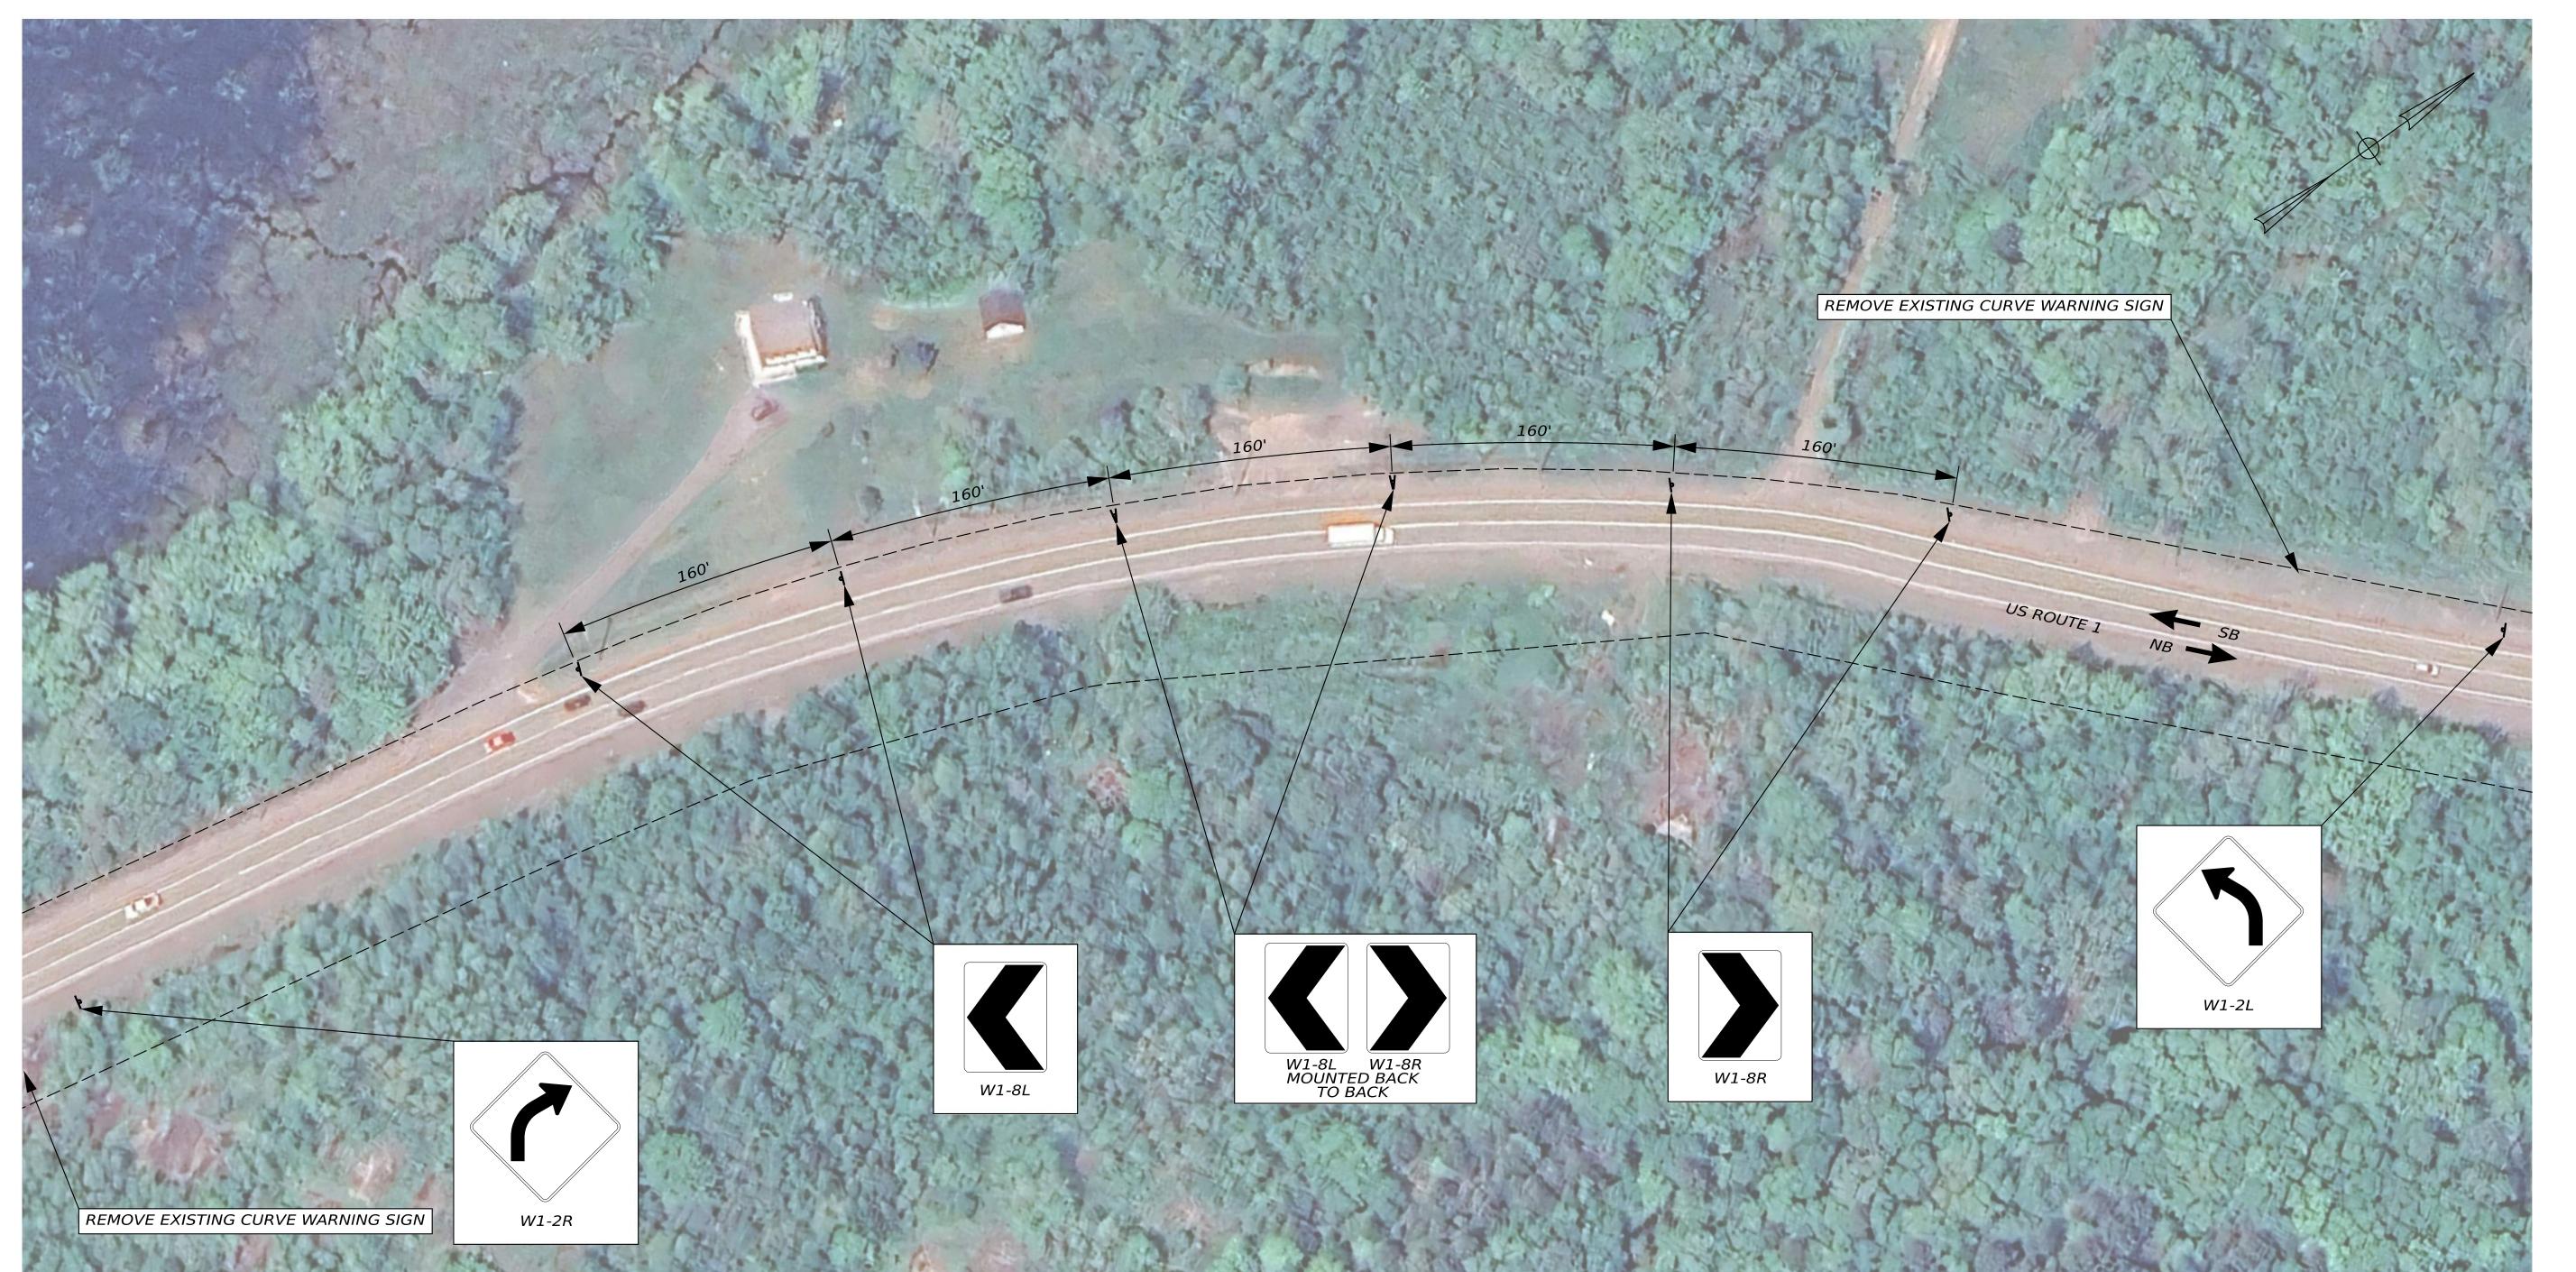

ITEM NO.	EQUIPMENT AND WORK ITEMS	QUANTITY
645.106	DEMOUNT REGULATORY, WARNING, CONFIRMATION, AND ROUTE MARKER ASSEMBLY SIGN	26 EA
645.292	REGULATORY, WARNING, CONFIRMATION AND ROUTE MARKER ASSEMBLY SIGNS TYPE II	42 SF

NOTES:

1. SIGNS SHALL BE INSTALLED A MINIMUM OF 6'-0" FROM EDGE OF PAVEMENT OR AS DIRECTED BY THE RESIDENT.


2. THE CONTRACTOR SHALL REMOVE 24 EXISTING OBJECT MARKER SIGNS THAT ARE EXISTING ALONG THE WEST SIDE OF US ROUTE 1 THROUGH THE CURVE.

3. CURVE WARNING SIGN UPGRADE LOCATION: US ROUTE 1 BEGIN MILE POINT 271.57 TO END MILE POINT 271.75.

\* - RIGHT-OF-WAY INFORMATION FROM FED AID PROJECT F-044-2(5), DATED JANUARY 1955.

0 50 100 1" = 50'-0" SHEET NUMBER

13

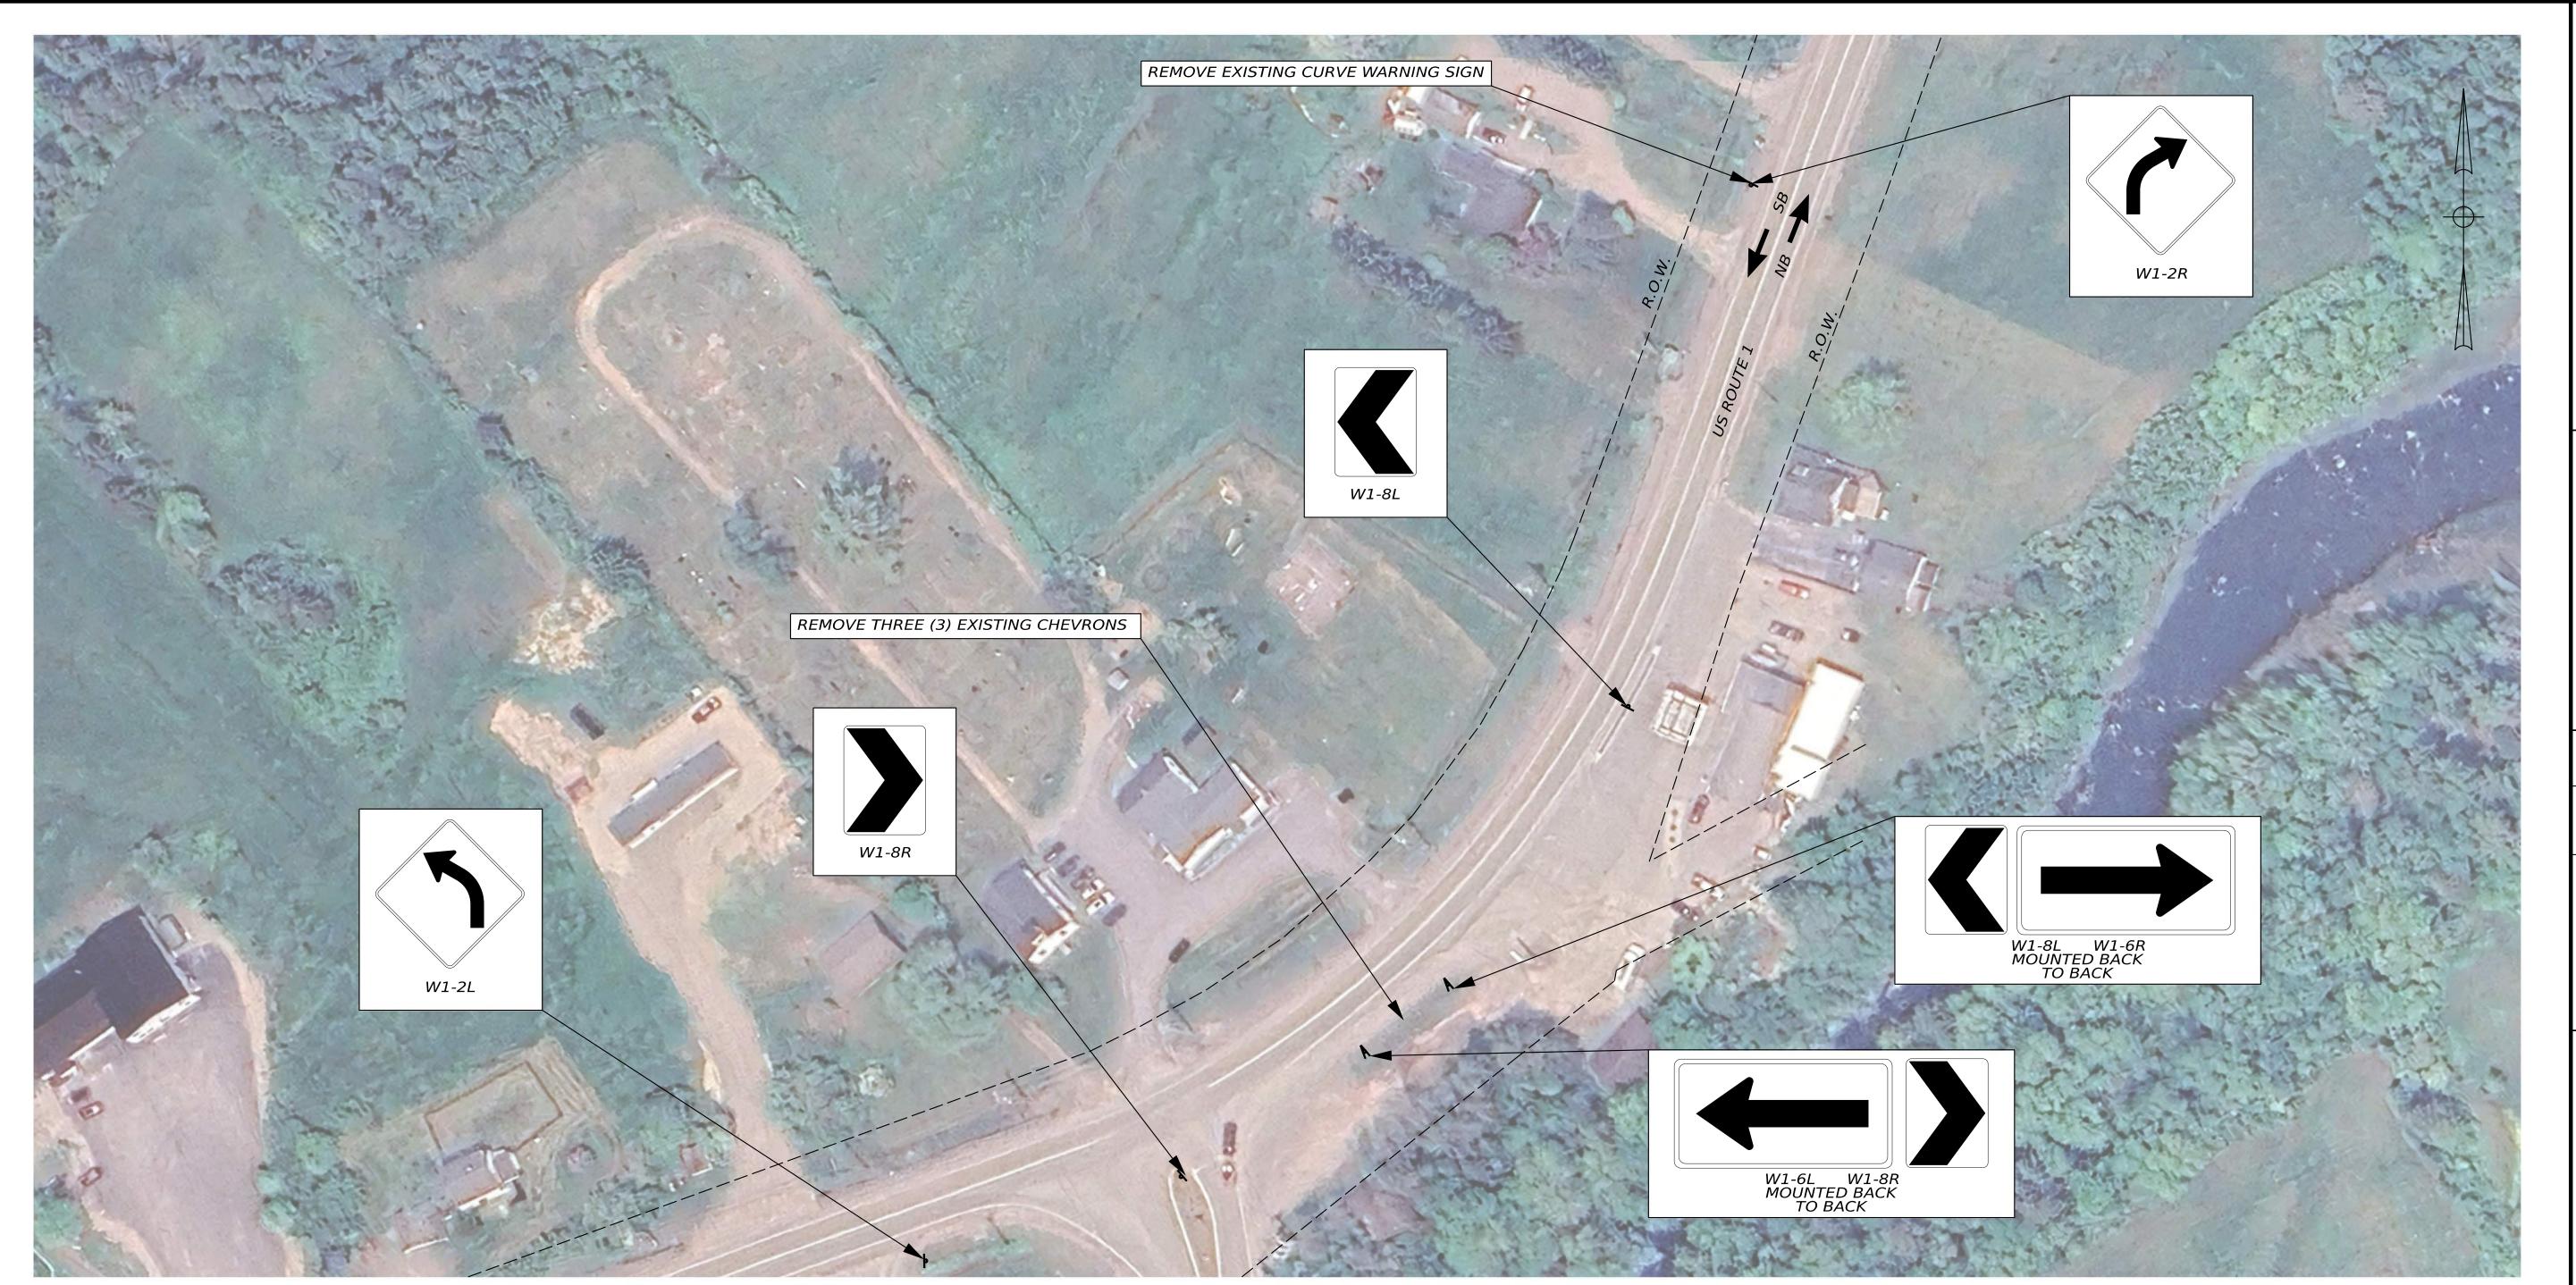

ITEM NO.	EQUIPMENT AND WORK ITEMS	QUANTITY
645.106	DEMOUNT REGULATORY, WARNING, CONFIRMATION, AND ROUTE MARKER ASSEMBLY SIGN	4 EA
645.292	REGULATORY, WARNING, CONFIRMATION AND ROUTE MARKER ASSEMBLY SIGNS TYPE II	46 SF


## NOTES:

- 1. SIGNS SHALL BE INSTALLED A MINIMUM OF 6'-0" FROM EDGE OF PAVEMENT OR AS DIRECTED BY THE RESIDENT.
- 2. CURVE WARNING SIGN UPGRADE LOCATION: US ROUTE 1 BEGIN MILE POINT 272.86 TO END MILE POINT 272.96.

\* - RIGHT-OF-WAY INFORMATION FROM FED AID PROJECT F-044-2(5), DATED JANUARY 1955.

0 50 100 1" = 50'-0" SHEET NUMBER

14

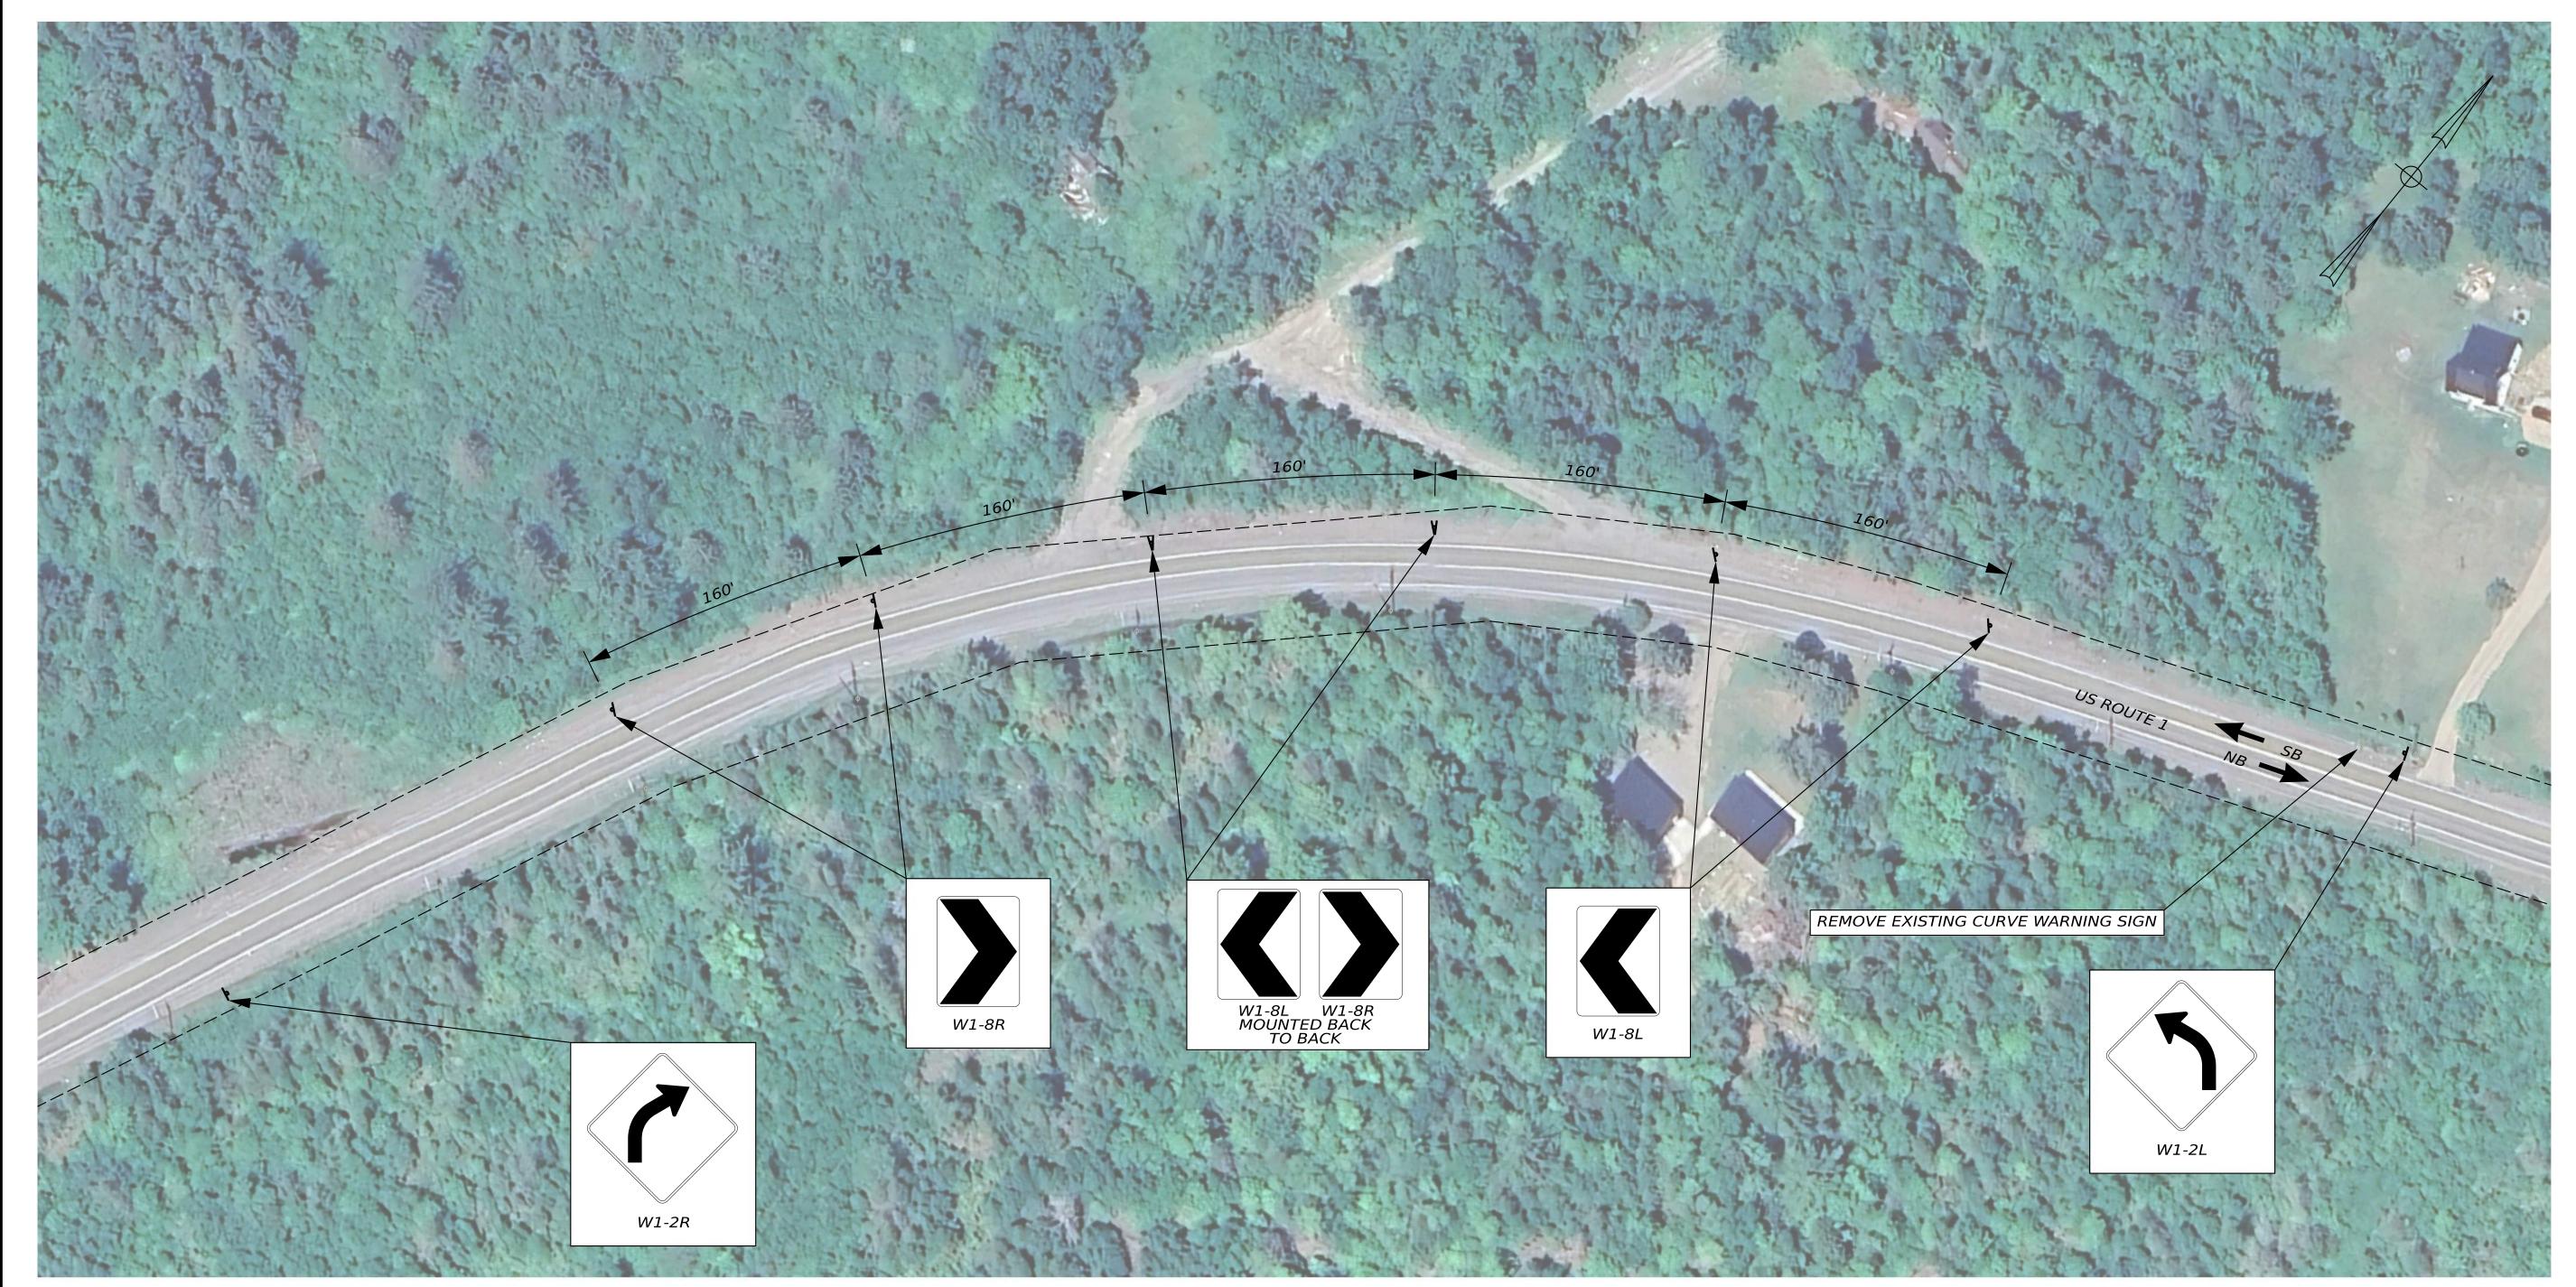

ITEM NO.	EQUIPMENT AND WORK ITEMS	QUANTITY
645.106	DEMOUNT REGULATORY, WARNING, CONFIRMATION, AND ROUTE MARKER ASSEMBLY SIGN	1 EA
645.292	REGULATORY, WARNING, CONFIRMATION AND ROUTE MARKER ASSEMBLY SIGNS TYPE II	42 SF

NOTES:


1. SIGNS SHALL BE INSTALLED A MINIMUM OF 6'-0" FROM EDGE OF PAVEMENT OR AS DIRECTED BY THE RESIDENT.

2. CURVE WARNING SIGN UPGRADE LOCATION: US ROUTE 1 BEGIN MILE POINT 284.36 TO END MILE POINT 284.50.

\* - RIGHT-OF-WAY INFORMATION FROM FEDERAL AID PROJECT NO 123-D, DATED AUGUST 1937.

0 50 100 1" = 50'-0" SHEET NUMBER

15

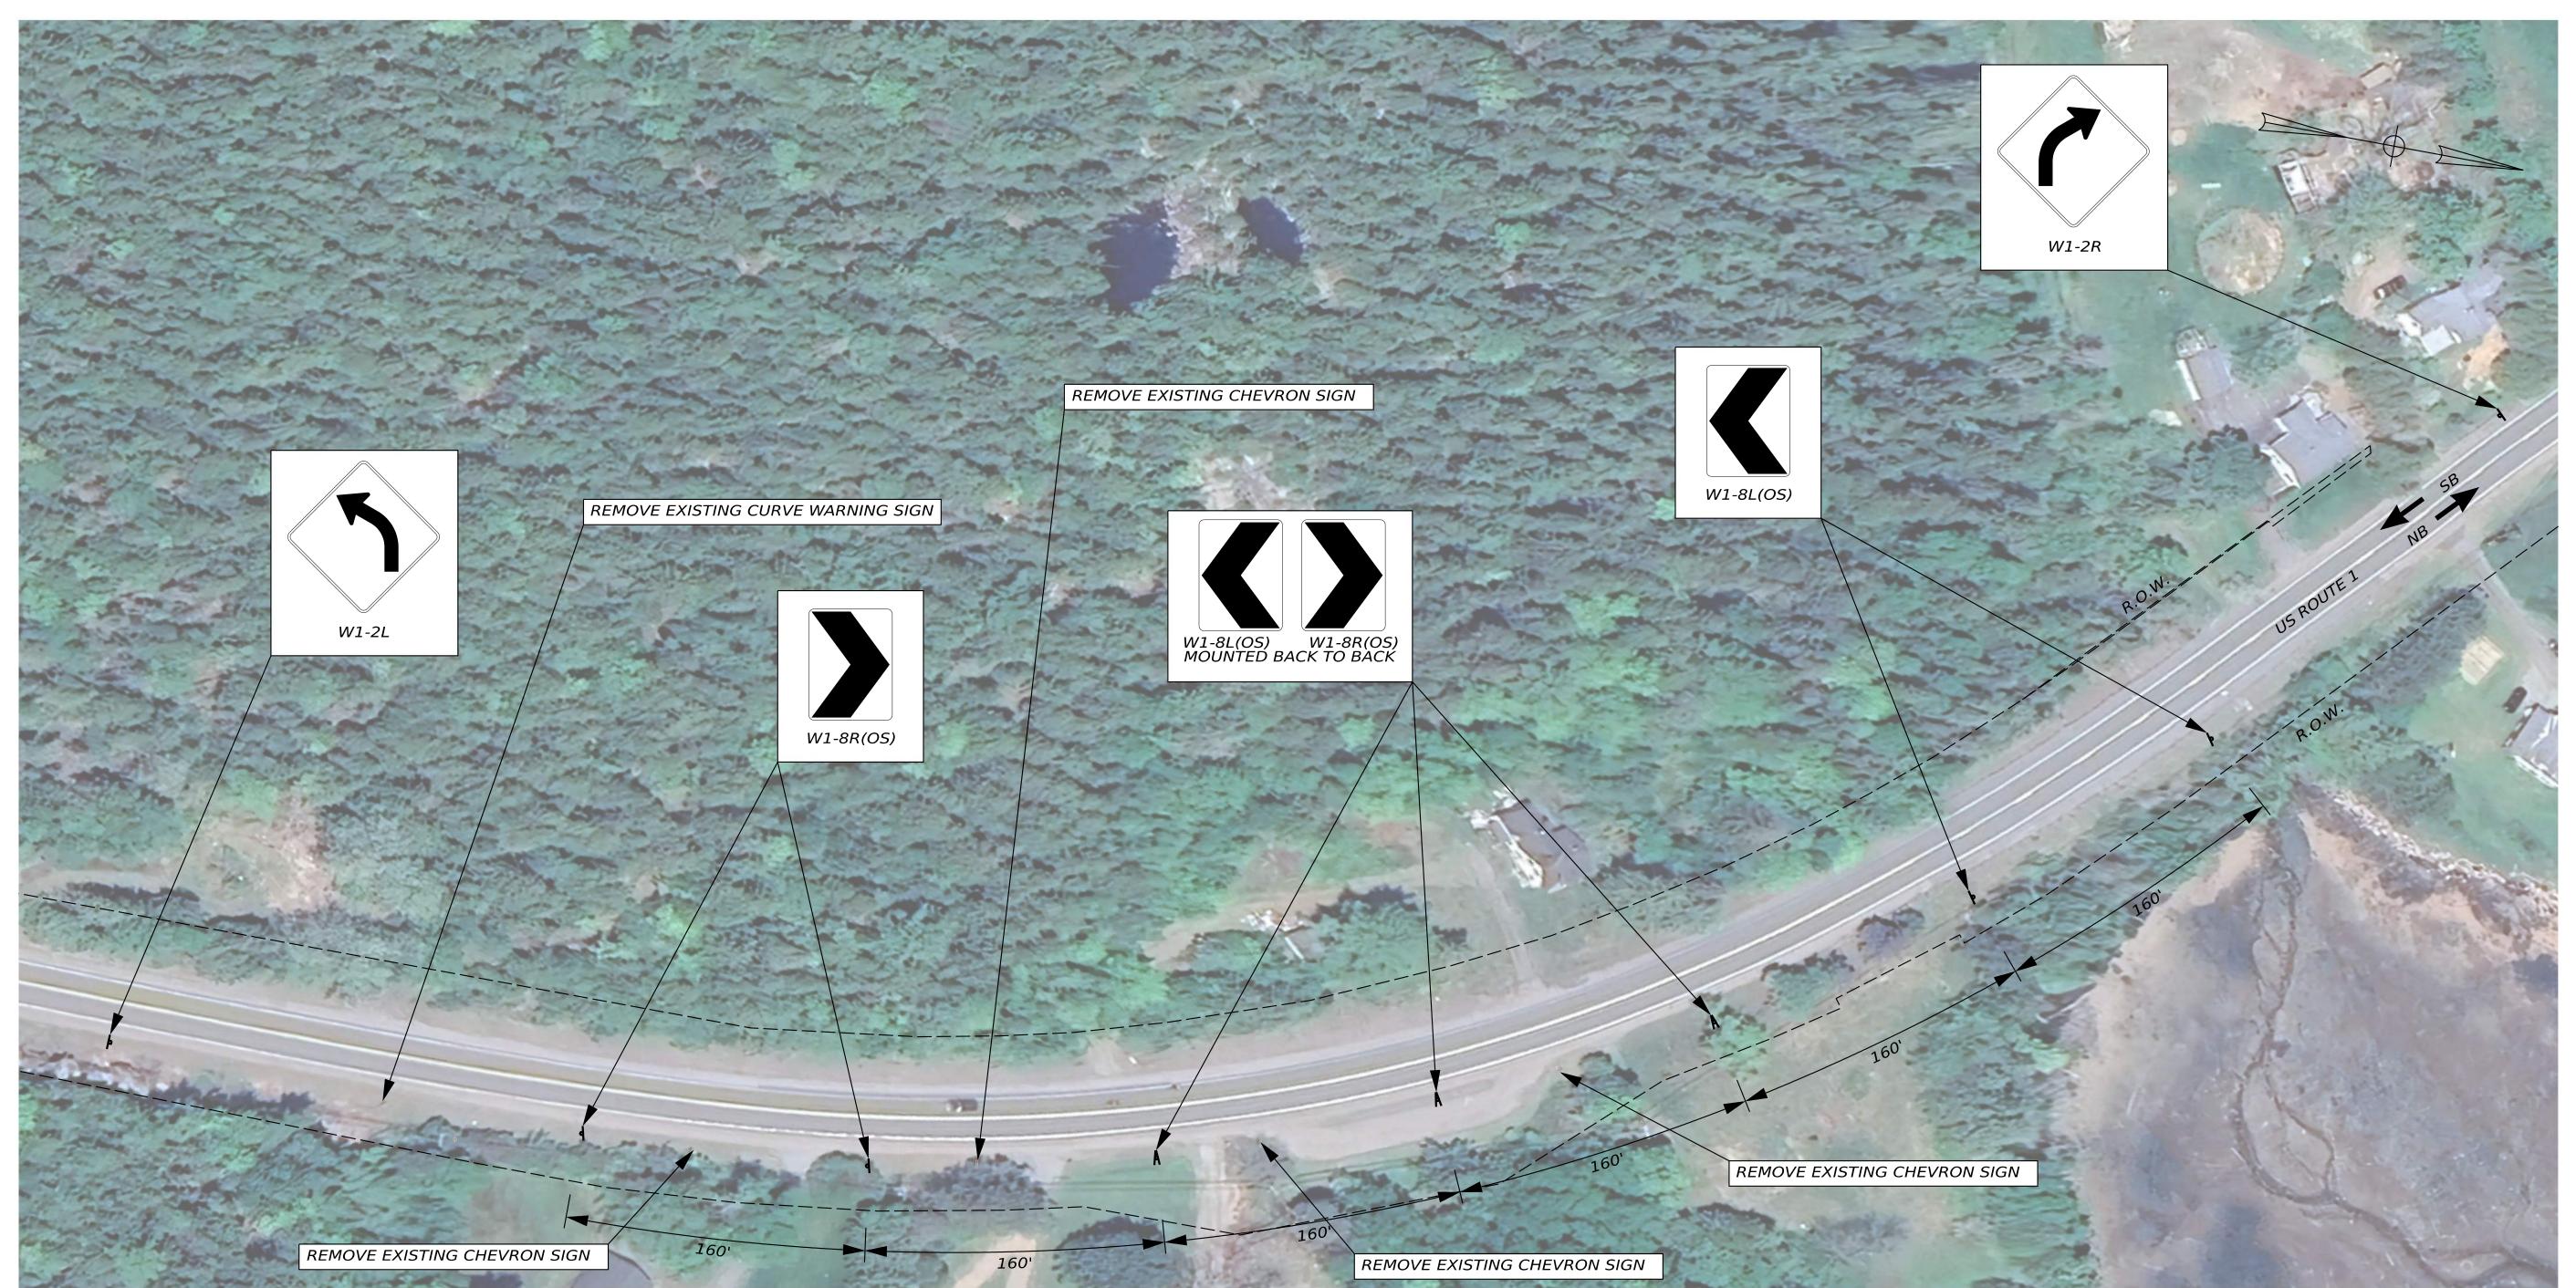

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	ITEM NO.	EQUIPMENT AND WORK ITEMS	QUANTITY
	645.106	DEMOUNT REGULATORY, WARNING, CONFIRMATION, AND ROUTE MARKER ASSEMBLY SIGN	5 EA
	645.292	REGULATORY, WARNING, CONFIRMATION AND ROUTE MARKER ASSEMBLY SIGNS TYPE II	78 SF

<u>NOTES:</u>


1. SIGNS SHALL BE INSTALLED A MINIMUM OF 6'-0" FROM EDGE OF PAVEMENT OR AS DIRECTED BY THE RESIDENT.

2. CURVE WARNING SIGN UPGRADE LOCATION: US ROUTE 1 BEGIN MILE POINT 305.80 TO END MILE POINT 305.97.

\* - RIGHT-OF-WAY INFORMATION FROM FEDERAL AID PROJECT NO F-044-2(11), DATED NOVEMBER 1963.

0 50 100 1" = 50'-0" SHEET NUMBER

16

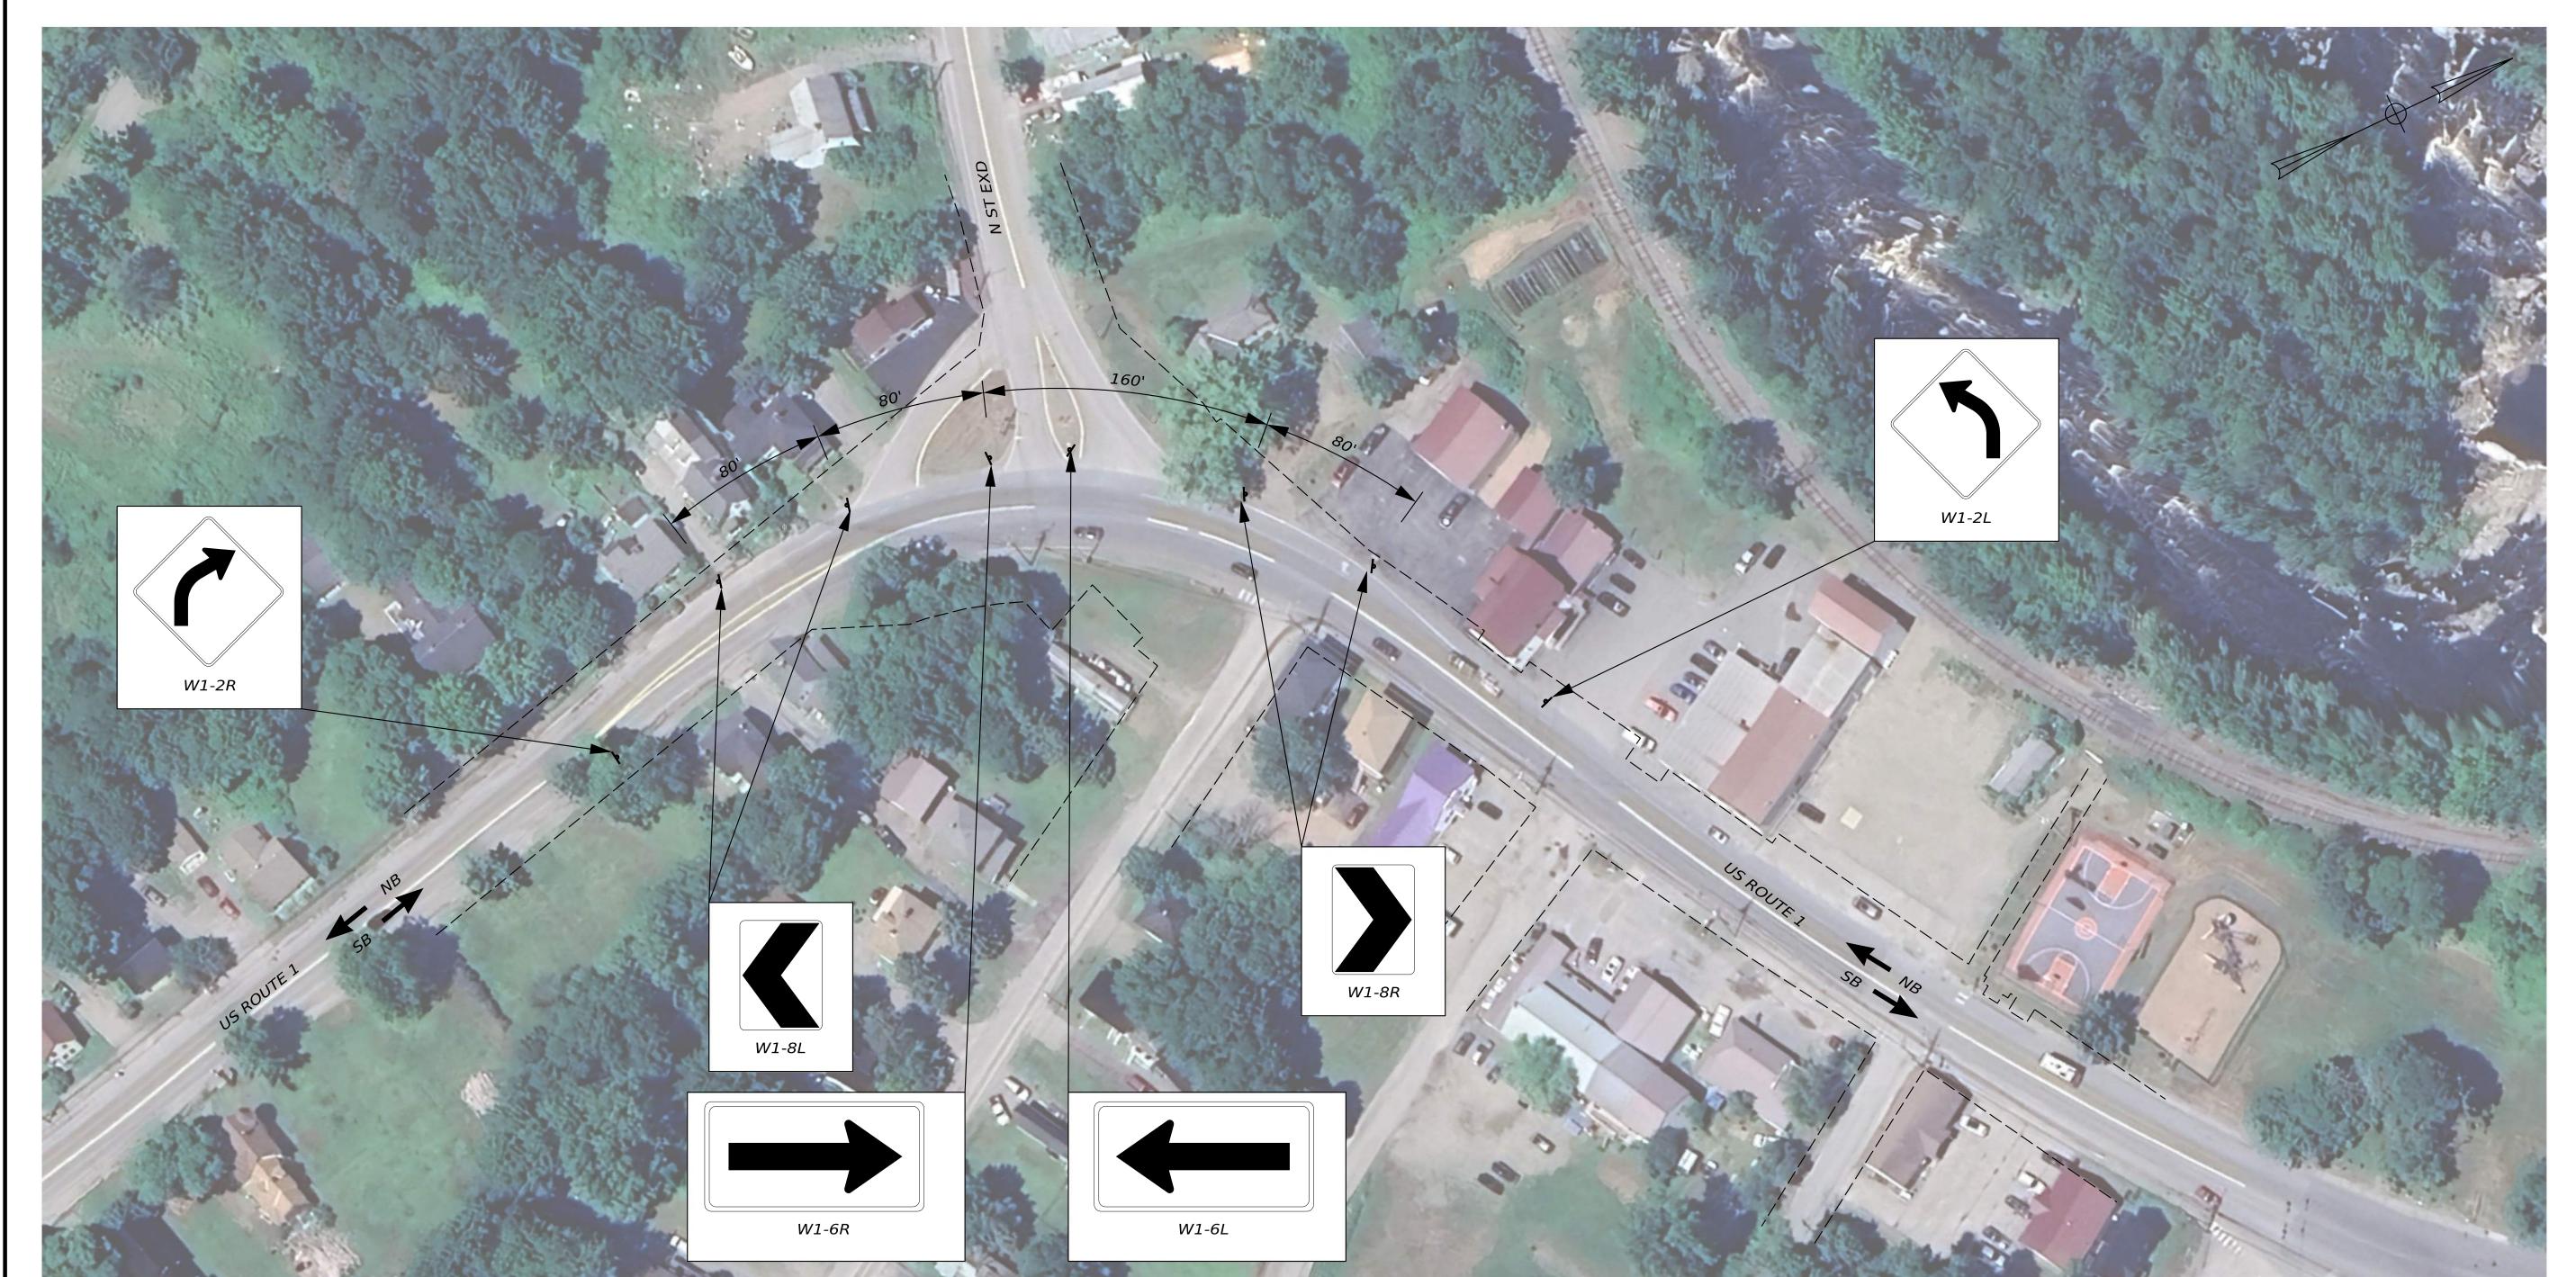

ITEM NO.	EQUIPMENT AND WORK ITEMS	QUANTITY
645.292	REGULATORY, WARNING, CONFIRMATION AND ROUTE MARKER ASSEMBLY SIGNS TYPE II	46 SF

NOTES:

1. SIGNS SHALL BE INSTALLED A MINIMUM OF 6'-0" FROM EDGE OF PAVEMENT OR AS DIRECTED BY THE RESIDENT.

2. CURVE WARNING SIGN UPGRADE LOCATION: US ROUTE 1 BEGIN MILE POINT 315.44 TO END MILE POINT 315.51.

\* - RIGHT-OF-WAY INFORMATION FROM FEDERAL AID PROJECT NO F-046-1(6), DATED FEBRUARY 1966.

0 50 100 1" = 50'-0" SHEET NUMBER

17