MAINE BUREAU OF PARKS AND LANDS

PROJECT MANUAL Appendix A, B, and C **FLOAT PILE REPLACEMENT**

Chandler Bay and St Croix River Boat Launch Facilities,

Jonesport and Robbinston, Maine

BREM Project #3013

Issued for Bid - April 8, 2019

APPENDIX A

PLANS

Ionesport Site Location Plan

Sheet J1	Jonesport Site Location Plan
Sheet J2	Jonesport Plan
Sheet J3	Jonesport Pile Details
Sheet R1	Robbinston Site Location Plan
Sheet R2	Robbinston Plan and Profile
Sheet R3	Robbinston Pile Details

APPENDIX B Reference Documents for Robbinston


Photos of Existing Site

Record Drawings of Existing Site

APPENDIX C Reference Documents for Jonesport

Photos of Existing Site

Record Drawings of Existing Site

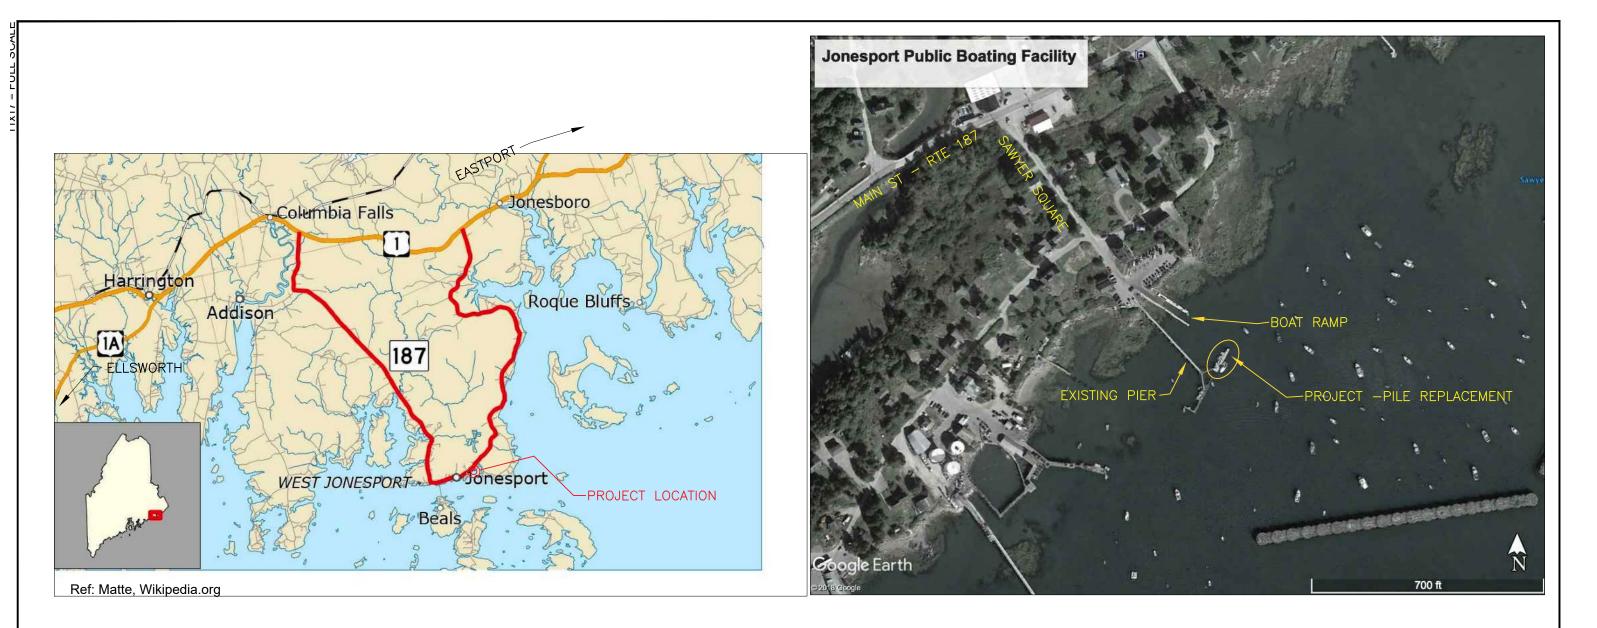


SITE LOCATION JONESPORT, MAINE

NO. REVISION DA 1111111111 OF International International TEPHE T. RUELL No. 4396

SITE LOCATION JONESPORT, MAINE

TE	DESIGNED BY STR	STATE OF MAIN	IE	
	DRAWN BY STR	BOATING FACILITIES PRO	ROGRAM	
	ont	FLOAT PILE REPLACE	MENT	
	BREM Project 3013	SITE LOCATION		
	DATE REVISED 3-4-2019	JONESPORT, MAII	NE	
	PINNACL	E HILL 33 Pinnacle Road	J-1	
	ENGINE	ERING Canaan, ME 04924	J-I REV. O	
	Pinnacle	REV. U		

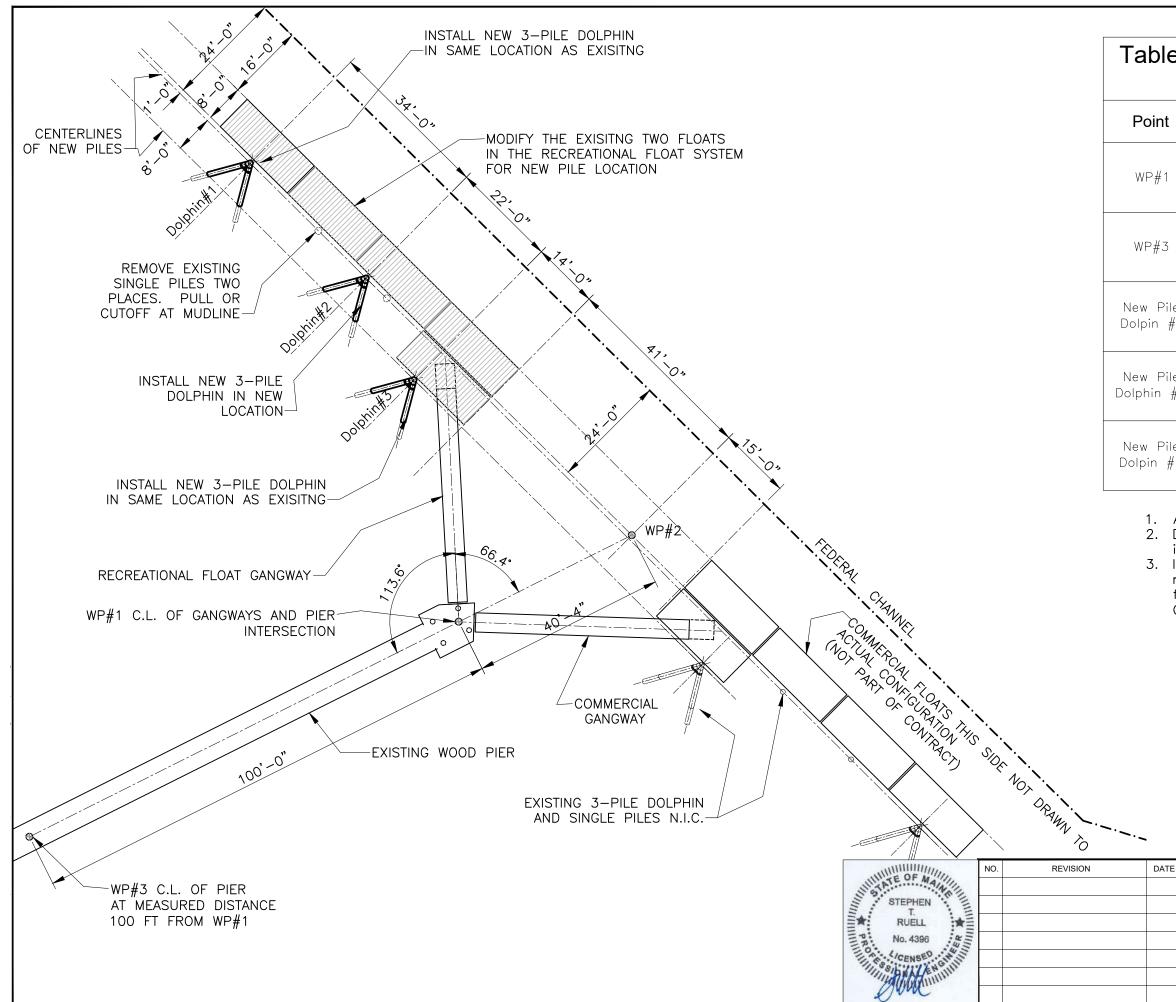


e of Dimensions for Locating Piles						
t	Distance from WP#1	Distance from WP#3				
1	_	100.00	Work Point on pier			
3	100.00	_	Work Point on Pier			
ile #1	105.04	147.58	Vertical pile centerline			
ile #2	74.14	135.77	Vertical pile centerline			
ile #3	51.26	124.31	Vertical pile centerline			


1. All dimensions in feet.

2. Dimensions are to centerline of plumb pile in each dolphin.

3. If obstructions prevent pile as located, move dolphin along centerline parallel to float, up to 2 feet maximum. Notify Owner/Engineer.

E	DESIGNED BY STR	STATE OF MA		
	DRAWN BY STR	BOATING FACILITIES P		
	BREM Project 3013	FLOAT PILE REPLACE		
	DATE REVISED 3-4-2019	CHANDLER BAY, JONES	PORT,MAINE	
	PINNACL	E HILL 33 Pinnacle Road	J-2	
	ENGINEE Pinnacle	Canaan, ME 04924 HillEngineering@gmail.com	G-Z REV. O	
		geogenetics and the second		

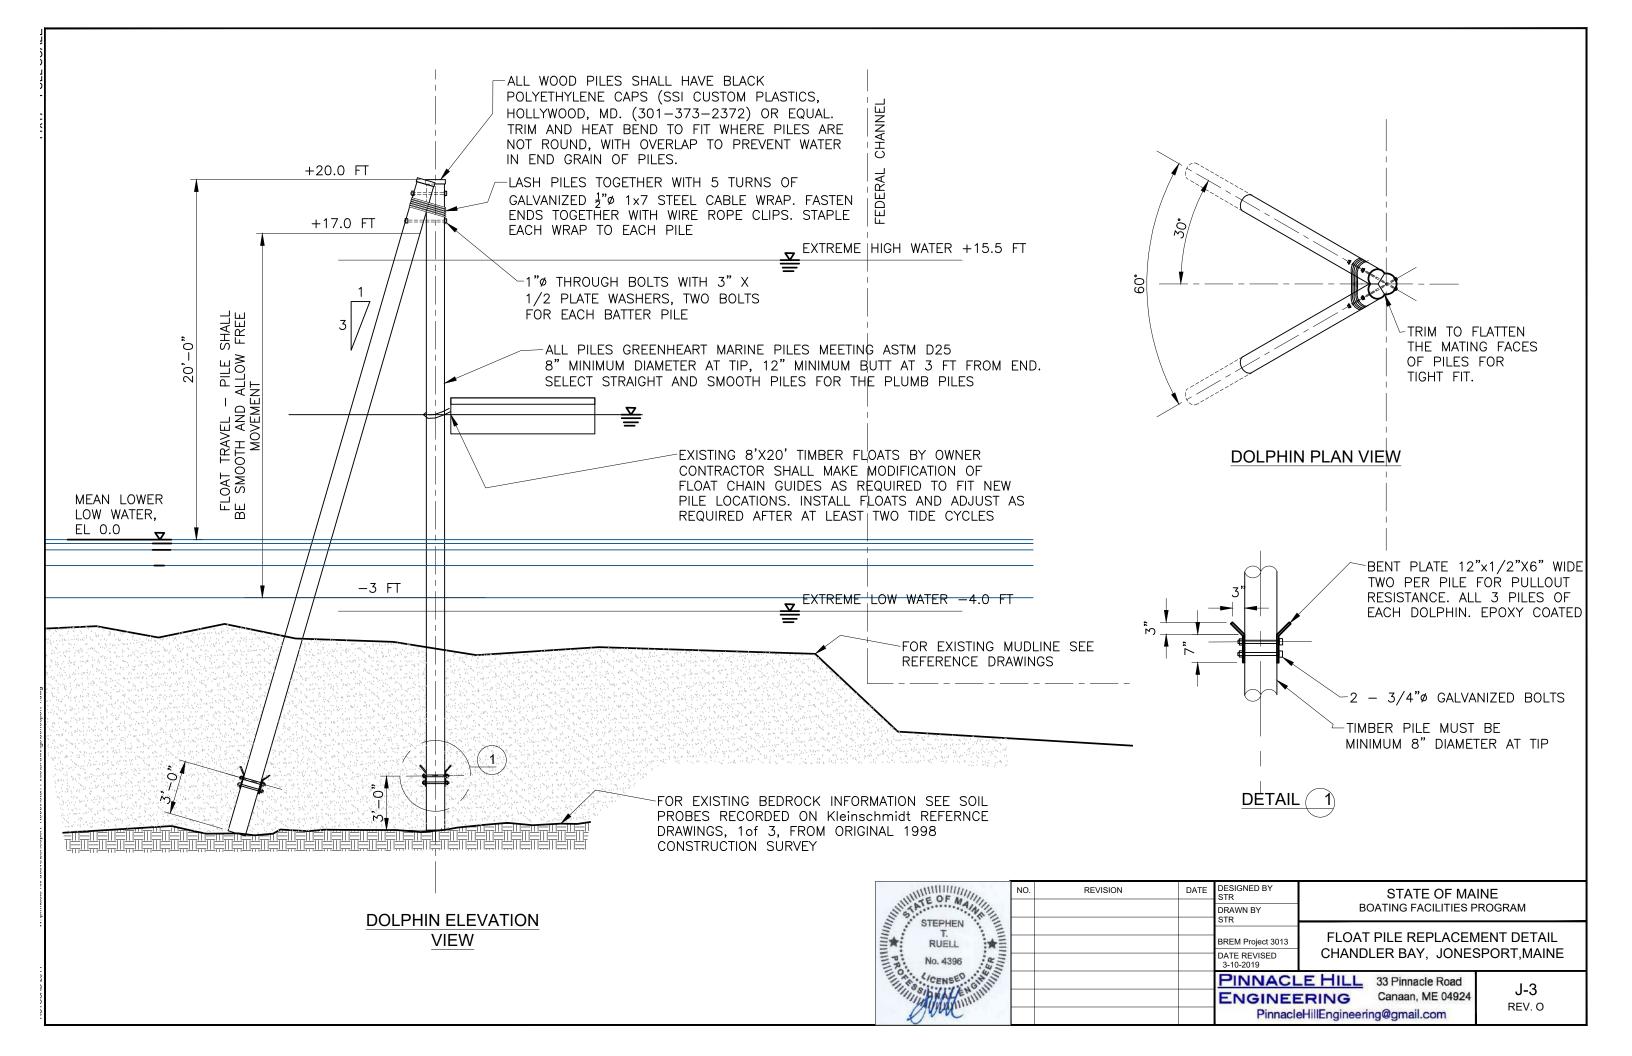

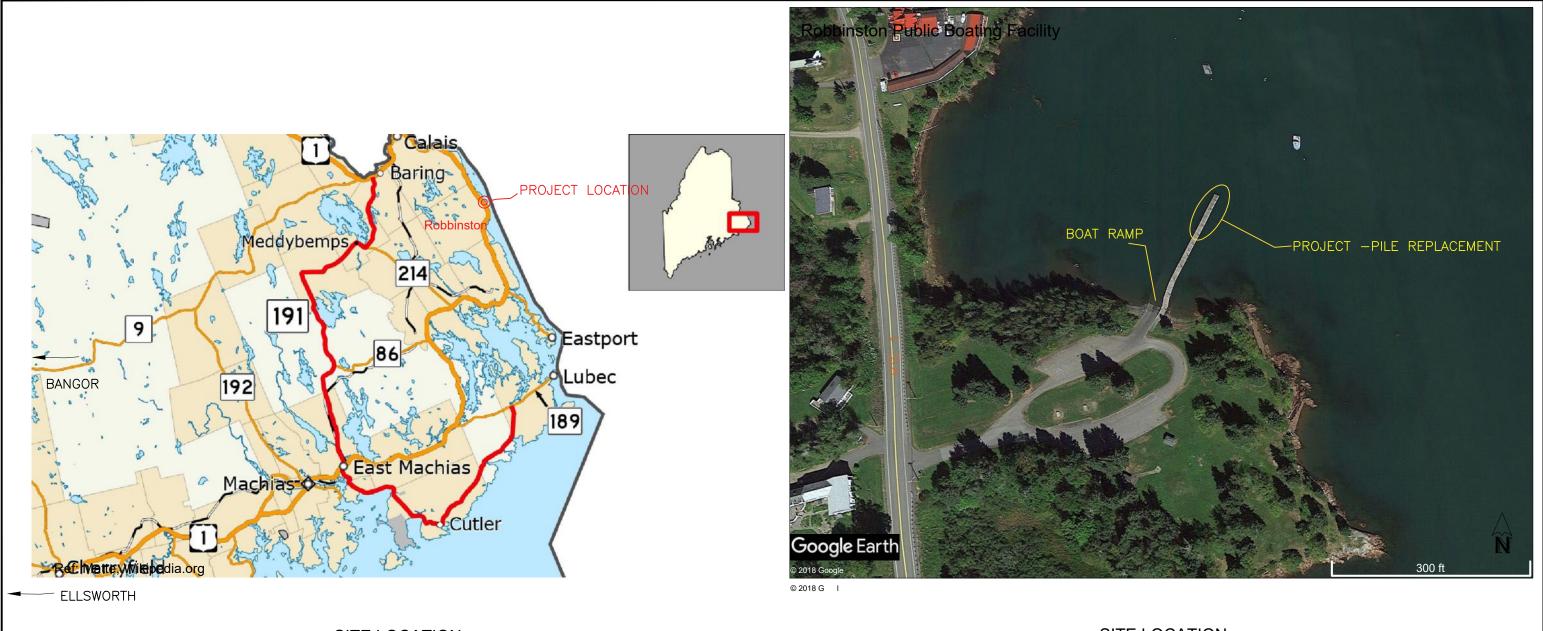



SITE LOCATION Robbinston, MAINE

E OF MA NO. REVISION DA TEPHEN T. RUELL No. 4396

SITE LOCATION Robbinston, MAINE

ATE	DESIGNED BY STR	STATE OF MAINE BOATING FACILITIES PROGRAM ROBBINSTON FLOAT PILE REPLACEMENT SITE LOCATION				
	DRAWN BY STR					
	BREM Project 3013					
	DATE REVISED 3-4-2019					
	PINNACL	EHILL 33 Pinnacle	Road R-1			
	ENGINE		. 04924 REV O			
	Pinnacle	HillEngineering@gmail.co	m NEV. O			

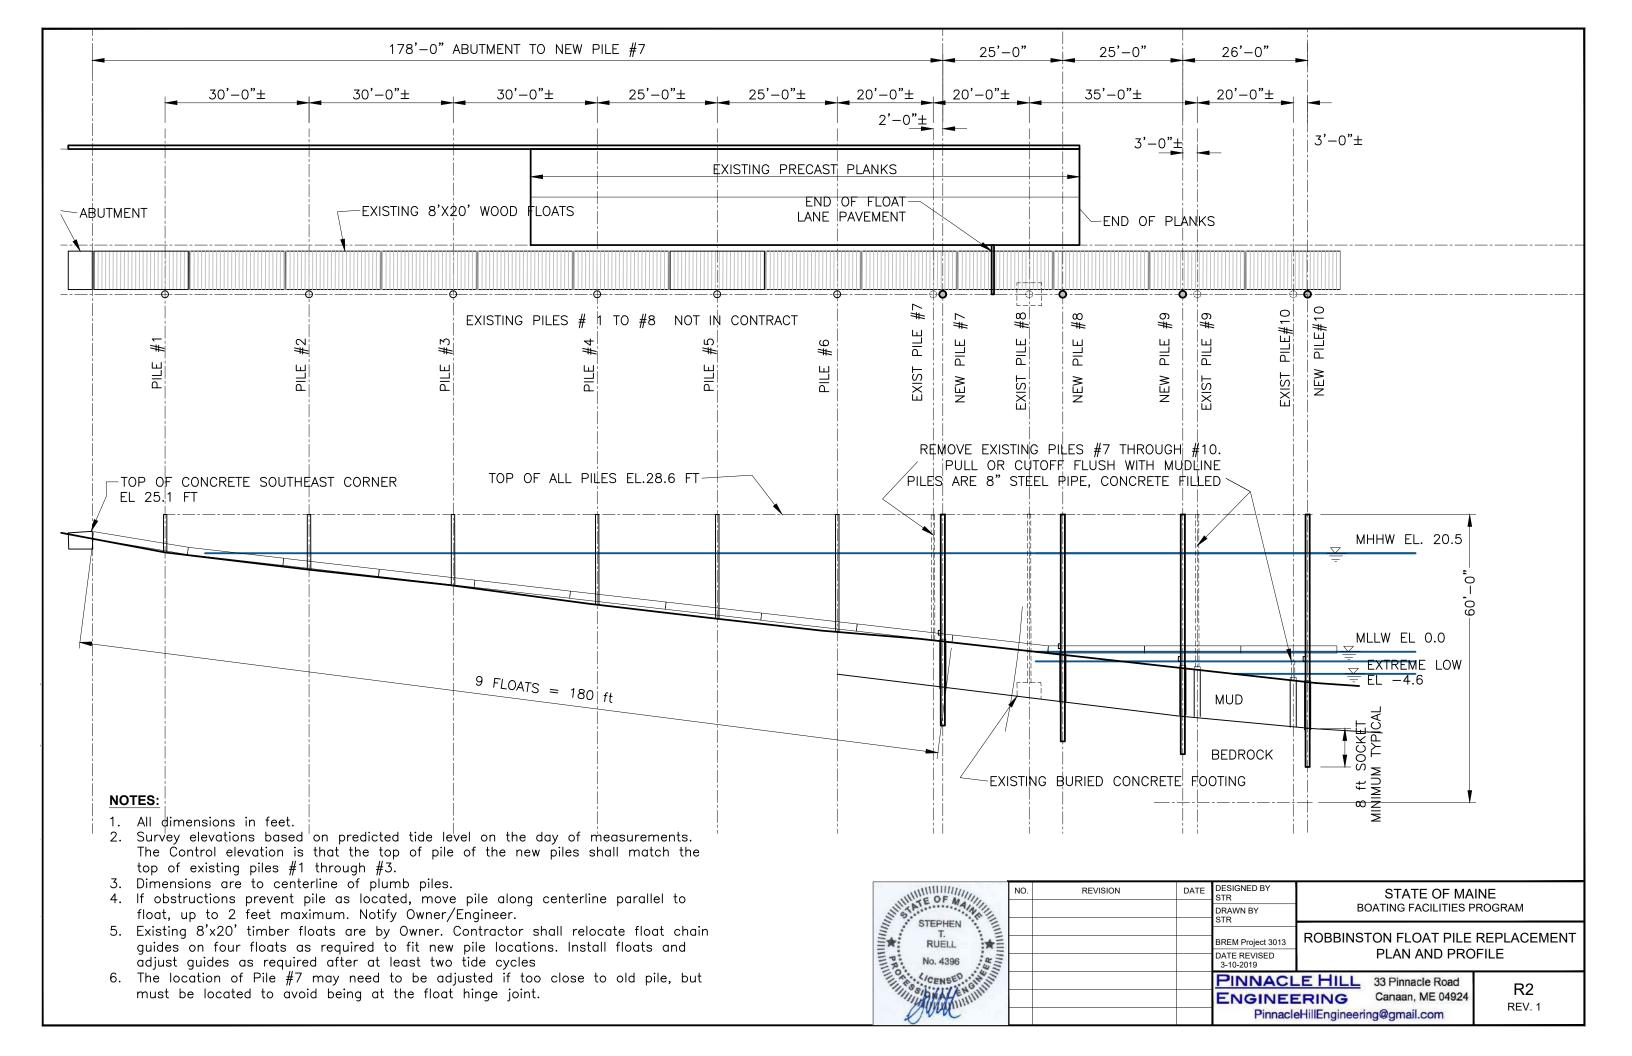

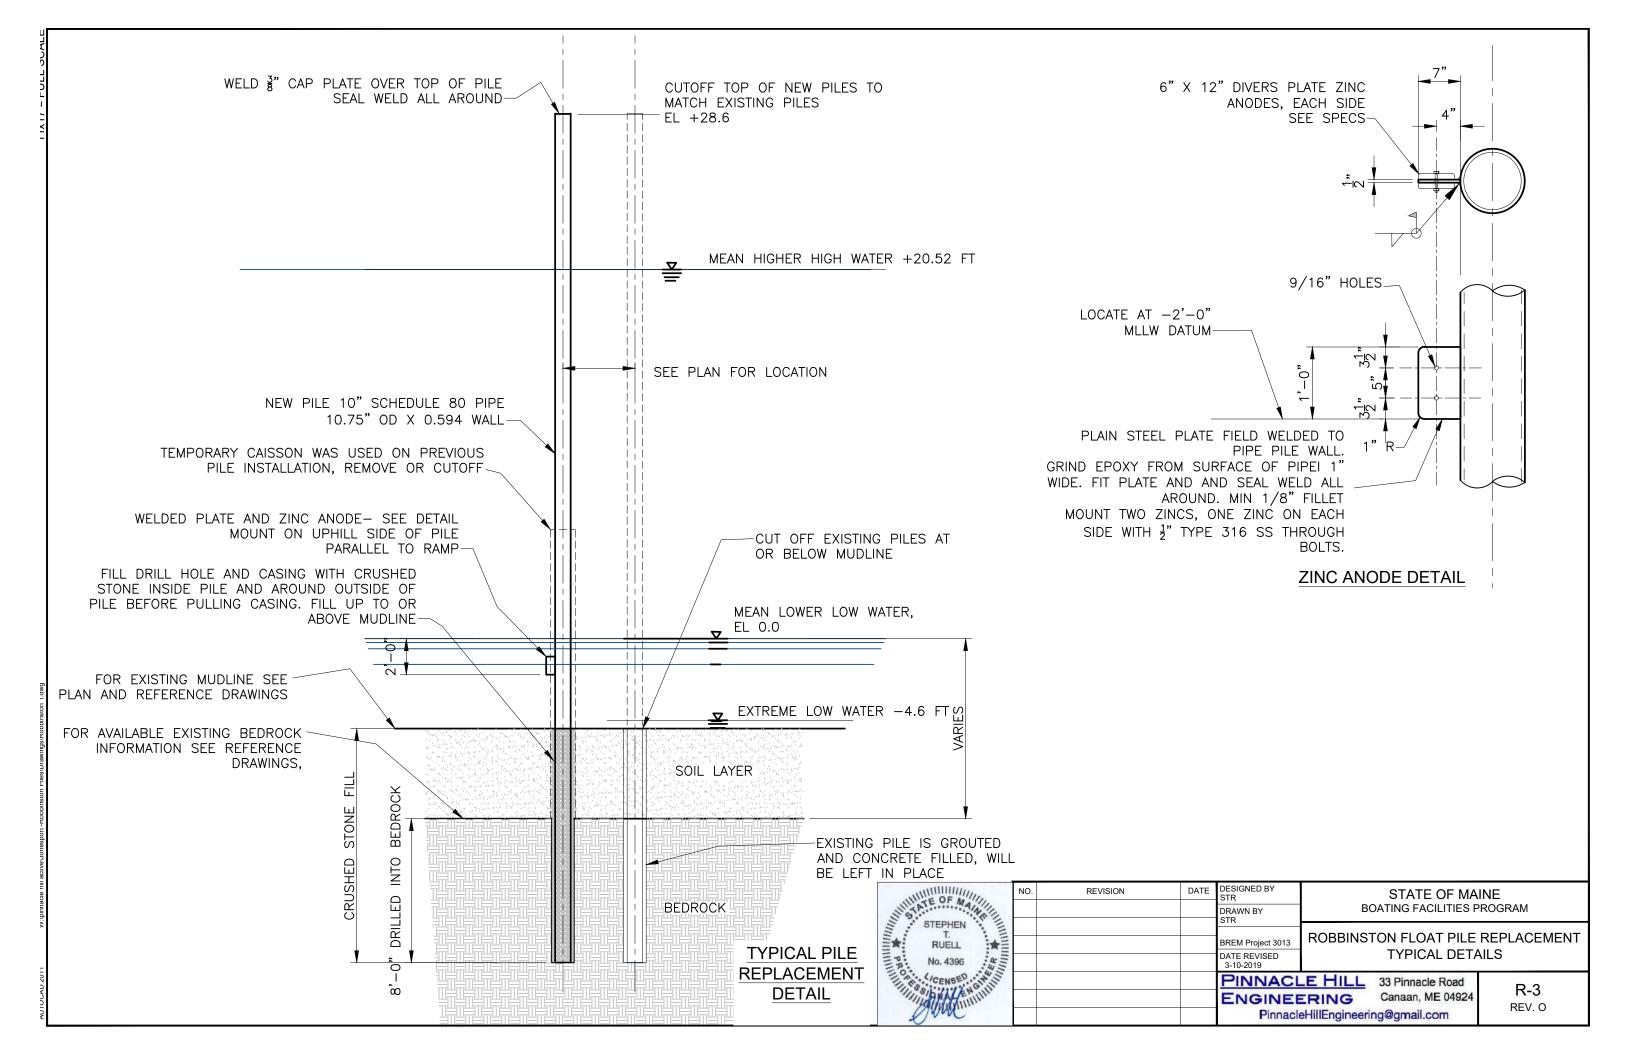



End of ramp planks

Pile # 8 is on the right, Pile #9 is past the end of plank ramp. The stub tip of Pile #10 just showing to left of Pile #9

Appendix B References



End of paved float laydown area. Pile #7 is first pile on the left

Robbinston Site Photos





Pile #8







Pile #8

Pile #9 and end of ramp

Pile #10 remaining stub, photo taken at low drain tide

			EXISTING 20' PRECAST CON PLANK RAMP	WIDE	MHW		
		9.5			30'		30'
			BITUMINOUS PAVEMENT PA	۶D	- 8'x20' FLOATS (TYP.)		
			48'	#		= #2	
		80	ABUTMENT	BILE		PILE	
		60 50 40	PLA CUF	PFECAST CONCRETE PLANK RA			
		30		PLANK RA	мр —		
	SIGNED:						
SIGNED:	SIGNED.		SCD 7-27-0.				

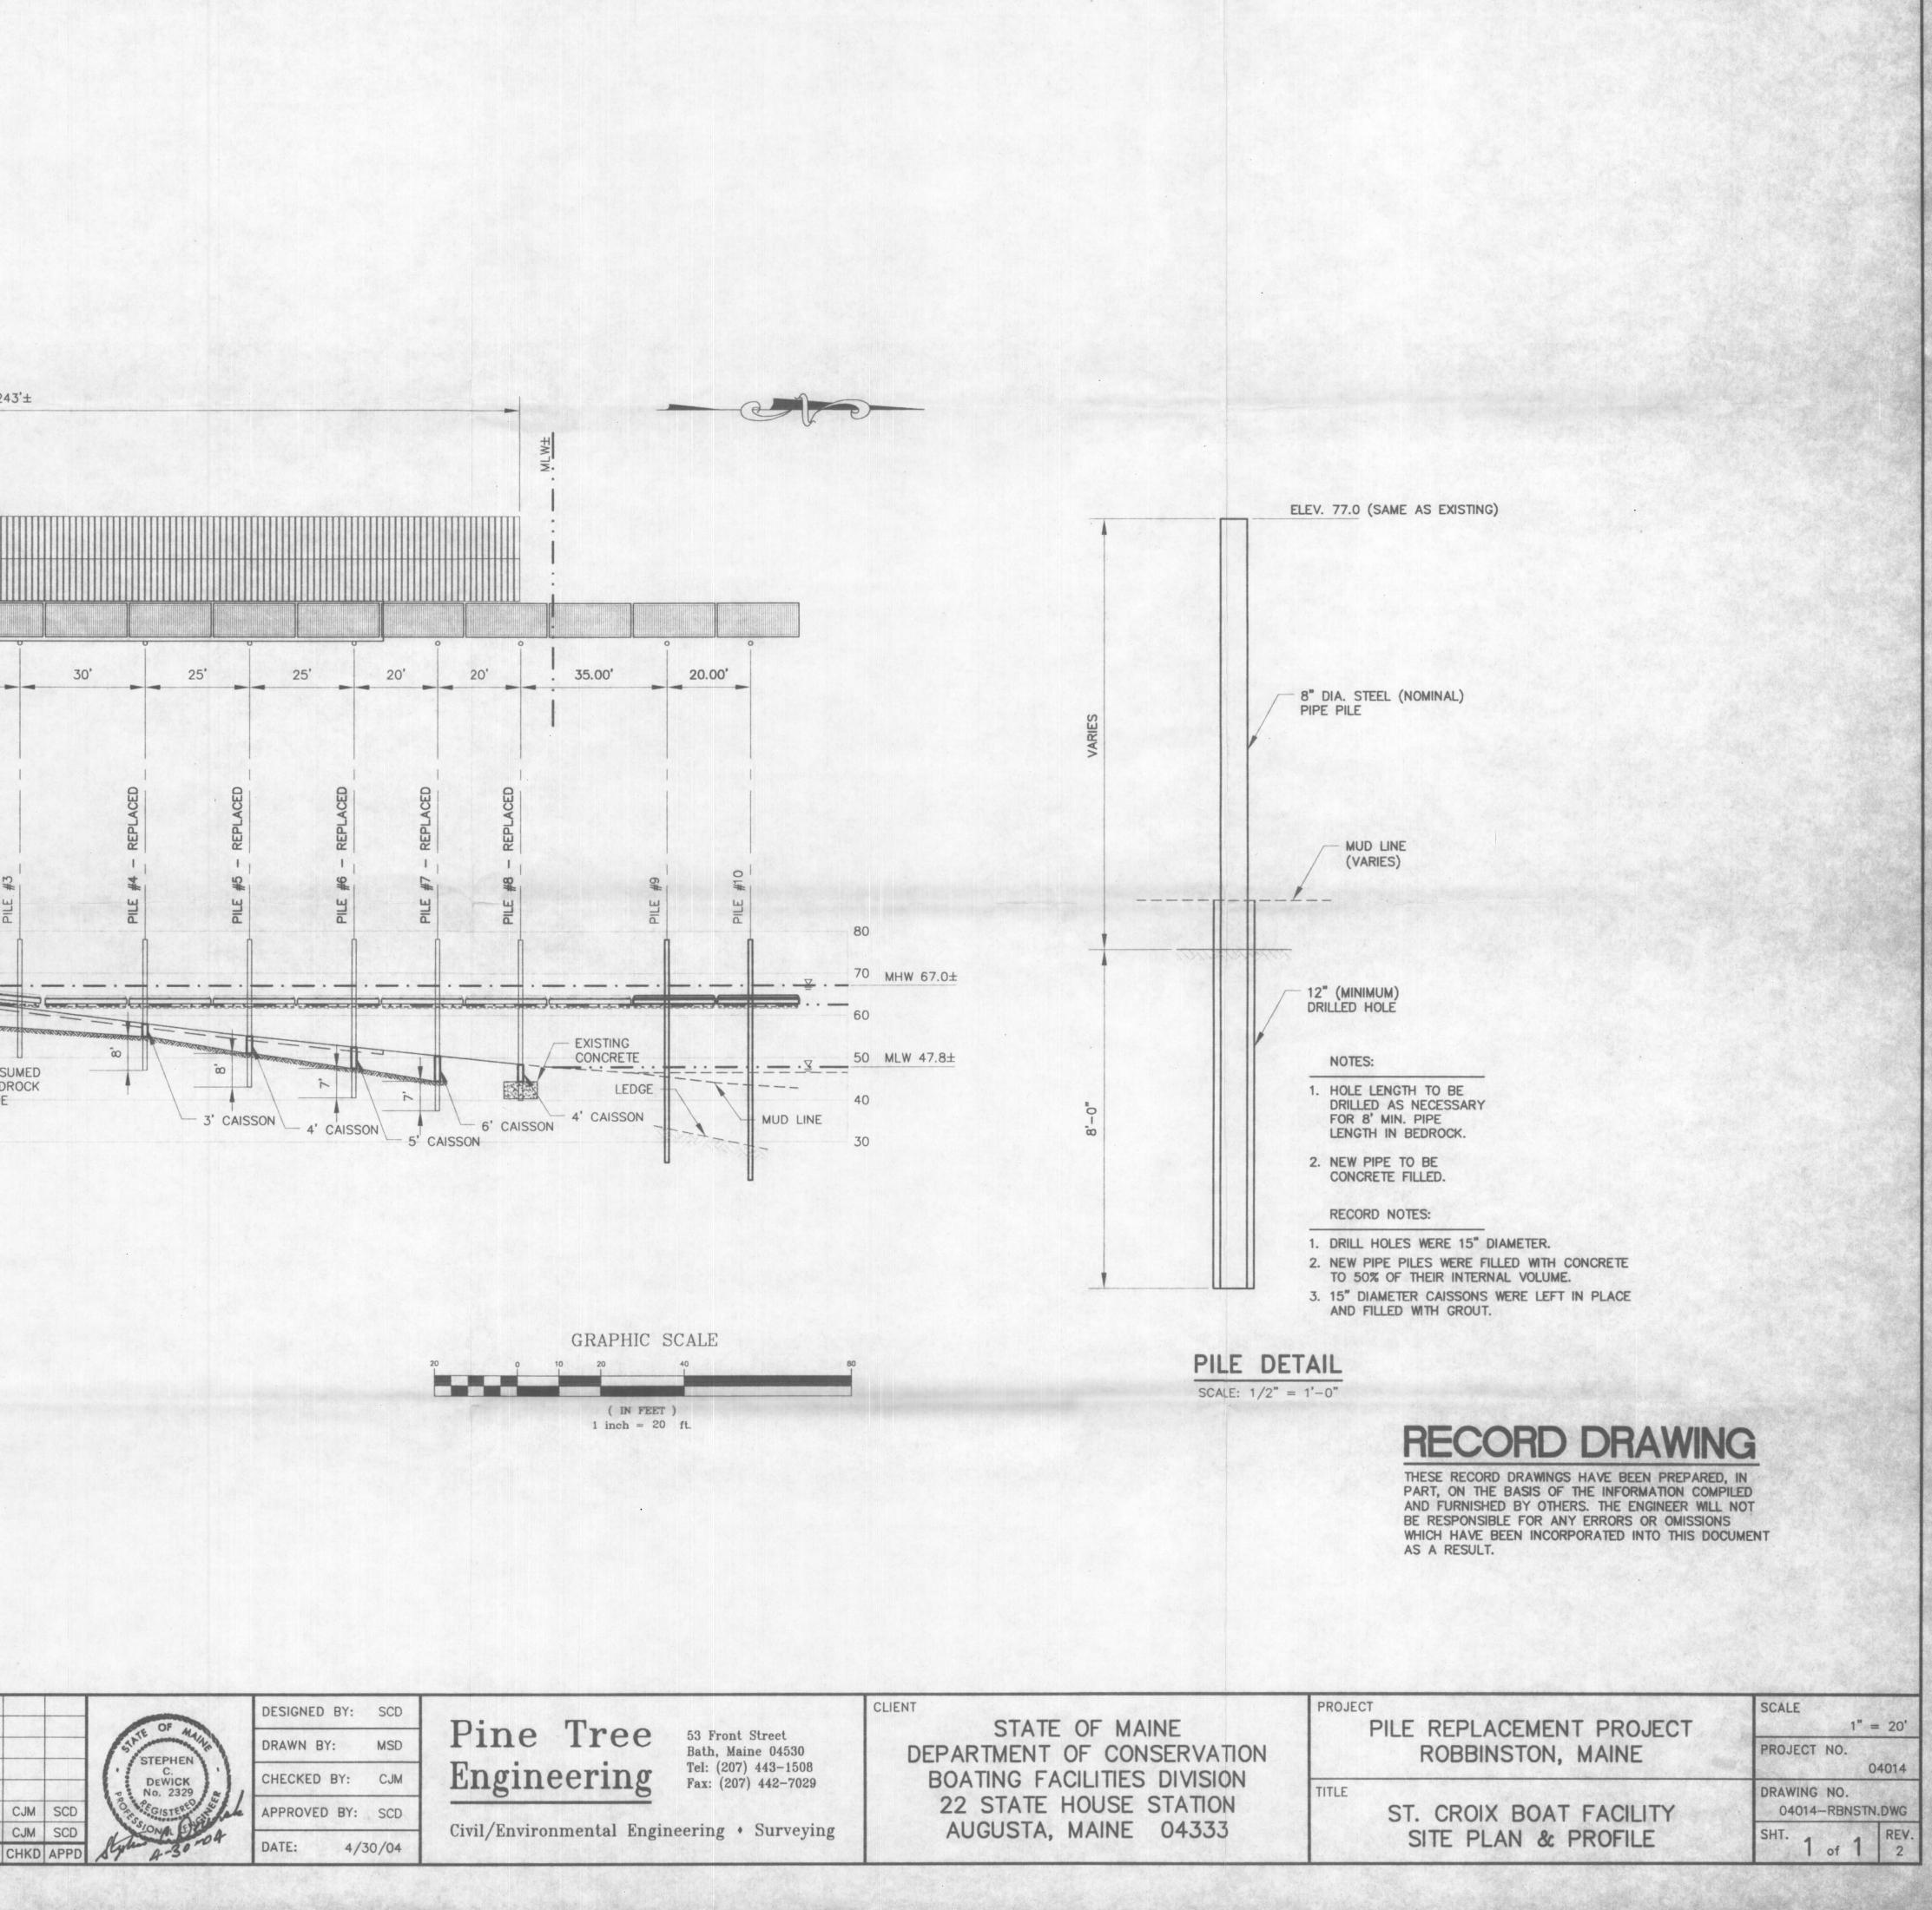

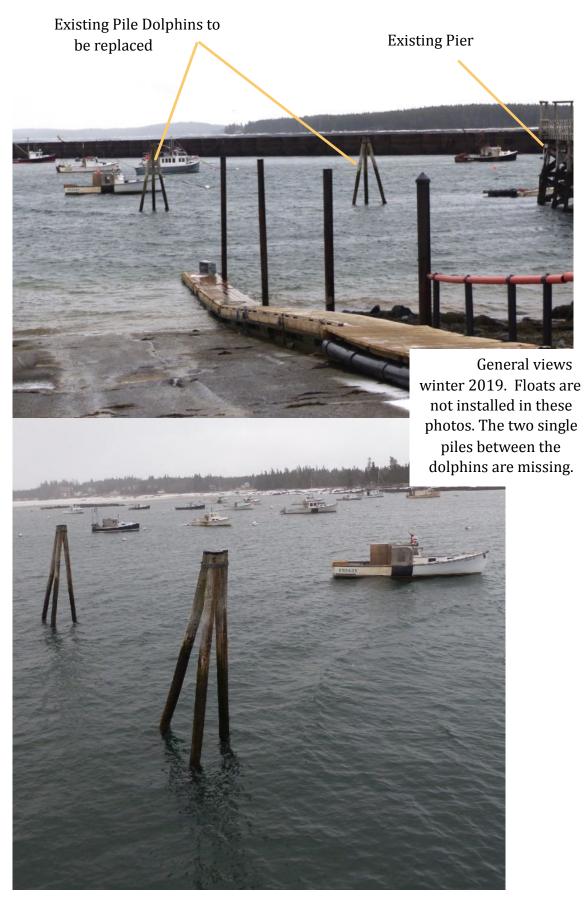








Deterioration of existing piles

from Robbinston is the same type of float

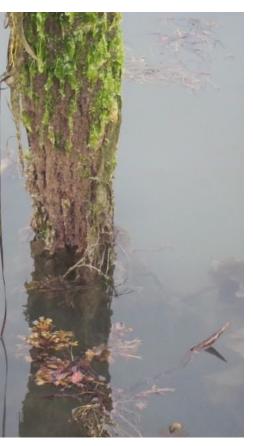

Appendix C

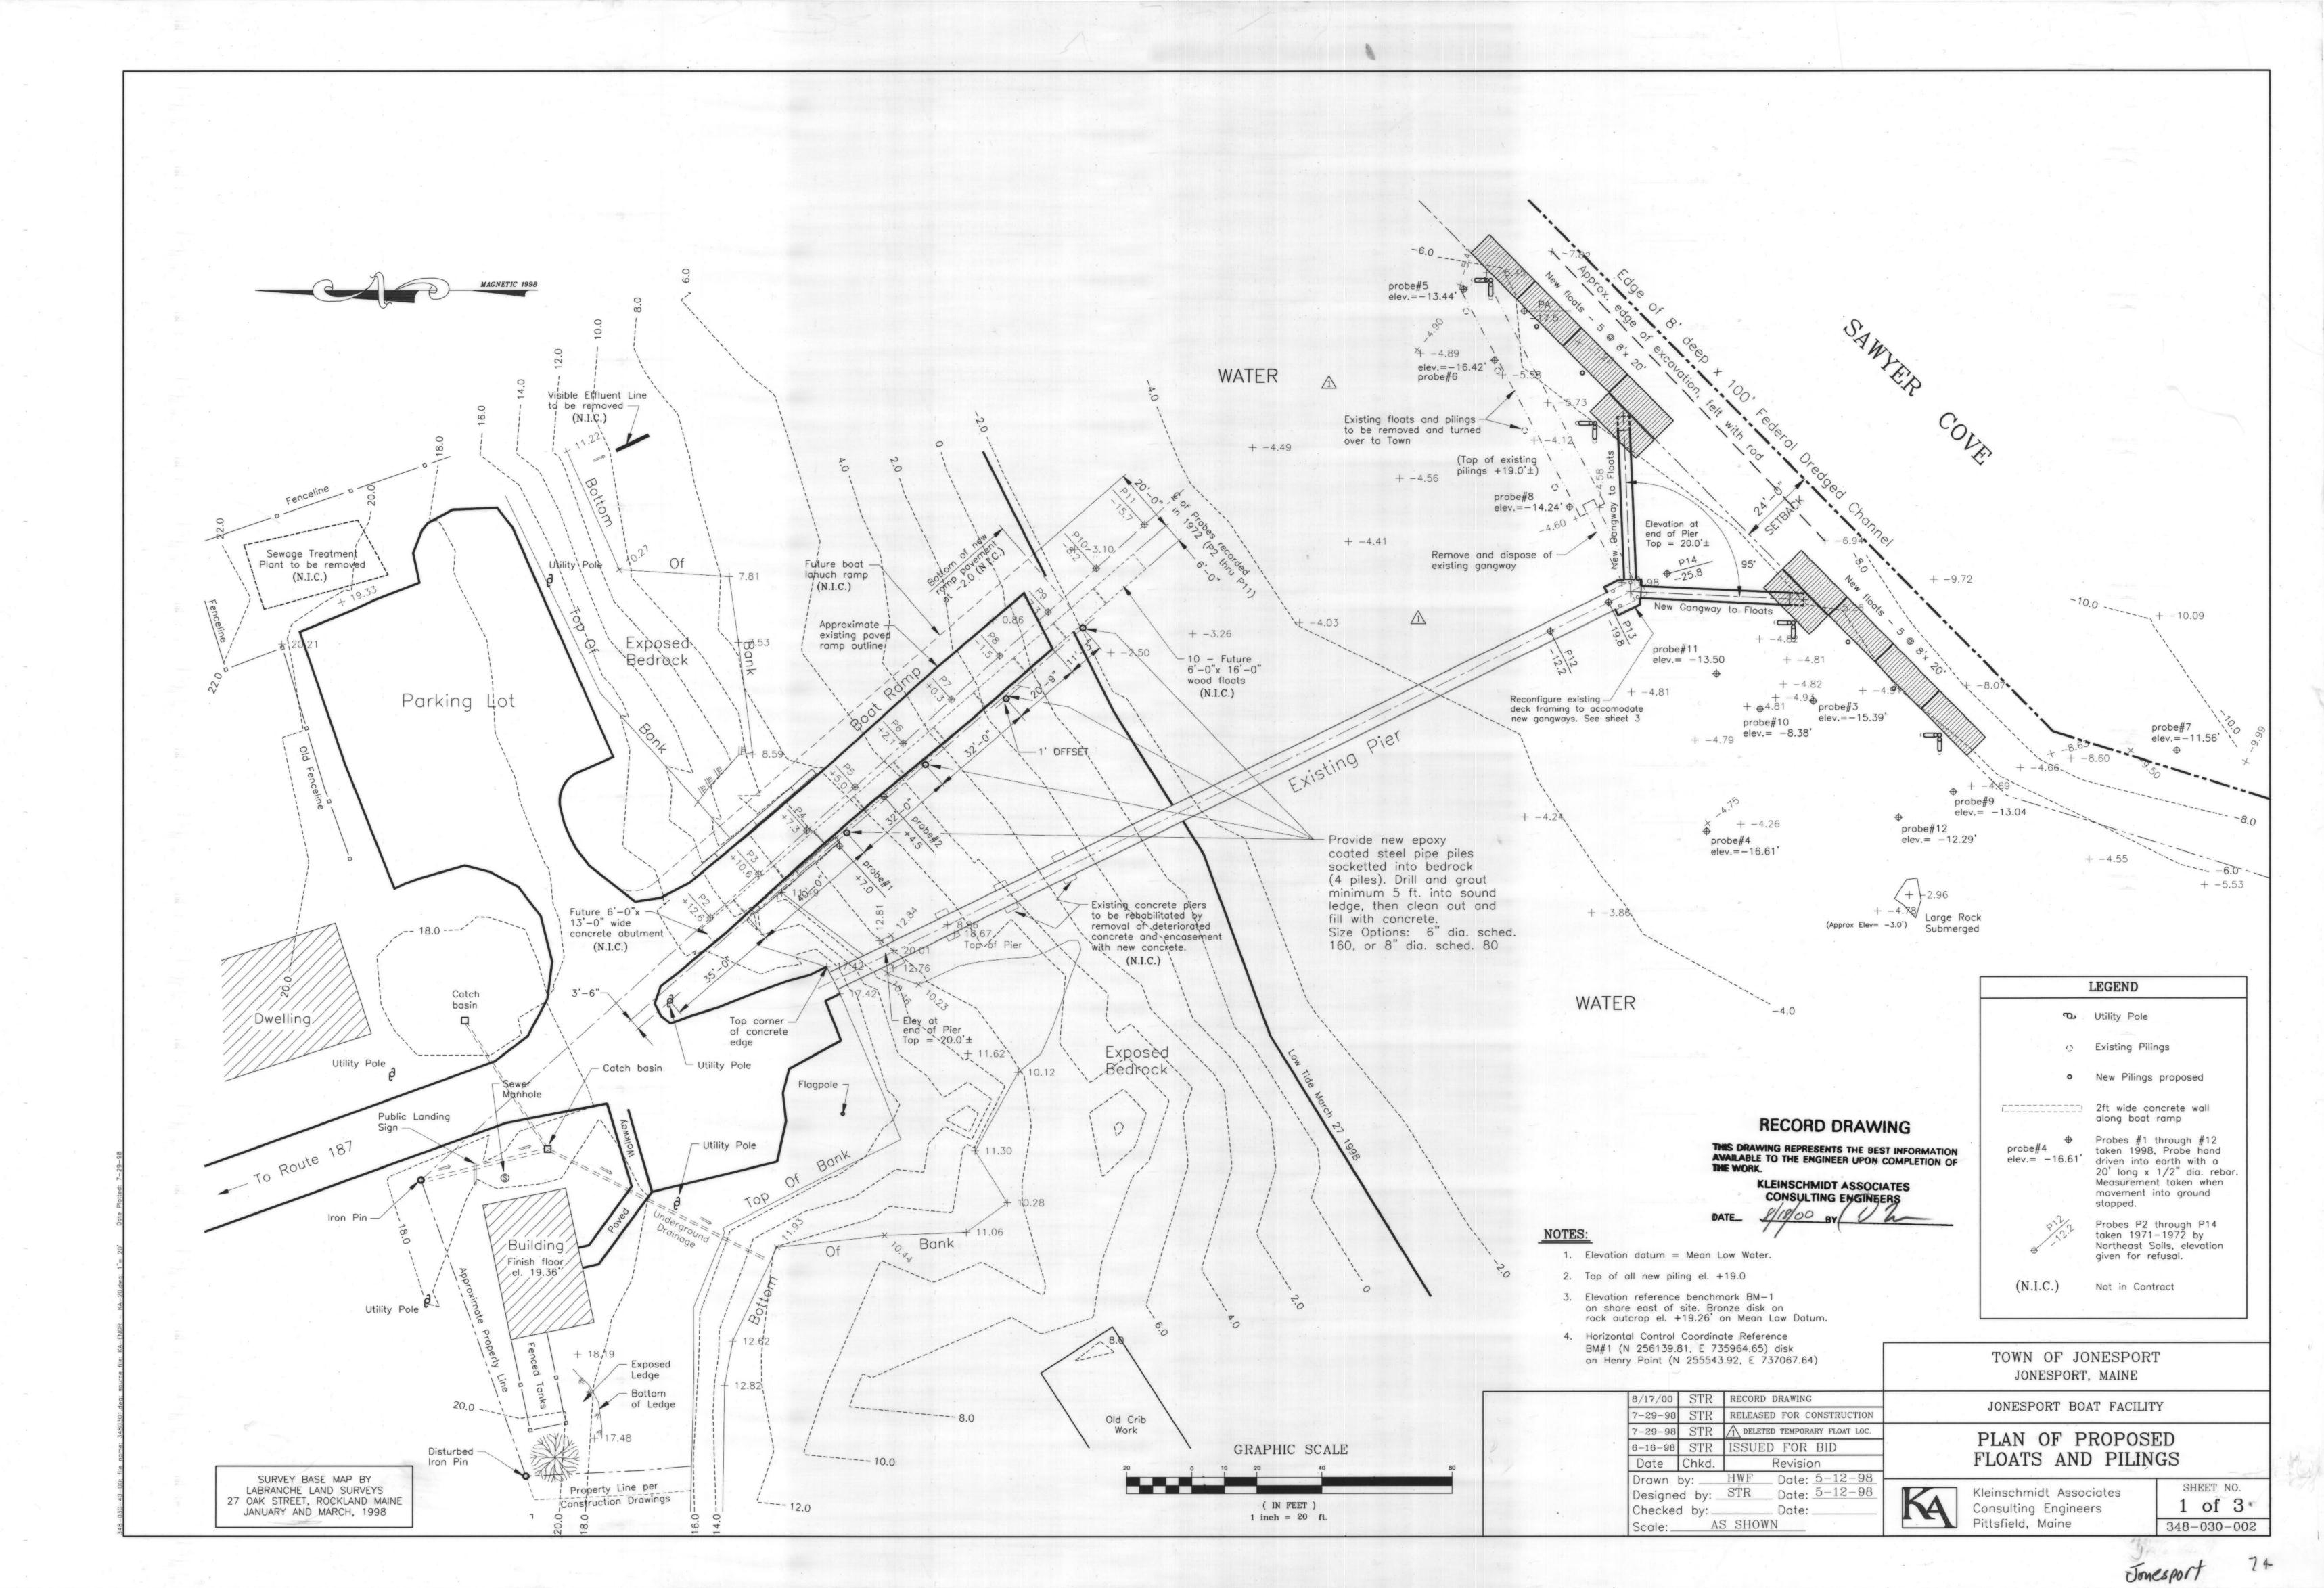

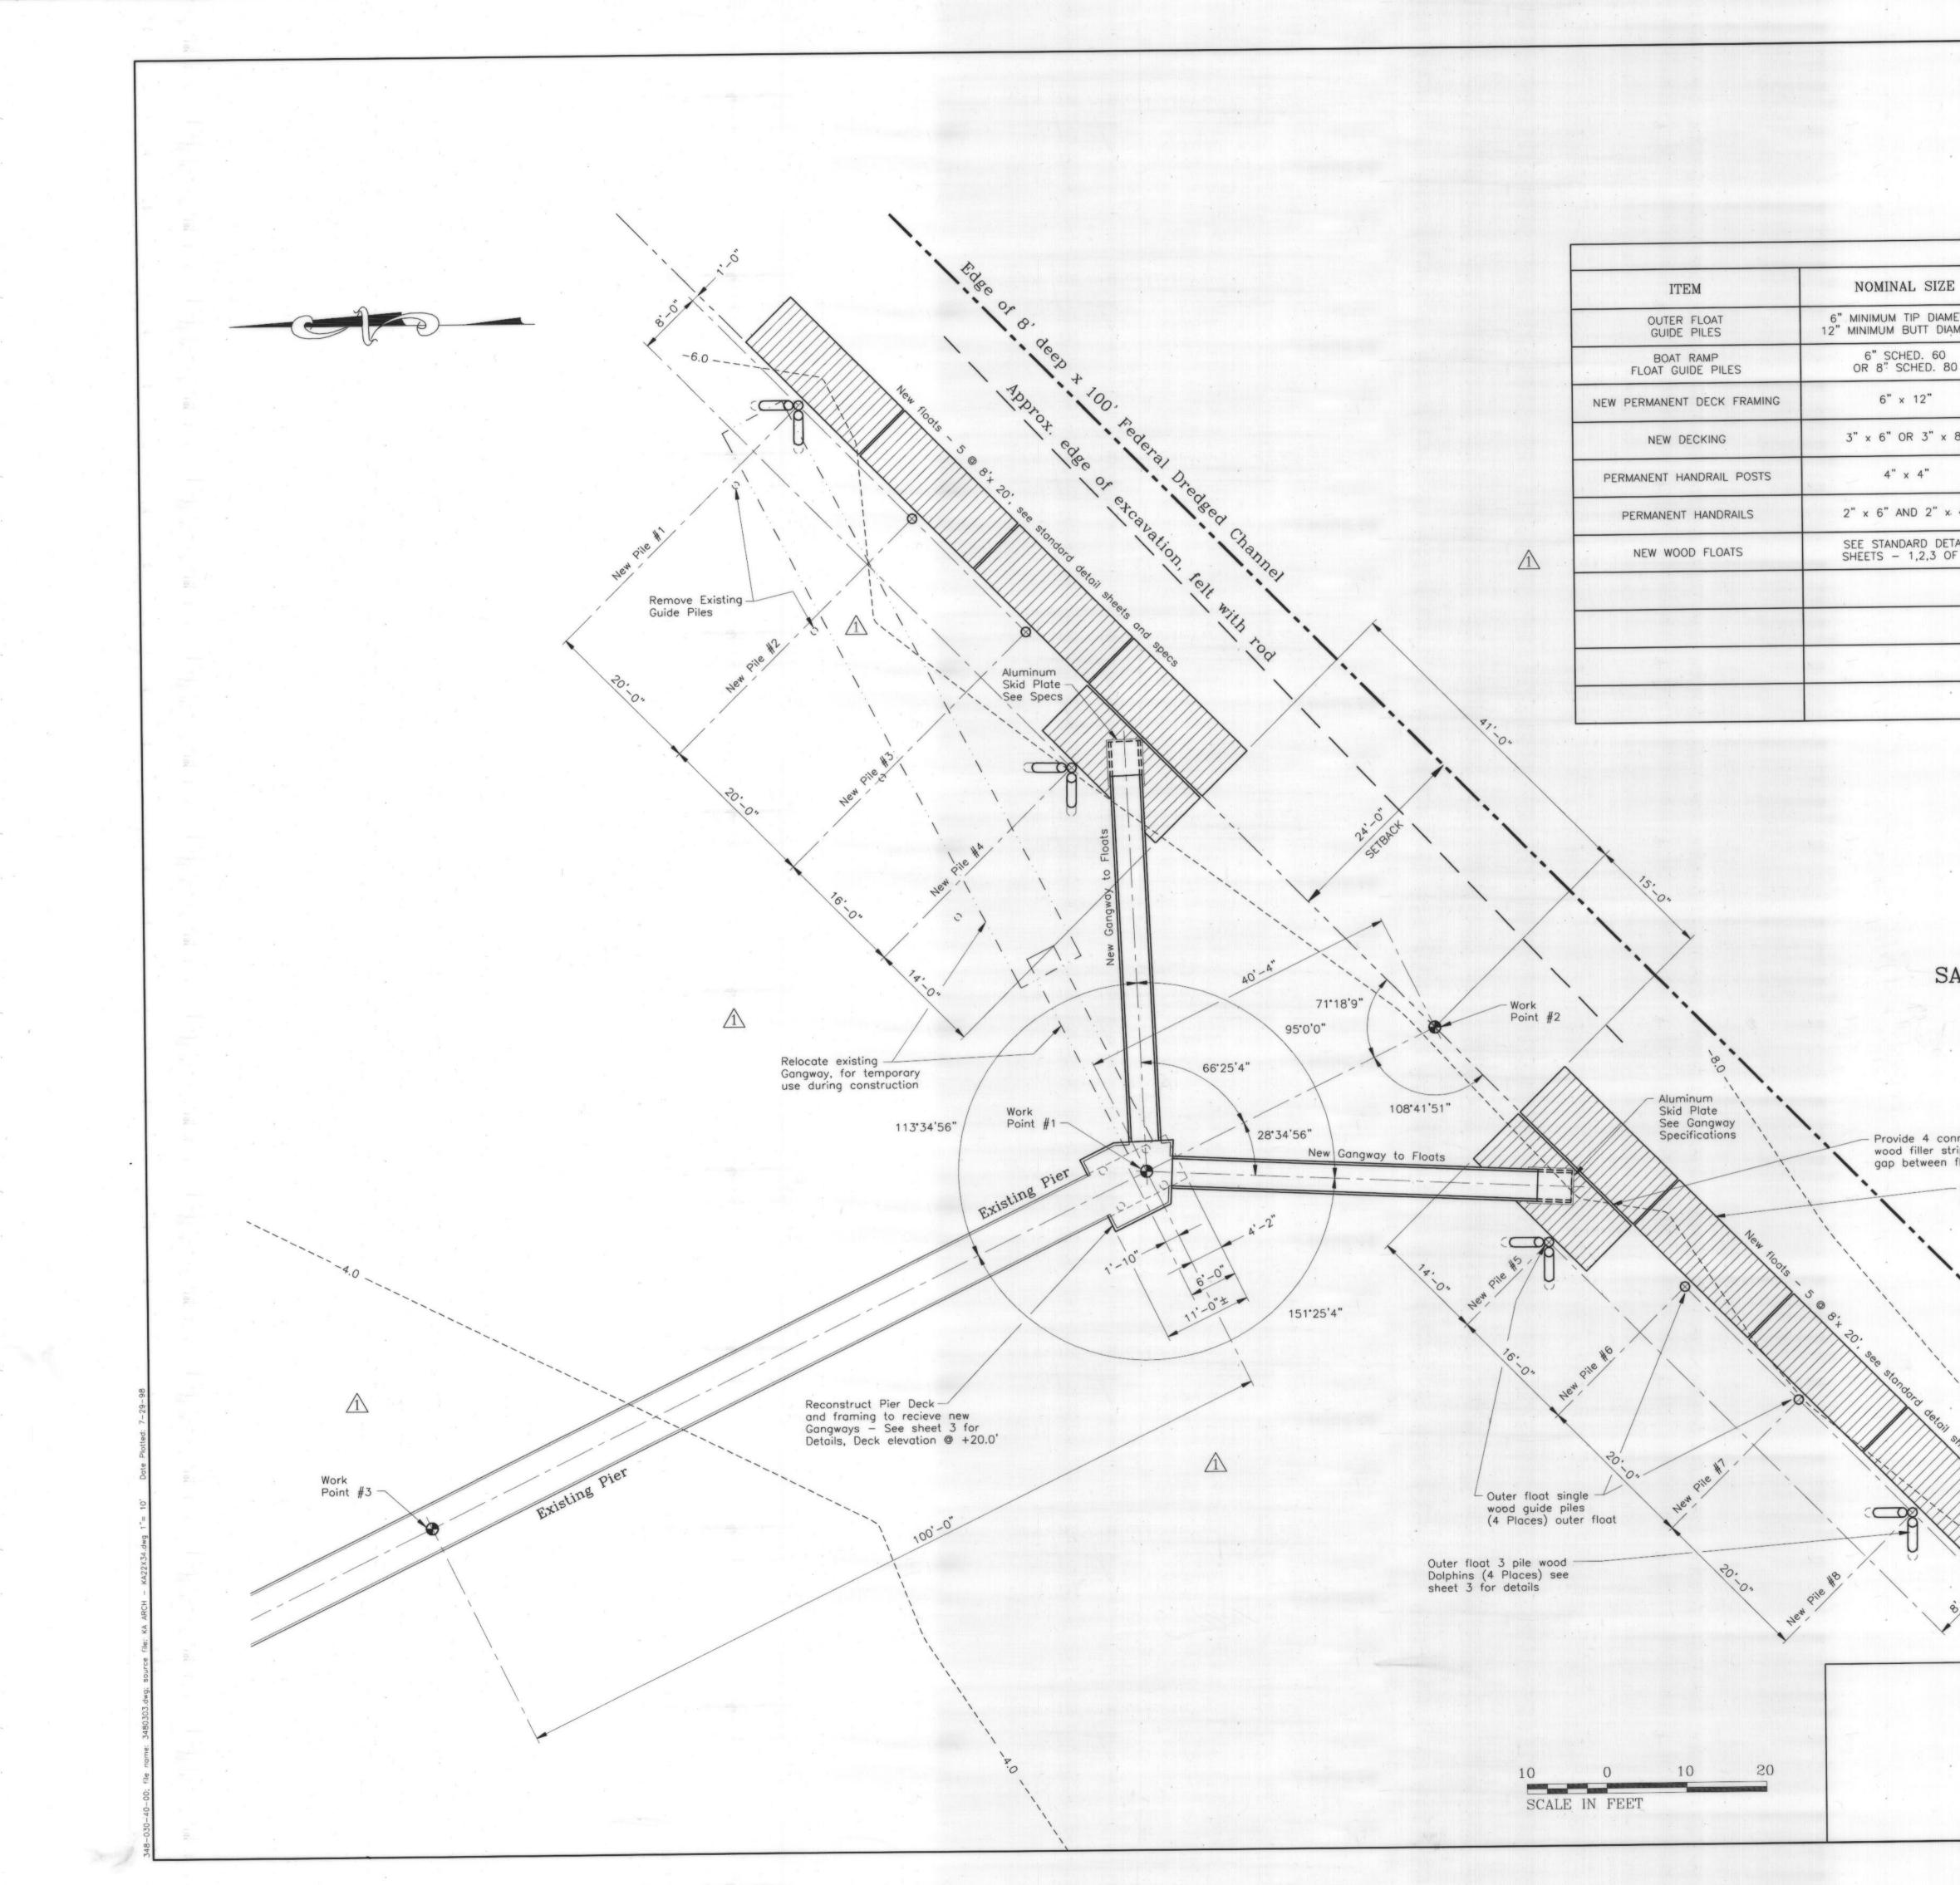

		TREATMENT PER AWPA		REMARKS
Έ	SPECIES & GRADE	STANDARD	RETENTION	REMARKS
METER IAMETER	OAK MARINE PILE ASTM D25	N/A	NONE	PEELED AND SELECTED FOR STRAIGHTNESS SEE DETAILS AND SPECIFICATIONS
80	STEEL PIPE	N/A	N/A	EPOXY COATED, CONCRETE FILLED
	SOUTHERN PINE NO. 2	C2	2.50 PCF CCA	SEE DETAILS
< 8"	SOUTHERN PINE DENSE COMMERCIAL	C2	0.60 PCF CCA	SEE DETAILS
	SOUTHERN PINE NO. 1	C2	0.60 PCF CCA	SEE DETAILS
x. 4"	SOUTHERN PINE NO. 1	C2 .	0.60 PCF CCA	SEE DETAILS
ETAIL OF 3	EASTERN SPRUCE	N/A	NONE	SEE SPECIFICATIONS AND STANDARD DETAIL SHEETS
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DATE_

TABLE OF DIMENSIONS (Distances are in Decimal feet U.N.O.)					
Work Point #1 Work Point					
Work Point #1	0.000'	100.000'			
Work Point #3	100.000'	0.000'			
New Pile #1	105.035'	147.575'			
New Pile #2	86.581'	139.744'			
New Pile #3	69.019'	134.465'			
New Pile #4	51.262'	124.315'			
New Pile #5	51.100'	144.324'			
New Pile #6	68.889'	159.714'			
New Pile #7	86.441'	171.815'			
New Pile #8	104.891'	185.298'			

SAWYER COVE

Provide 4 connection hinges and wood filler strip to fill and cover gap between floats

Provide toe rail on outside perimeter of float assembly


-Federal Channel

RECORD DRAWING

THIS DRAWING REPRESENTS THE BEST INFORMATION AVAILABLE TO THE ENGINEER UPON COMPLETION OF THE WORK. KLEINSCHMIDT ASSOCIATES CONSULTING ENGINEERS

X				0.0		
		-6.0	TOWN OF JONESPORT JONESPORT, MAINE			
8/17/00	STR	RECORD DRAWING	JONESPORT BOAT FACILIT	Y		
7-29-98	STR	RELEASED FOR CONSTRUCTION				
7-29-98	STR	ADDED TABLE OF DIMENSIONS	NEW FLOATS AND)		
6-16-98	STR	ISSUED FOR BID				
Date	Chkd.	Revision	GANGWAYS PLAN	24 - A		
Drawn Designe Checke	d by: _	HWF Date: 5-28-98 STR Date: 5-28-98 Date: 5-28-98	Kleinschmidt Associates Consulting Engineers	SHEET NO. 2 of 3		
Scale:_	1	1"= 10'	Pittsfield, Maine	348-030-002		

Jmesport 74

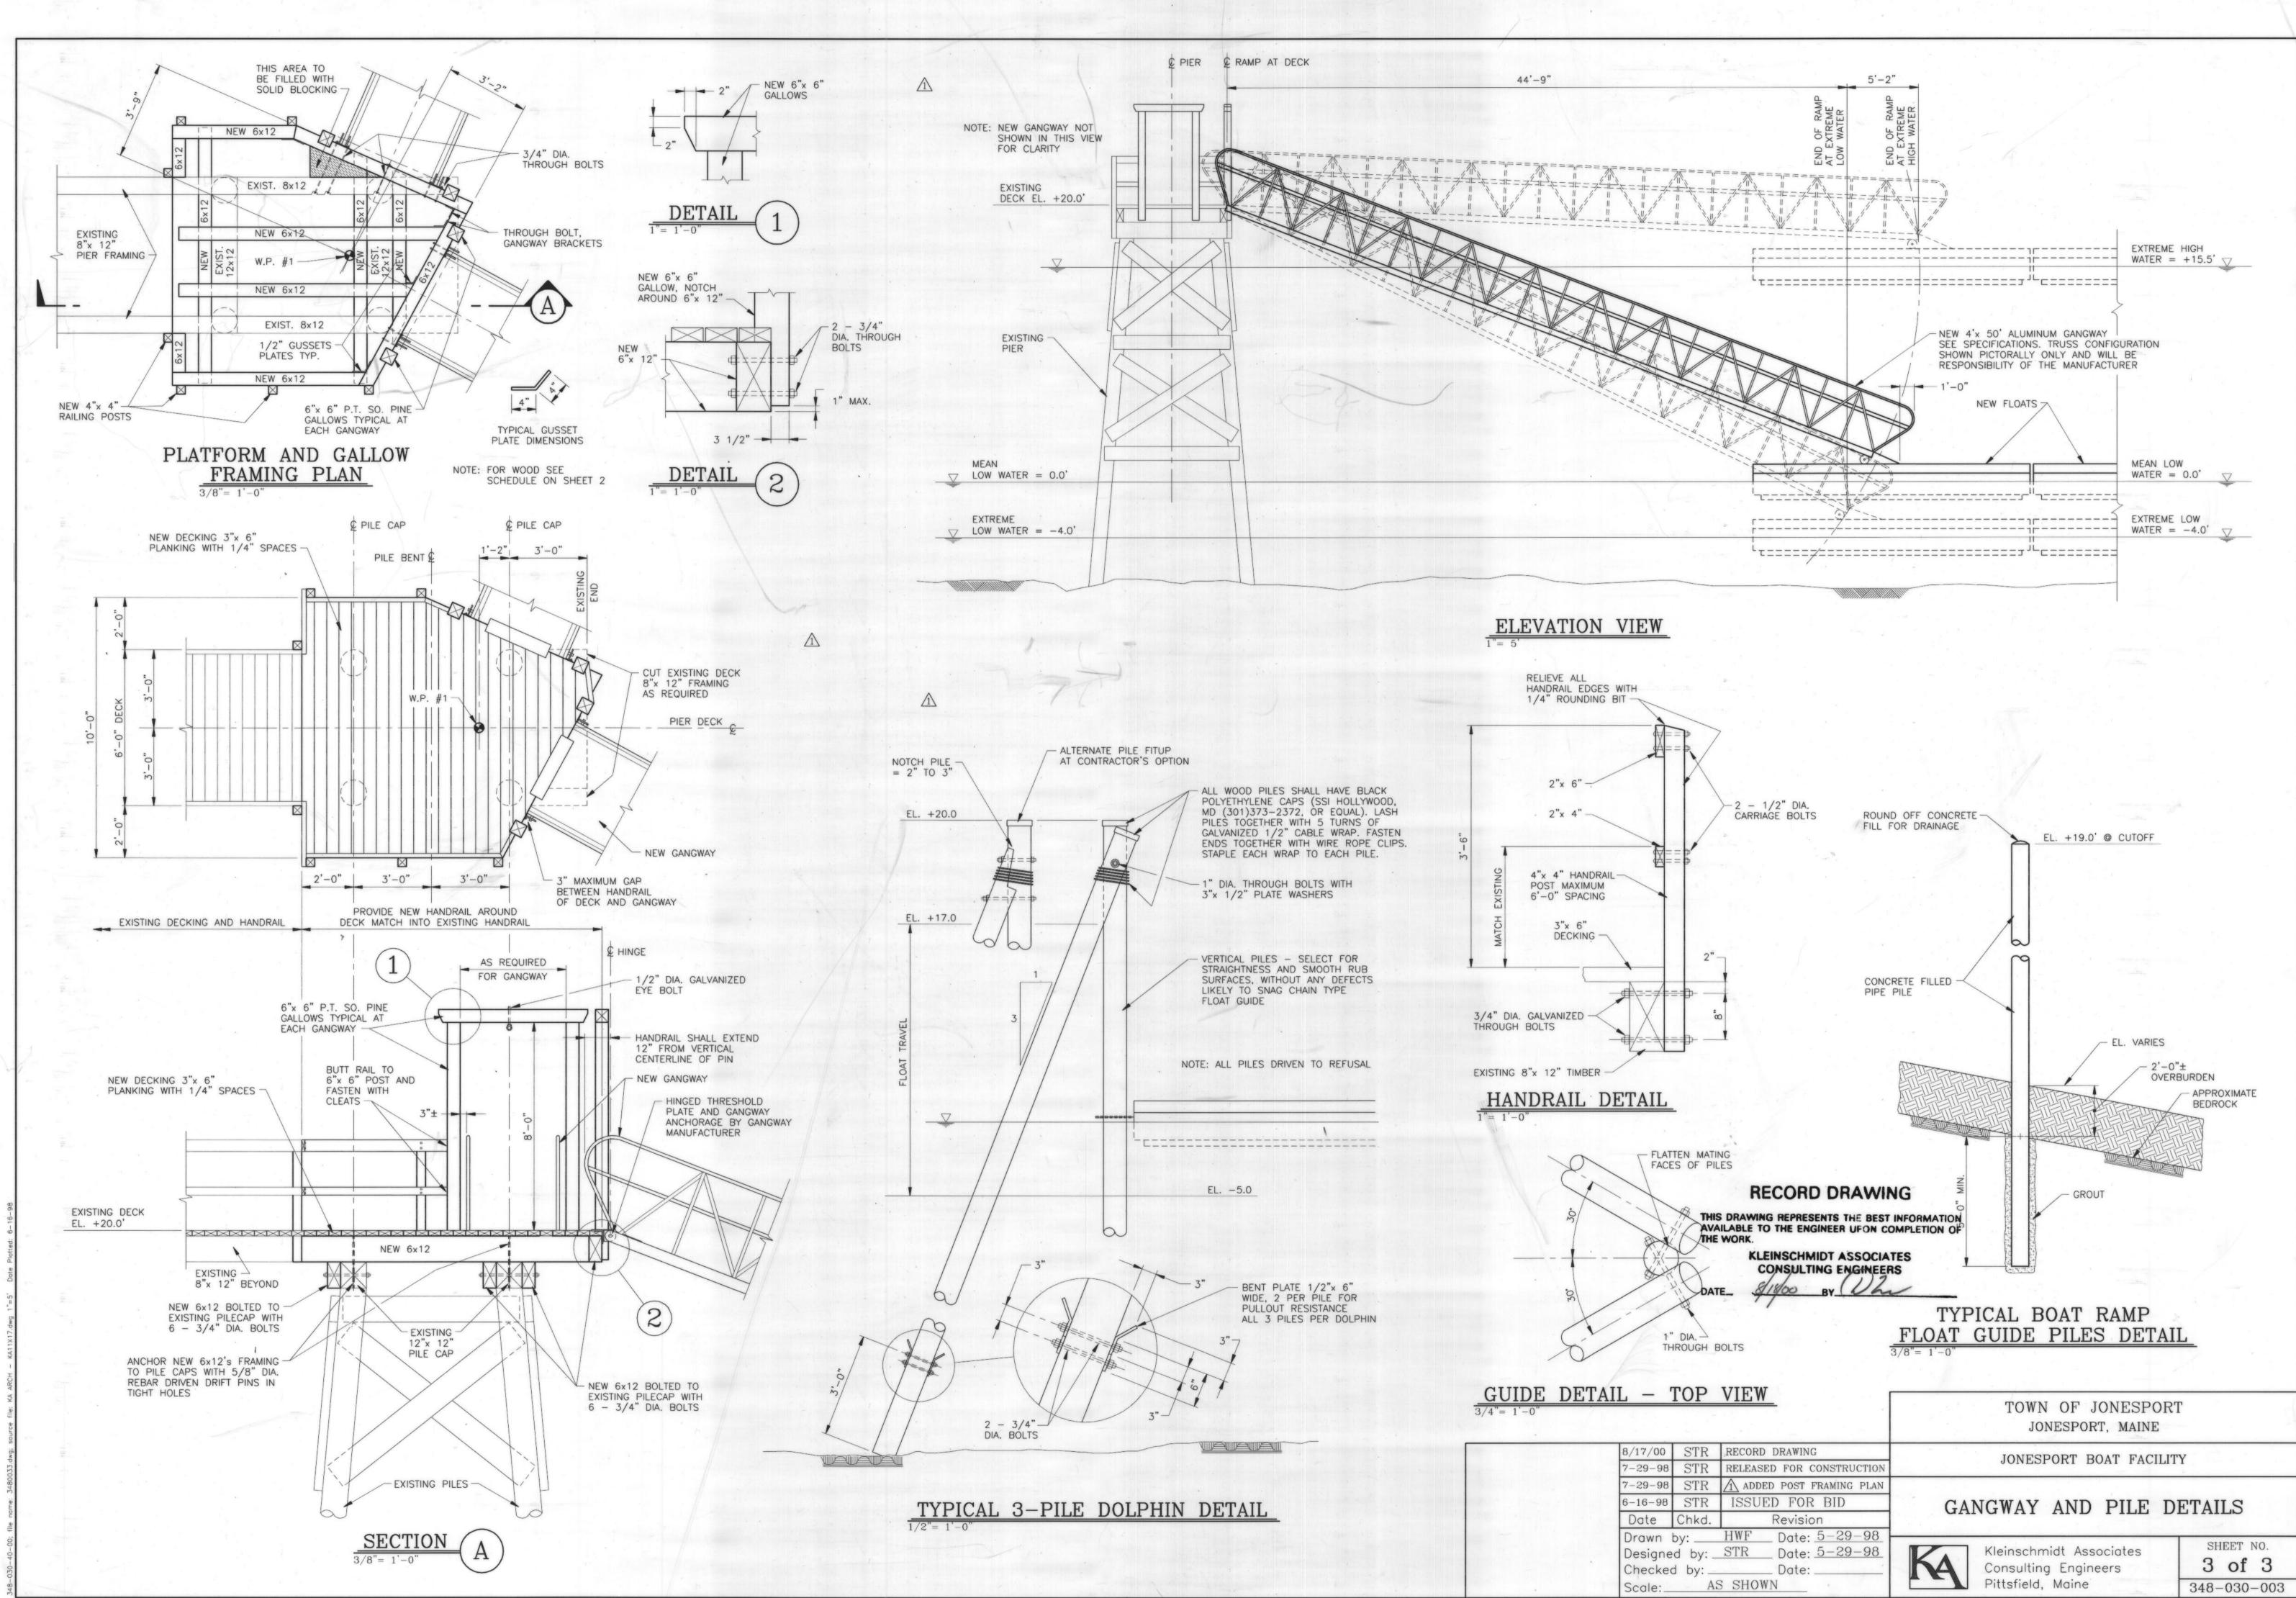

Jonesport

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