

LOCUS MAP

N.T.S.

LIST OF DRAWINGS

EX-1	EXISTING CONDITIONS PLAN
SP1.1	SITE PREPARATION PLAN
SP2.1	SECONDARY SUBGRADE PLAN
SP3.1	EARTHWORK NOTES
L1.1	LAYOUT AND MATERIALS PLAN
L2.1	GRADING PLAN
C1.1	DRAINAGE PLAN
C2.1	DRAINAGE DETAILS
L3.1	ALTERNATE 1 & 2
L3.2	ALTERNATE 1 & 2 - ENLARGEMENTS
L4.1	DETAIL SHEET I
L4.2	DETAIL SHEET II
L4.3	DETAIL SHEET III
L4.4	DETAIL SHEET IV
E0.0	ELECTRICAL LEGEND, DETAILS & ONE-LINE
EO.1	ELECTRICAL SPECIFICATIONS
E1.1	ELECTRICAL SITE PLAN
FLL1.1	FIELD LINE LAYOUT PLAN

BID DOCUMENTS

YARMOUTH HIGH SCHOOL SYNTHETIC TURF CARPET REPLACEMENT

YARMOUTH, MAINE

OWNER

Town of Yarmouth 200 Main Street Yarmouth, Maine 04096 - 6317 (207) 846-9036

LANDSCAPE ARCHITECT

Activitas Inc. 16 School Street Dedham, Massachusetts 02026 - 4310 (781) 326-2600

CIVIL ENGINEER

Samiotes Consultants, Inc. 20 A Street Framingham, Massachusetts 01701 - 4102 (508) 877-6688

GEOTECHNICAL ENGINEER

Haley & Aldrich, Inc. 465 Medford Street, Suite 2200 Boston, Massachusetts 02129 - 1454 (617) 886-7400

ELECTRICAL ENGINEER

Richard D. Kimball Company, Inc. 200 Brickstone Square Andover, Massachusetts 01810 - 1488 (978) 296-6232

SURVEY

LandTech Consultants 515 Groton Road Westford, Massachusetts 01886 - 6321 (978) 692-6100


YARMOUTH HIGH SCHOOL SYNTHETIC TURF CARPET REPLACEMENT


BID DOCUMENTS FEBRUARY 15, 2013

OWNER

Town of Yarmouth 200 Main Street Yarmouth, Maine 04096 - 6317



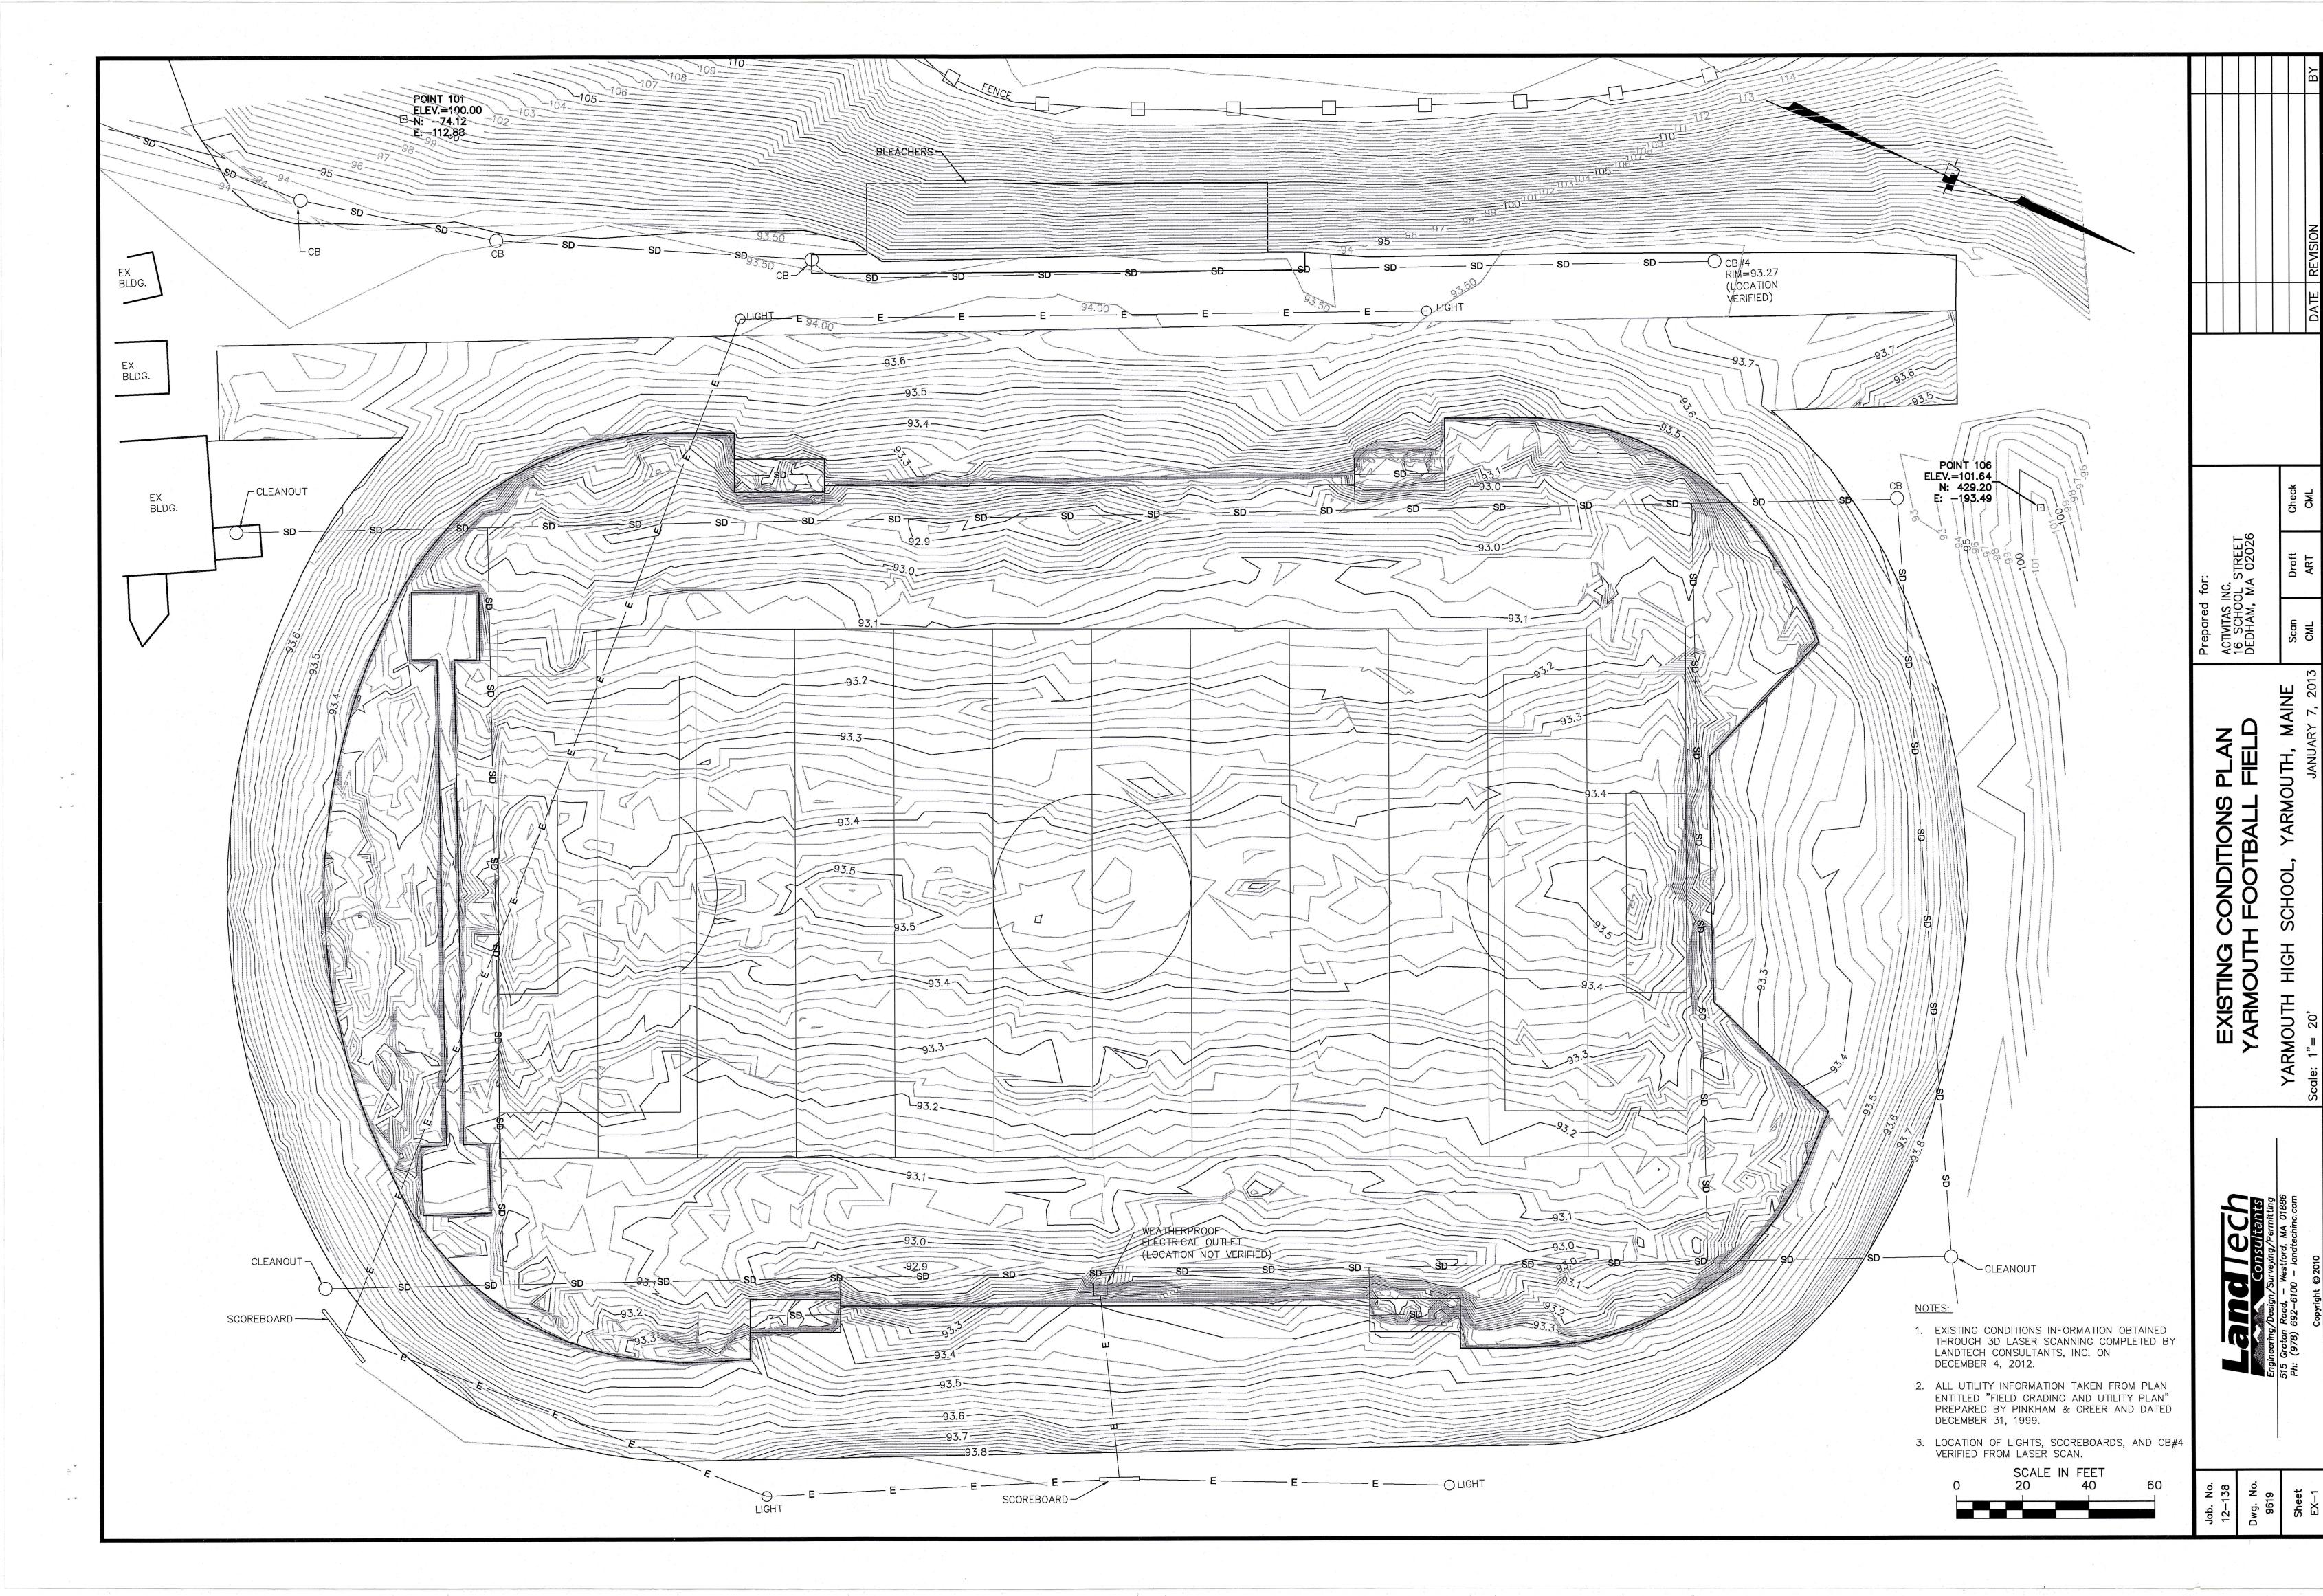

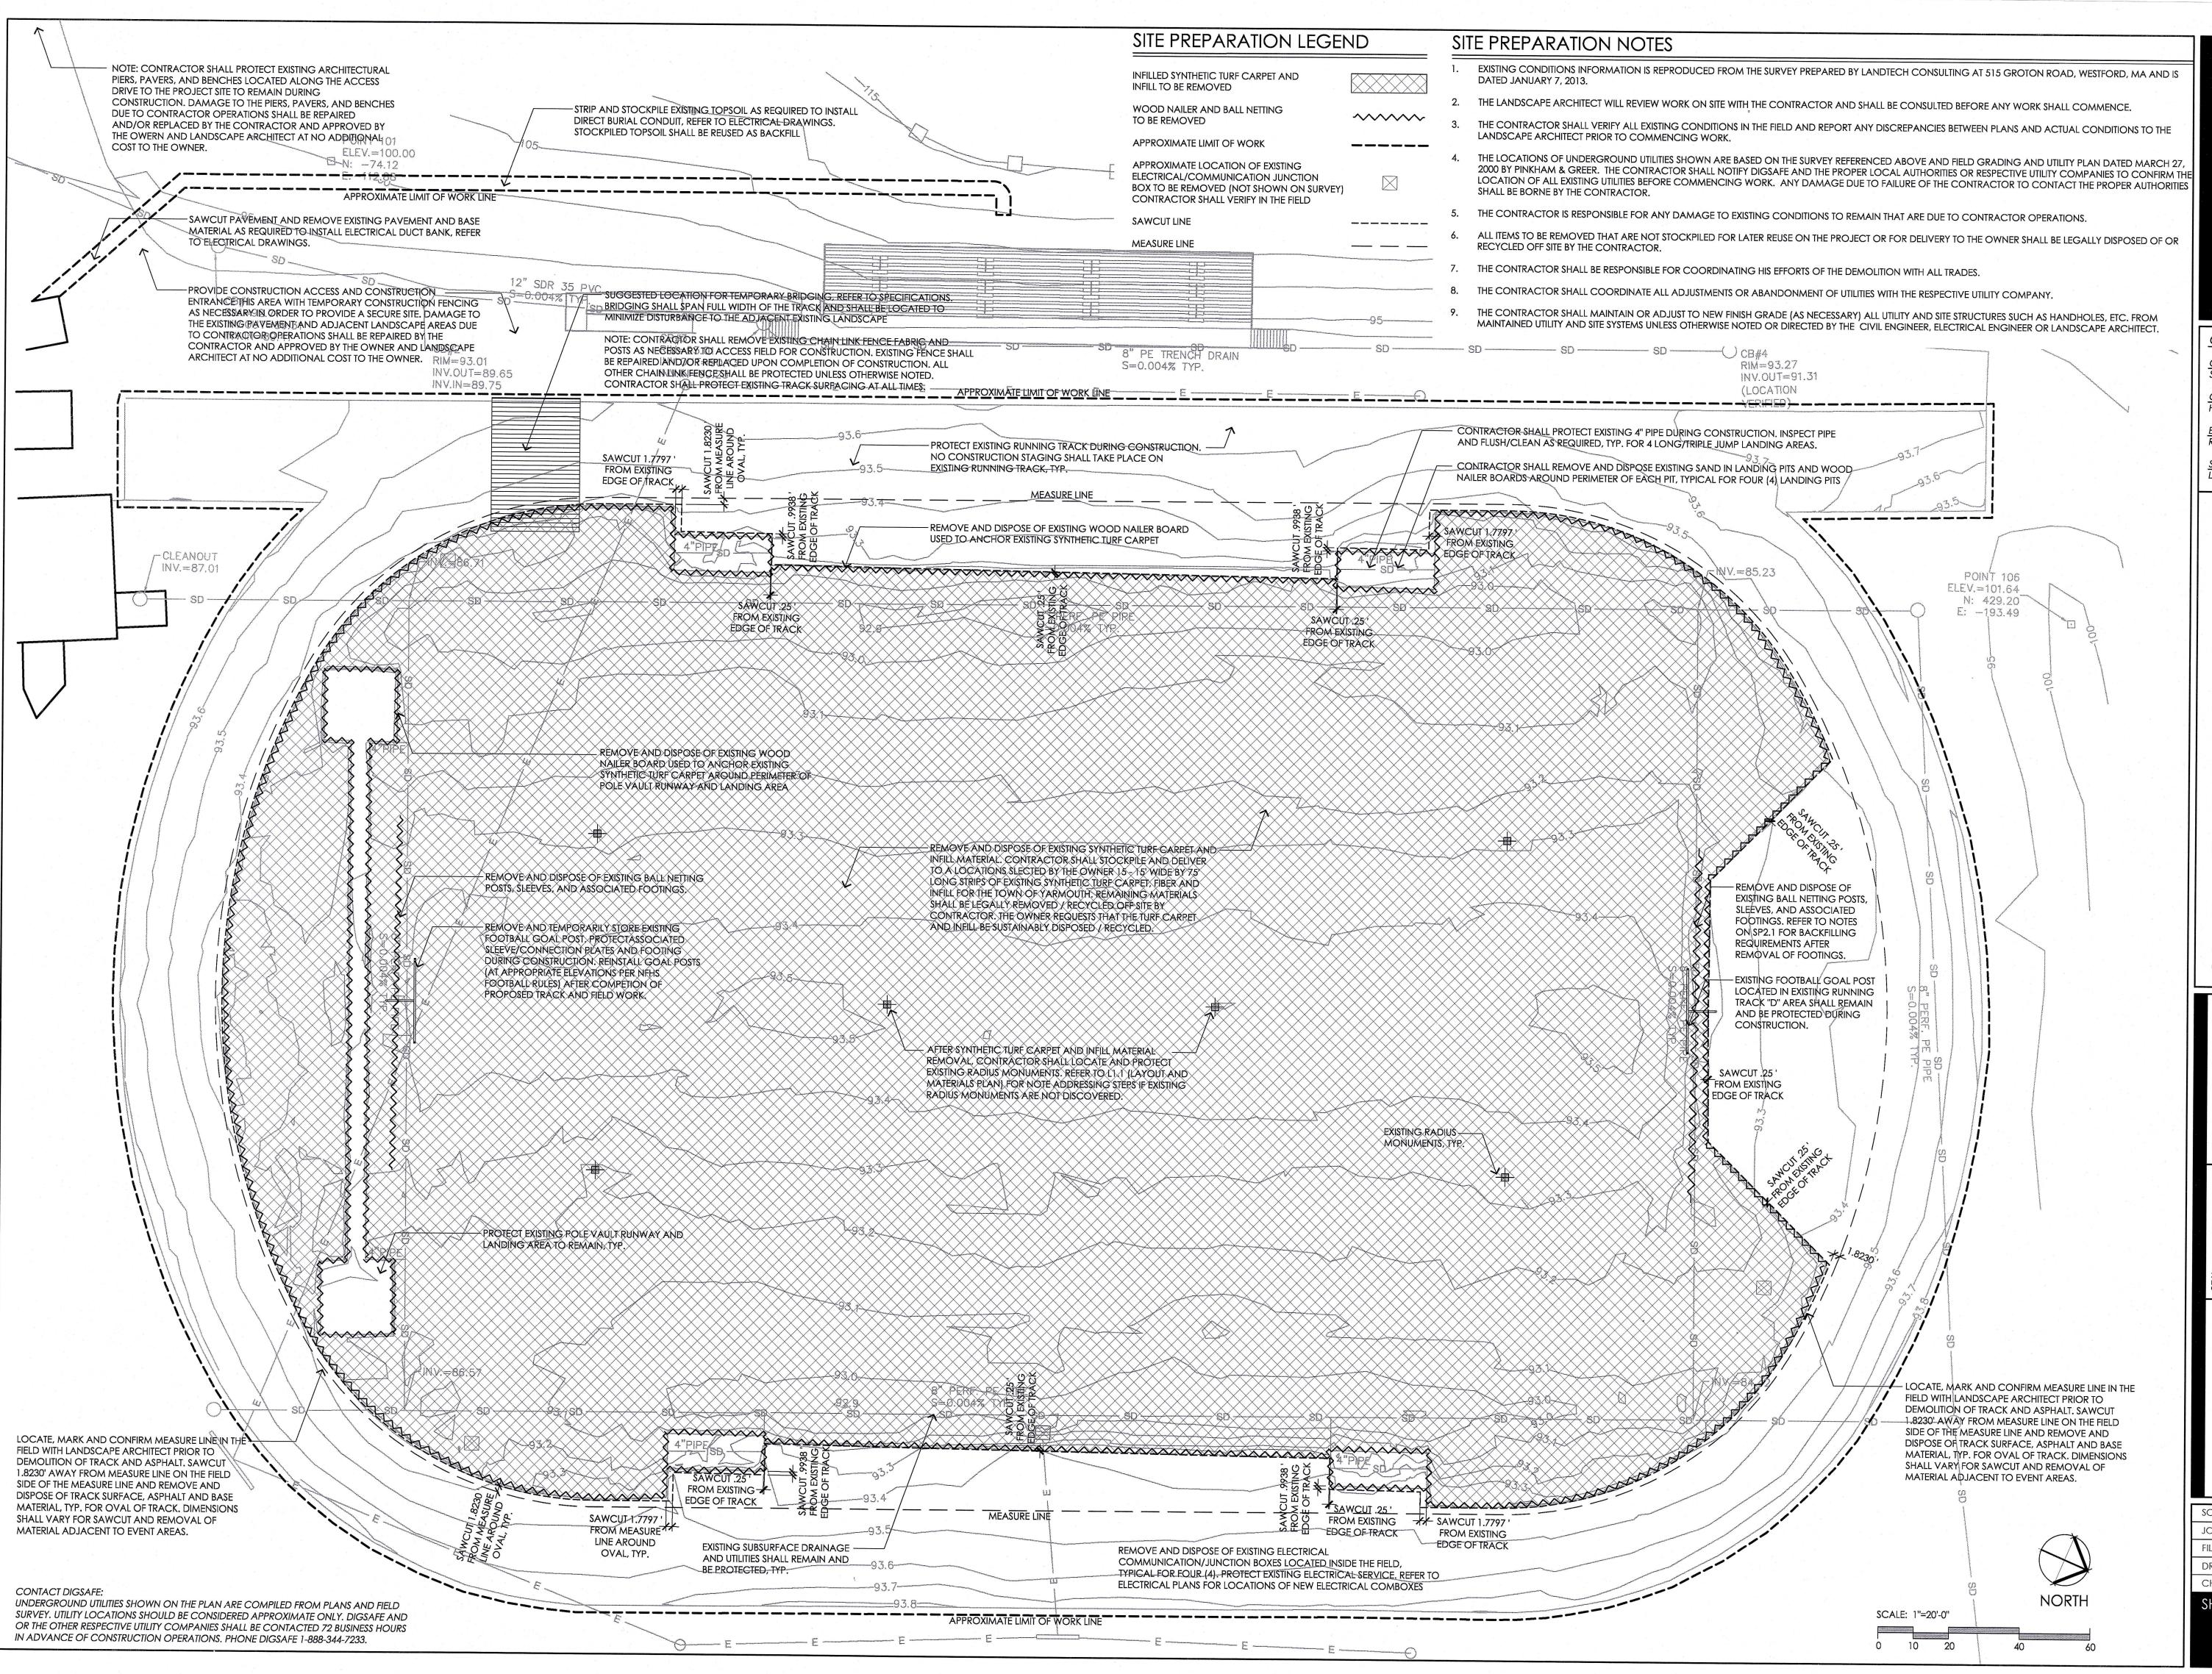

QCELINES

Planning 1 Landscape 1 Athletic Facilities
sixteen school street
dedham, massachusetts 02026-4310
telephone: (781) 326-2600
www.activitas.com

CONSULTANTS

CIVIL ENGINEER SAMIOTES CONSULTANTS, INC.

GEOTECHNICAL ENGINEER -HALEY & ALDRICH, INC.

RICHARD D. KIMBALL COMPANY

SURVEY LANDTECH CONSULTANTS

LANDTECH CONSULTANTS

70

IGH SCHOC

Yarmouth, Maine
SYNTHETIC TURE CARPET R

REV.:

ITE PREPARATION LAN

 SCALE:
 1"=20'-0"


 JOB NO:
 12002.00

 FILE:
 12002-SP1.1_SP_PLAN.dwg

 DRAWN:
 JJC

 CHECKED:
 MJN, EPM

SHEET NO:

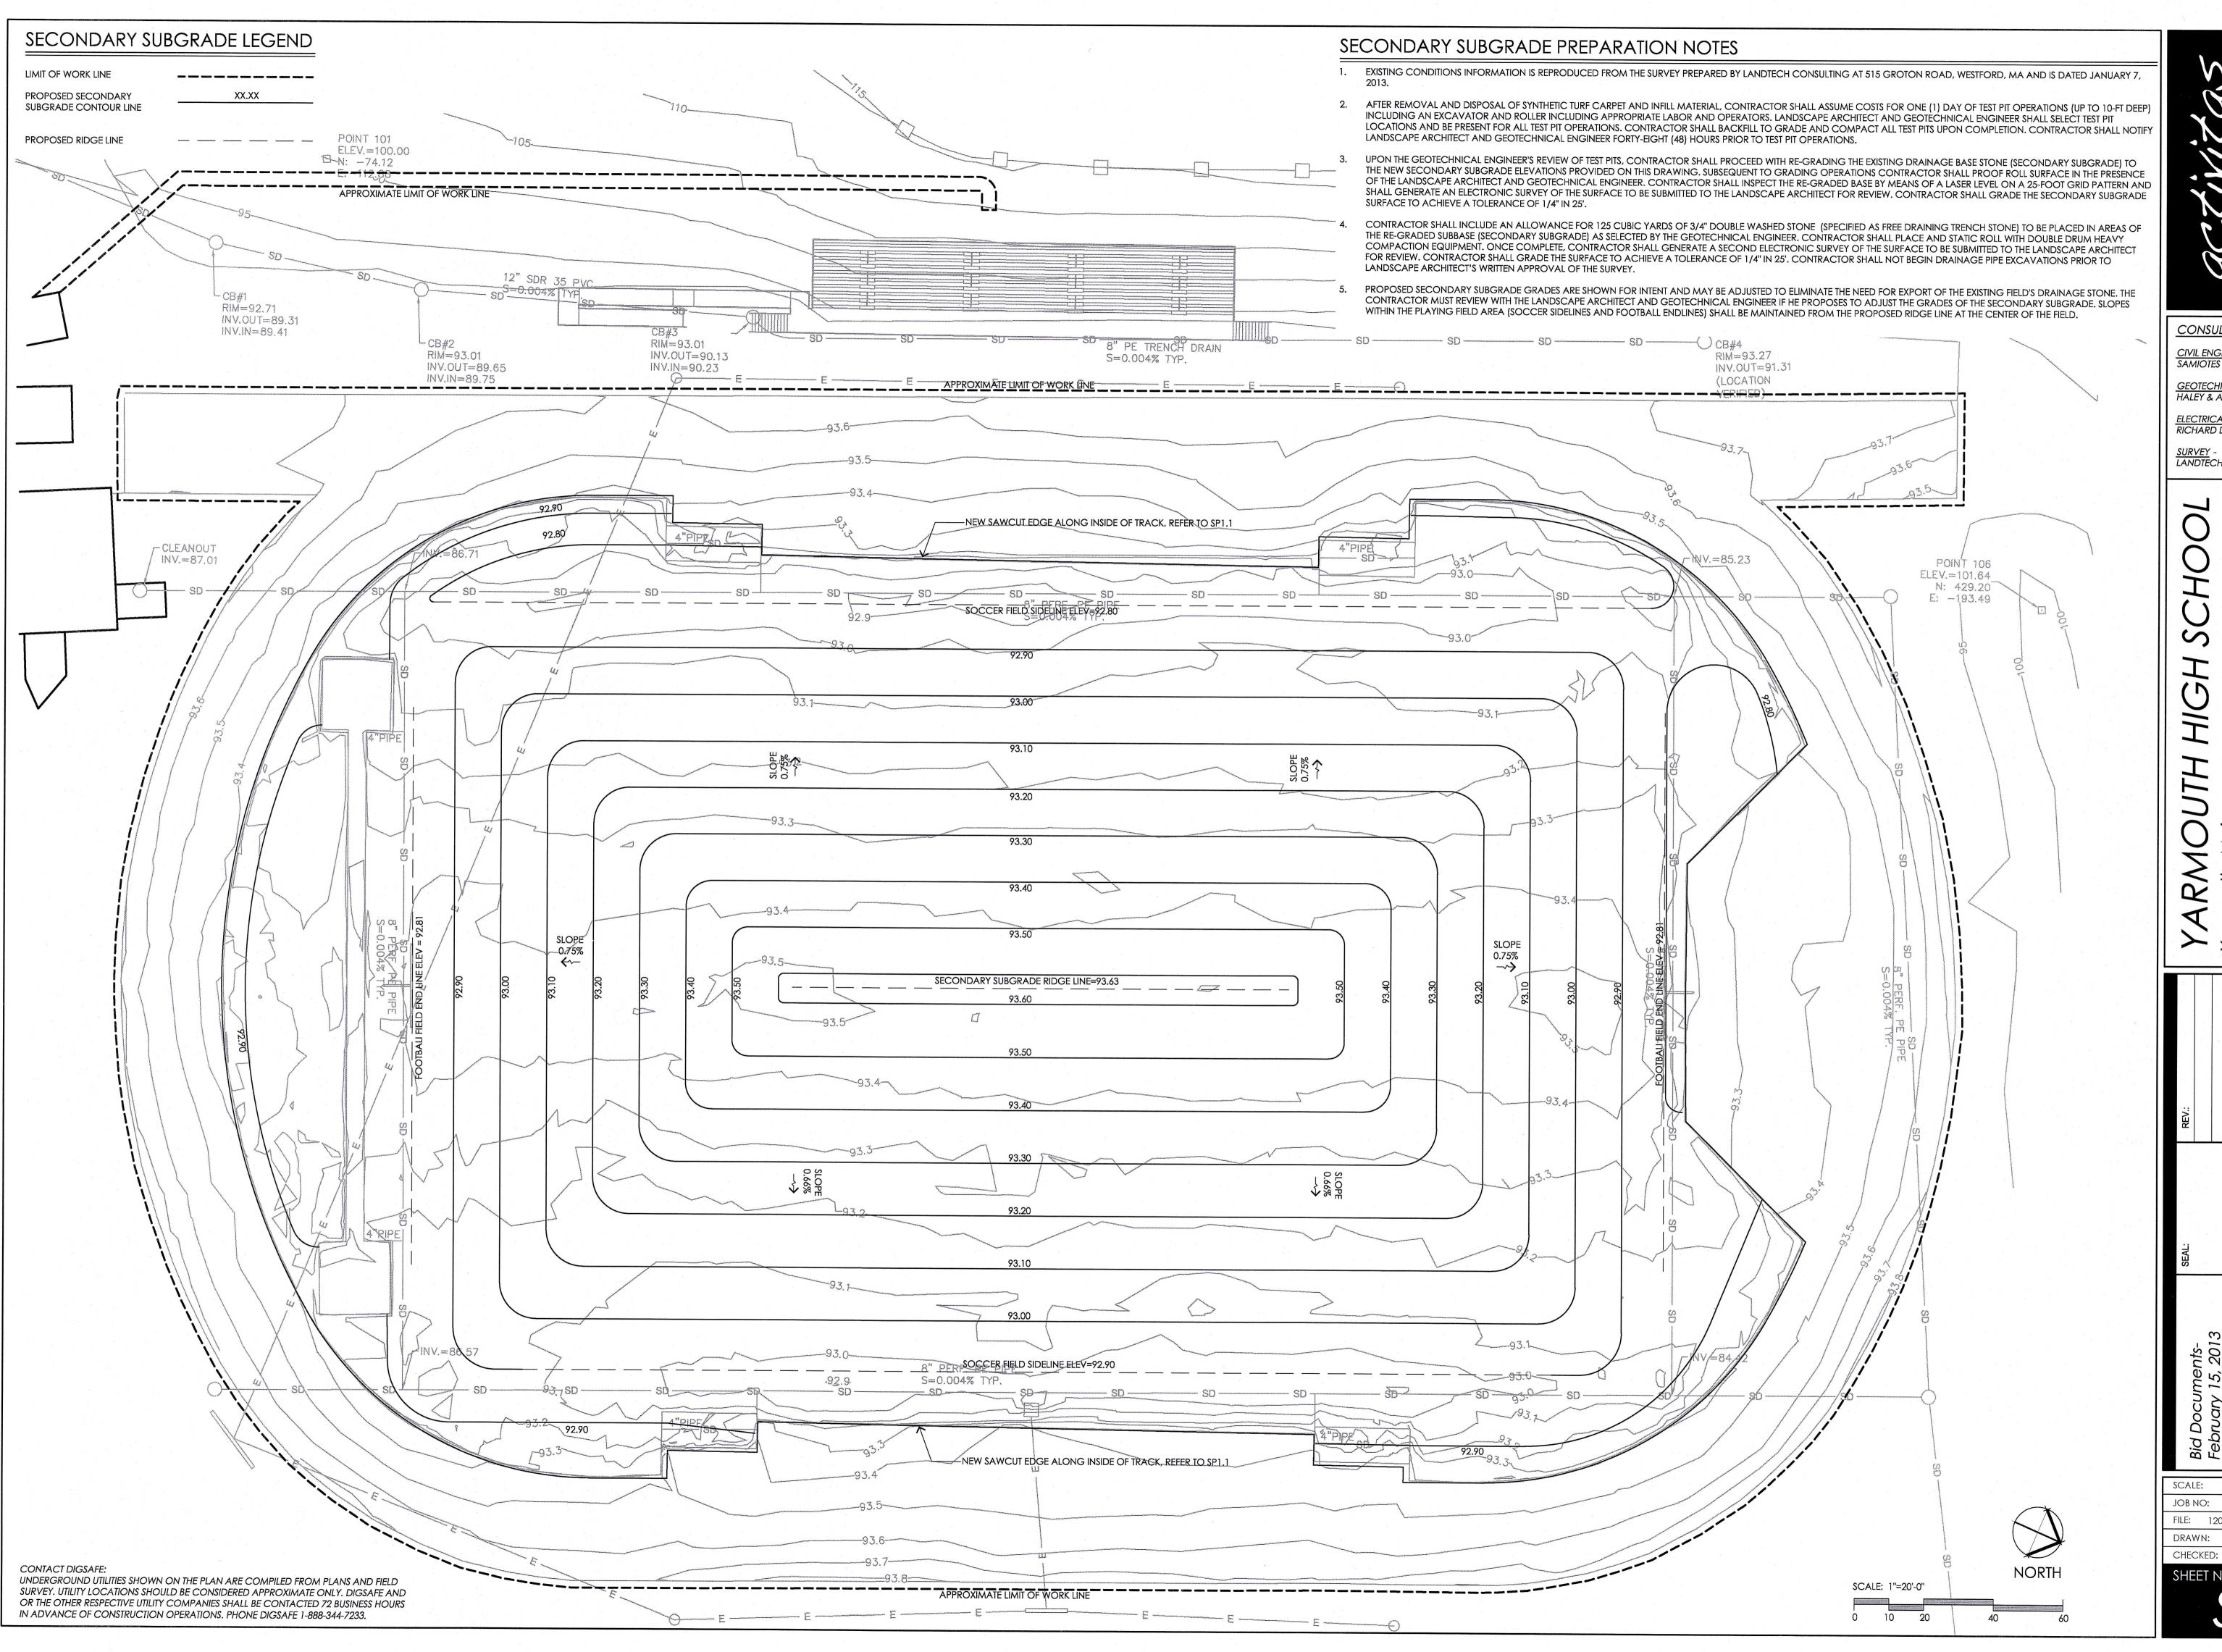

ACTINITED Sandscape 1 Achletic Facilities sixteen school street dedham, massachusetts 02026-4310 telephone: (781) 326-2600 www.activitas.com

CONSULTANTS

CIVIL ENGINEER SAMIOTES CONSULTANTS, INC

GEOTECHNICAL ENGINEER -HALEY & ALDRICH, INC. ELECTRICAL ENGINEER -RICHARD D. KIMBALL COMPANY

RICHARD D. KIMBALL COMPAI

SURVEY -LANDTECH CONSULTANTS

LANDTECH CONSULTANTS

SCHOOL

e RF CARPET REPLACEME

YARMOUTI Yarmouth, Maine SYNTHETIC TURF C

REV.:

CRADE PLAN

 SCALE:
 1"=20'-0"

 JOB NO:
 12002.00

 FILE:
 12002-SP2.1_SG_PLAN.dwg

 DRAWN:
 JJC

CHECKED:

MJN, EPM

SHEET NO:

CP 1

EARTHWORK NOTES

EXCAVATION SUPPORT

THE CONTRACTOR SHALL BE RESPONSIBLE FOR DESIGN AND CONSTRUCTION OF ALL NECESSARY EXCAVATION SUPPORT SYSTEMS AND OPEN-CUT EXCAVATIONS.

EXCAVATIONS AND THE EVALUATION OF THE NEED FOR EARTH SUPPORT SHALL BE PERFORMED BY A REGISTERED CIVIL ENGINEER IN THE STATE OF MAINE, RETAINED BY THE CONTRACTOR. THE DESIGN AND CONSTRUCTION OF ALL OPEN-CUT AND RETAINED EXCAVATIONS SHALL BE IN ACCORDANCE WITH ALL APPLICABLE LOCAL, STATE, AND OSHA REGULATIONS AND PRUDENT ENGINEERING JUDGEMENT BASED ON SITE CONDITIONS.

DEWATERING

THE CONTRACTOR SHALL CONTROL THE GRADING IN AREAS UNDER CONSTRUCTION ON THE SITE SO THAT THE SURFACE OF THE GROUND WILL PROPERLY SLOPE TO PREVENT ACCUMULATION OF WATER IN EXCAVATED AREAS AND ADJACENT PROPERTIES.

SHOULD SURFACE, RAIN OR GROUND WATER BE ENCOUNTERED DURING THE OPERATIONS, THE CONTRACTOR SHALL FURNISH AND OPERATE PUMPS OR OTHER EQUIPMENT, AND PROVIDE ALL NECESSARY PIPING TO KEEP ALL EXCAVATIONS CLEAR OF WATER AT ALL TIMES AND SHALL BE RESPONSIBLE FOR ANY DAMAGE TO WORK OR ADJACENT PROPERTIES FOR SUCH WATER. ALL PIPING EXPOSED ABOVE SURFACE FOR THIS USE, SHALL BE PROPERLY COVERED TO ALLOW FOOT TRAFFIC AND VEHICLES TO PASS WITHOUT OBSTRUCTION.

PRESENCE OF GROUND WATER IN SOIL WILL NOT CONSTITUTE A CONDITION FOR WHICH AN INCREASE IN THE CONTRACT PRICE MAY BE MADE. UNDER NO CIRCUMSTANCES SHALL CONCRETE FILL, SOIL FILL, LAYING OF PIPING OR INSTALLATION OF APPURTENANCES BE PLACED IN EXCAVATIONS CONTAINING FREE WATER. KEEP UTILITY TRENCHES FREE OF WATER UNTIL PIPE JOINT MATERIAL HAS HARDENED AND BACKFILLED TO PREVENT FLOATATION.

EXCAVATION

EXCAVATION SHALL INCLUDE THE REMOVAL OF ALL ENCOUNTERED MATERIALS INCLUDING BUT NOT LIMITED TOSOIL, COBBLES, BOULDERS, ASPHALT PAVEMENT, REINFORCED CONCRETE, UNREINFORCED CONCRETE, UTILITIES, GRANITE BLOCKS, MISCELLANEOUS DEBRIS, BURIED AND ABANDONED FOUNDATIONS, SITEIMPROVEMENTS, INCIDENTAL STRUCTURES, AND ALL OTHER MATERIALS NECESSARY TO COMPLETE THE WORK OF THIS SECTION.

ALL EXCAVATION AND BACKFILLING FOR STRUCTURES, UTILITIES, AND SITE IMPROVEMENTS SHALL BE PERFORMED IN-THE-DRY.

WHERE EXCAVATIONS ARE REQUIRED TO BE MADE INTO THE ZONE OF INFLUENCE BELOW A FOUNDATION, UTILITY, TRACK SURFACING OR OTHER STRUCTURE, THE CONTRACTOR SHALL DESIGN AN EXCAVATION SUPPORT SYSTEM TO PROTECT THE STRUCTURE FROM MOVEMENT AND TO PROTECT THE SOIL WITHIN THE ZONE OF INFLUENCE FROM LOOSENING AND BECOMING DISTURBED. ZONE OF INFLUENCE IS DEFINED AS: THE ZONE BENEATH IMAGINARY LINES EXTENDING FROM POINTS 1 FT LATERALLY BEYOND FOOTING OUTER EDGES AND DOWN ON A 1H:1V SLOPE.

THE CONTRACTOR SHALL CONTROL THE GRADING TO PREVENT WATER FROM RUNNING TO EXCAVATED AREAS OR DAMAGING SUBGRADES, SECONDARY SUBGRADES OR SITE IMPROVEMENTS.

WHERE FINAL SUBGRADE OR SECONDARY SUBGRADES HAVE BEEN SOFTENED, FROZEN, OR OTHERWISE DISTURBED DUE TO THE PRESENCE OF WATER, UNFAVORABLE WEATHER, OR ANY OTHER CAUSE, REMOVE THE MATERIAL AND REPLACE WITH GRANULAR FILL AT NO ADDITIONAL COST TO THE OWNER.

EXERCISE CARE TO PRESERVE THE MATERIAL BELOW AND BEYOND THE LINES OF EXCAVATION. WHERE EXCAVATION IS CARRIED OUT THROUGH ERROR BELOW INDICATED GRADE OR BEYOND THE LINES OF EXCAVATION, BACKFILL TO THE INDICATED GRADE WITH A PRE-APPROVED AND SUITABLE MATERIAL (AS DETERMINED BY THE LANDSCAPE ARCHITECT AND GEOTECHNICAL ENGINEER) AT NO ADDITIONAL COST TO THE OWNER.

TRENCH EXCAVATION

DEFINITIONS:

"TRENCH EXCAVATION" SHALL BE DEFINED AS AN EXCAVATION IN WHICH THE BOTTOM WIDTH DOES NOT EXCEED SEVEN FEET AND THE WIDTH DOES NOT EXCEED TWICE THE DEPTH.

THE WORDS "INVERT" OR "INVERT ELEVATION" AS USED HEREIN MEAN THE ELEVATION AT THE INSIDE BOTTOM OF PIPE OR CHANNEL.

THE WORDS "BOTTOM OF THE PIPE" AS USED HEREIN MEAN THE ELEVATION AT THE BASE OF THE PIPE AT ITS OUTER SURFACE.

TRENCH EXCAVATIONS SHALL BE OF SUFFICIENT WIDTH AND DEPTH AT ALL POINTS TO ALLOW PIPES TO BE LAID AND APPURTENANT WORK TO BE BUILT IN A WORKMANLIKE MANNER AND, WHEN NEEDED, TO ALLOW FOR SHEETING AND SHORING, PUMPING AND DRAINING, AND REMOVING AND REPLACING ANY UNSUITABLE MATERIALS.

THE CONTRACTOR SHALL SHORE ALL TRENCHES, AS REQUIRED TO PROTECT SITE IMPROVEMENTS (EXISTING AND PROPOSED).

COORDINATE ALL WORK WITH THE UTILITY COMPANIES AND COMPLY WITH UTILITY COMPANY BACKFILL REQUIREMENTS.

REMOVE AND DISPOSE OF SOILS EXCAVATED FROM UTILITY TRENCHES, UNLESS OTHERWISE NOTED OR DIRECTED BY THE LANDSCAPE ARCHITECT OR GEOTECHNICAL ENGINEER.

REMOVE ALL HARD SPOTS (COBBLES, BOULDERS, CONCRETE, BRICK, ETC.) AT BOTTOM OF UTILITY TRENCHES. OVER-EXCAVATE AT LEAST 12 IN. BELOW ALL UTILITIES TO EXPOSE AND REMOVE HARD SPOTS.

BACKFILL TRENCHES AS SOON AS POSSIBLE AFTER TRENCH EXCAVATION.

IF SOFT OR UNSTABLE MATERIALS, AS DETERMINED BY THE GEOTECHNICAL ENGINEER, ARE ENCOUNTERED AT THE BOTTOM OF THE UTILITY BEDDING MATERIALS, THE UNSTABLE SOILS SHALL BE OVER-EXCAVATED 2 FT BELOW THE BOTTOM OF THE UTILITY BEDDING MATERIAL. PLACE A SUB-BEDDING MATERIAL CONSISTING OF GRANULAR FILL OR APPROVED EQUAL TO THE BOTTOM OF THE UTILITY BEDDING MATERIALS. IN ALL CASES, THE CONTRACTOR SHALL CONDUCT ALL WORK NECESSARY TO PROVIDE A STABLE SUBGRADE TO PLACE THE BEDDING AND CONSTRUCT THE UTILITY.

UNAUTHORIZED EXCAVATIONS

UNAUTHORIZED EXCAVATION CONSISTS OF REMOVAL OF MATERIALS BEYOND REQUIRED DESIGN SUBGRADE OR SECONDARY SUBGRADE ELEVATIONS OR DIMENSIONS WITHOUT SPECIFIC DIRECTION FROM THE LANDSCAPE ARCHITECT. UNAUTHORIZED EXCAVATION, AS WELL AS REMEDIAL WORK DIRECTED BY THE OWNER, SHALL BE AT THE CONTRACTOR'S EXPENSE.

BACKFILL AND COMPACT UNAUTHORIZED EXCAVATIONS WITH MATERIALS AS SPECIFIED BY THE LANDSCAPE ARCHITECT OR GEOTECHNICAL ENGINEER AT NO ADDITIONAL COST TO THE OWNER

SHORING AND BRACING


PROVIDE SHORING AND BRACING AT EXCAVATIONS, AS REQUIRED, TO ASSURE COMPLETE SAFETY AGAINST COLLAPSE OF EARTH AT SIDES OF EXCAVATIONS OR EARTHEN SLOPES

SHORING AND BRACING OF TRENCHES AND OTHER EXCAVATIONS SHALL, AT A MINIMUM, BE IN ACCORDANCE WITH THE LATEST REQUIREMENTS OF THE OCCUPATIONAL SAFETY AND HEALTH ADMINISTRATION (OSHA) REGULATIONS.

EXCAVATION SUPPORT SYSTEMS SHALL BE DESIGNED TO SUPPORT EARTH PRESSURES, HYDROSTATIC PRESSURES, SURCHARGE LOADS AND OTHER FORCES FROM EXISTING SITE CONDITIONS, STORED MATERIAL, AND CONSTRUCTION EQUIPMENT.

ALL SHORING AND BRACING NOT ORDERED LEFT IN-PLACE SHALL BE CAREFULLY REMOVED IN SUCH A MANNER AS NOT TO ENDANGER THE CONSTRUCTION OF OTHER STRUCTURES, UTILITIES, OR PROPERTY WHETHER PUBLIC OR PRIVATE. ALL VOIDS LEFT AFTER WITHDRAWAL OF SHORING SHALL BE IMMEDIATELY REFILLED WITH SAND AND RAMMED WITH TOOLS ESPECIALLY ADAPTED TO THAT PURPOSE OR OTHERWISE COMPACTED AS DIRECTED TO ACHIEVE THE REQUIRED SOIL DENSITY.

SHORING AND BRACING SHALL NOT CONSTITUTE A CONDITION FOR WHICH AN INCREASE MAY BE MADE IN THE CONTRACT PRICE WITH THE EXCEPTION THAT IF THE OWNER DIRECTS IN WRITING THAT CERTAIN SHORING SHALL BE LEFT IN-PLACE, THE CONTRACT WILL BE ADJUSTED IN ACCORDANCE WITH GENERAL CONDITIONS.

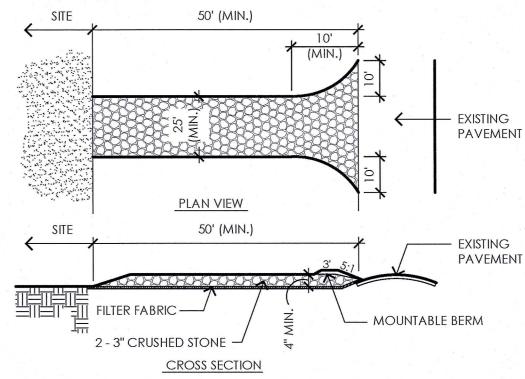

NOTES:

- 1. ENTRANCE WIDTH SHALL BE TWENTY-FIVE (25) FOOT MINIMUM, BUT NOT LESS THAN THE FULL WIDTH AT POINTS WHERE INGRESS OR EGRESS OCCURS.
- 2. THE ENTRANCE SHALL BE MAINTAINED IN A CONDITION WHICH SHALL PREVENT TRACKING OR FLOWING OF SEDIMENT ONTO PUBLIC RIGHTS-OF-WAY. THIS MAY REQUIRE PERIODIC TOP DRESSING WITH ADDITIONAL STONE AS CONDITIONS DEMAND AND REPAIR OR CLEANOUT OF ANY MEASURES USED TO TRAP SEDIMENT. ALL SEDIMENT SPILLED, DROPPED, WASHED OR TRACKED ONTO PUBLIC RIGHTS-OF-WAY MUST BE REMOVED IMMEDIATELY. BERM SHALL BE PERMITTED. PERIODIC INSPECTION AND MAINTENANCE SHALL BE PROVIDED AS NEEDED.



SCALE: N.T.S.

ACTIVITES

Planning 1 LandScape 1 Athletic Facilities
sixteen school street
dedham, massachusetts 02026-4310
telephone: (781) 326-2600
www.activitas.com

CONSULTANTS

<u>CIVIL ENGINEER</u> -SAMIOTES CONSULTANTS, INC. GEOTECHNICAL ENGINEER -

ELECTRICAL ENGINEER -RICHARD D. KIMBALL COMPANY

<u>SURVEY</u> -LANDTECH CONSULTANTS

HALEY & ALDRICH, INC.

Z

MOUIH HIGH SCH h, Maine TIC TURF CARPET REPLACEME

REV.:

y 15, 2013 HWORK S

SCALE: AS NOTED

JOB NO: 12002.00


FILE; 2002-SP3.1_EARTH_NOTES.dwg

DRAWN: JJC

HEET NO:

SP3.

MJN, EPM

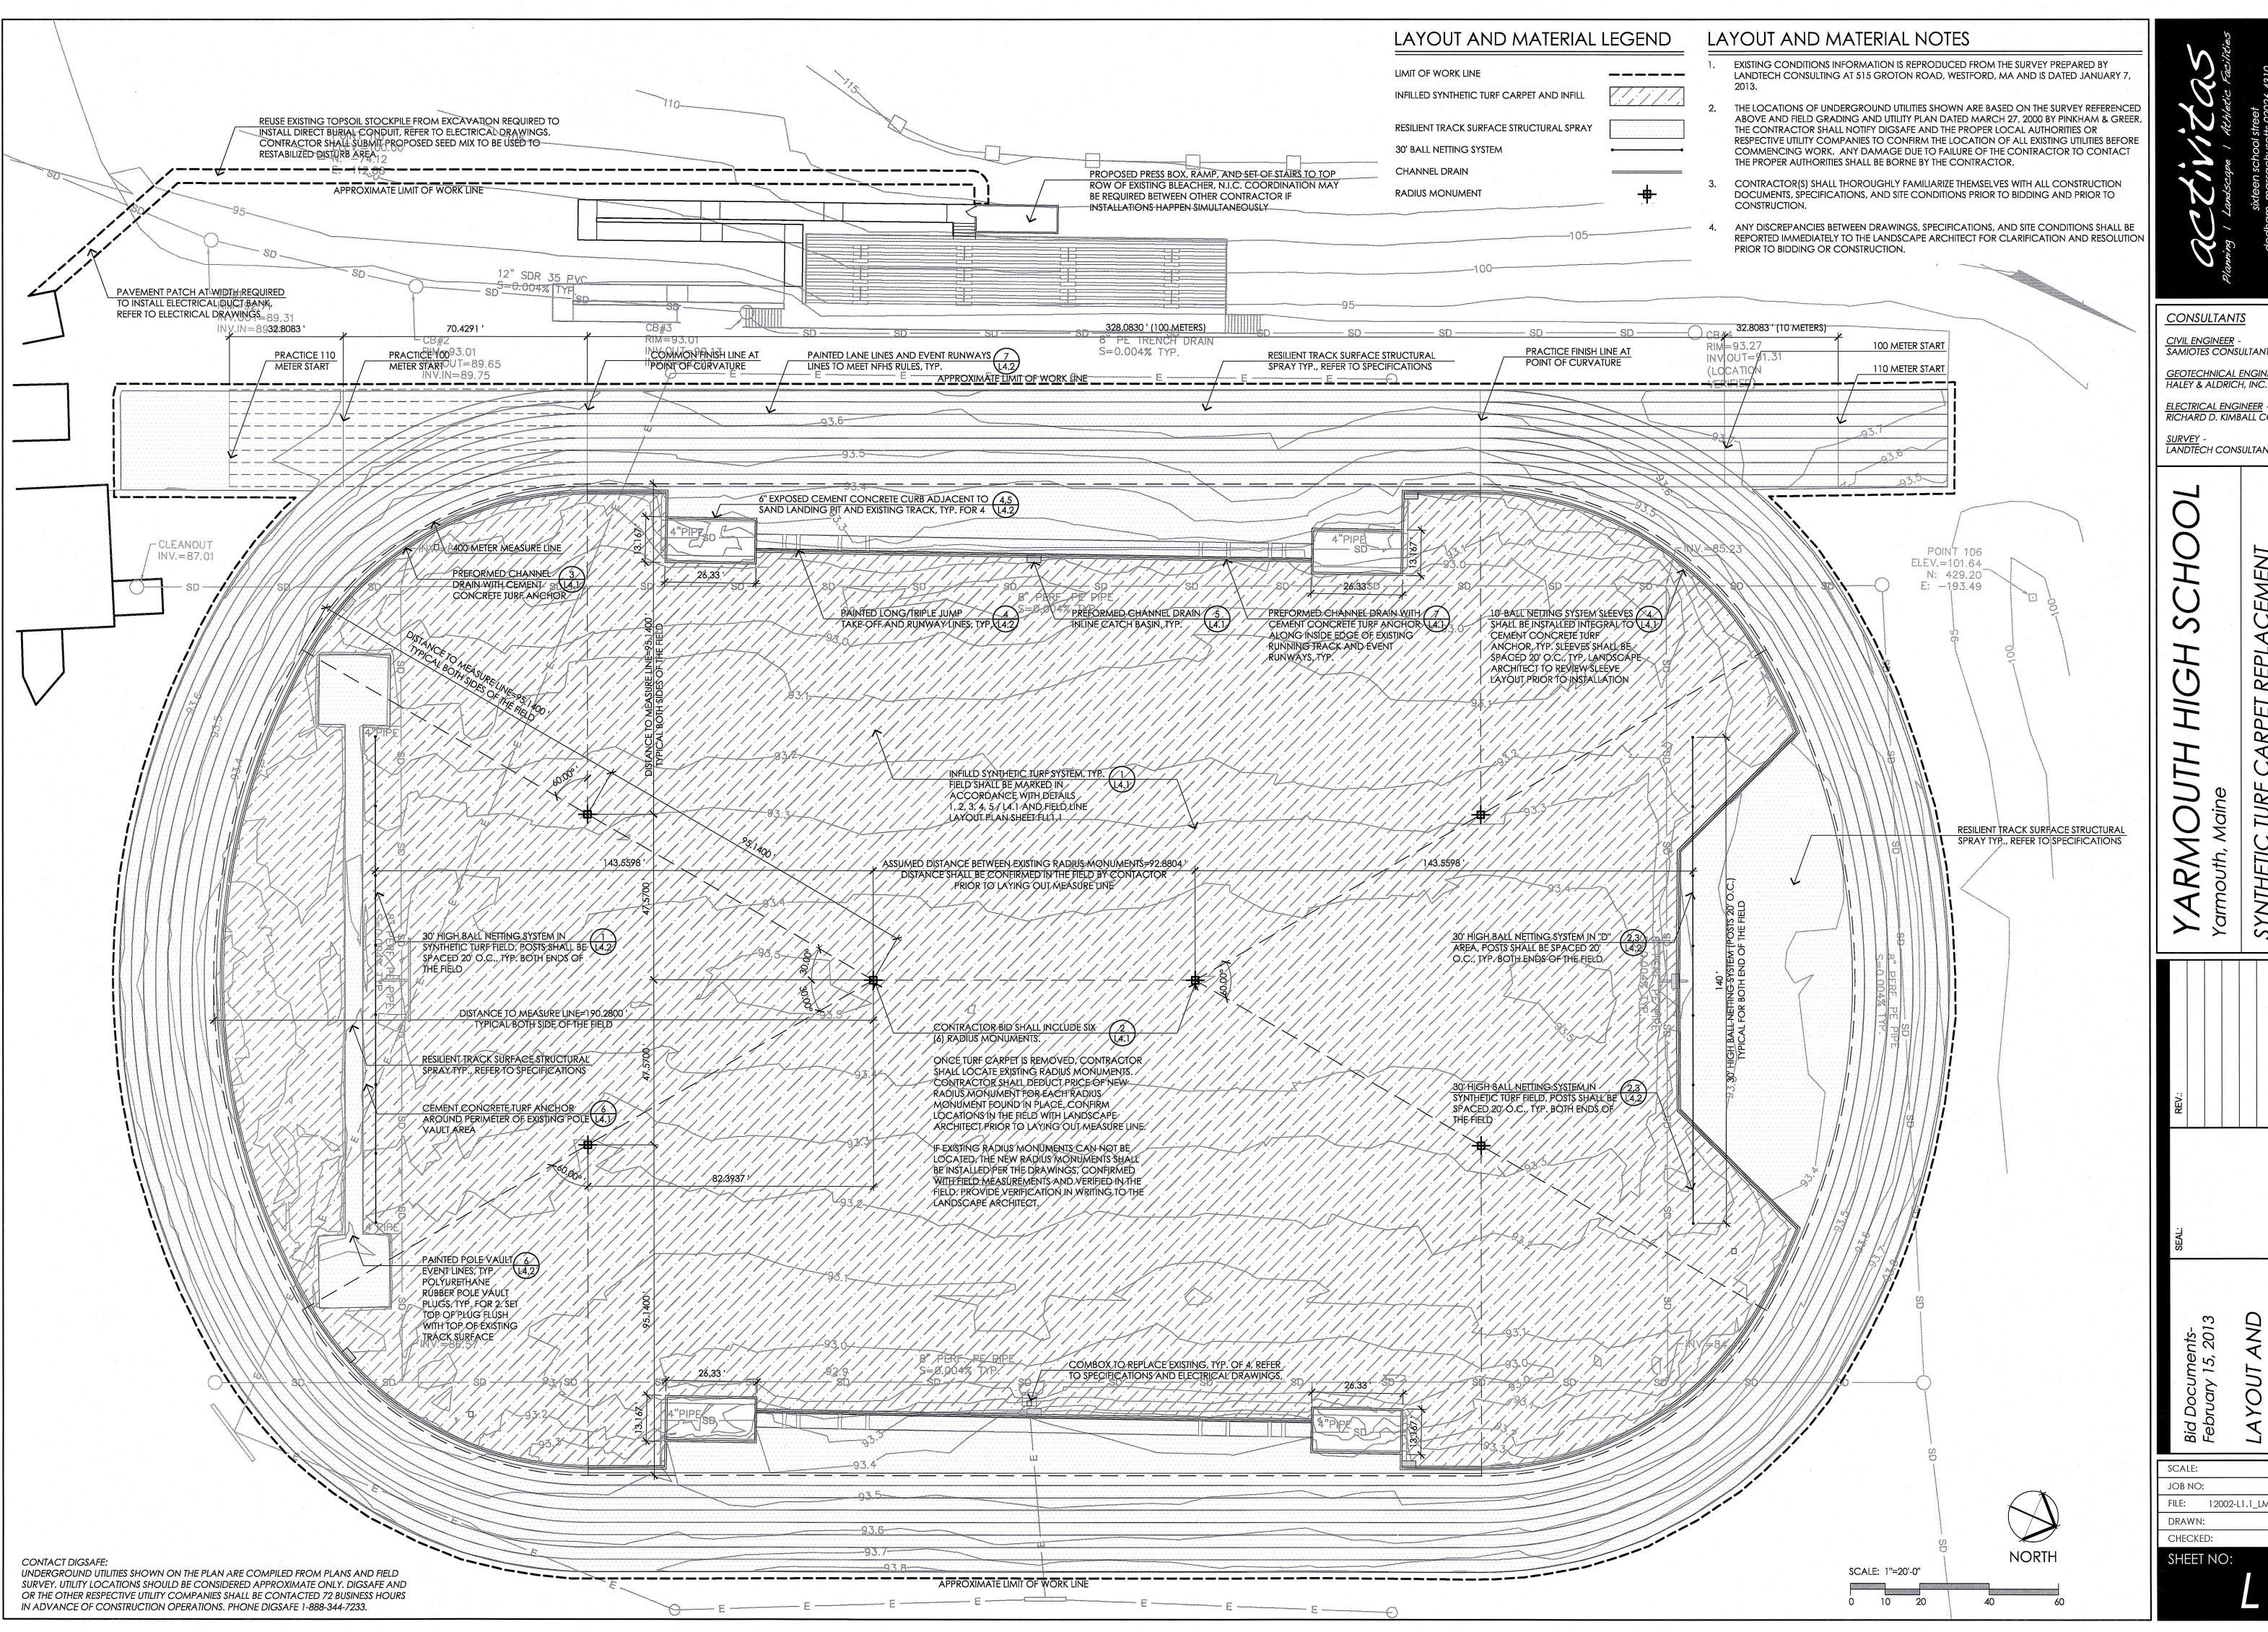

CONSULTANTS GEOTECHNICAL ENGINEER


> ELECTRICAL ENGINEER RICHARD D. KIMBALL COMPANY

SURVEY -LANDTECH CONSULTANTS

1"=20'-0" 12002.00 FILE: 12002-L1.1_LM_PLAN.dwg JJC

MJN, EPM

CHECKED: SHEET NO:

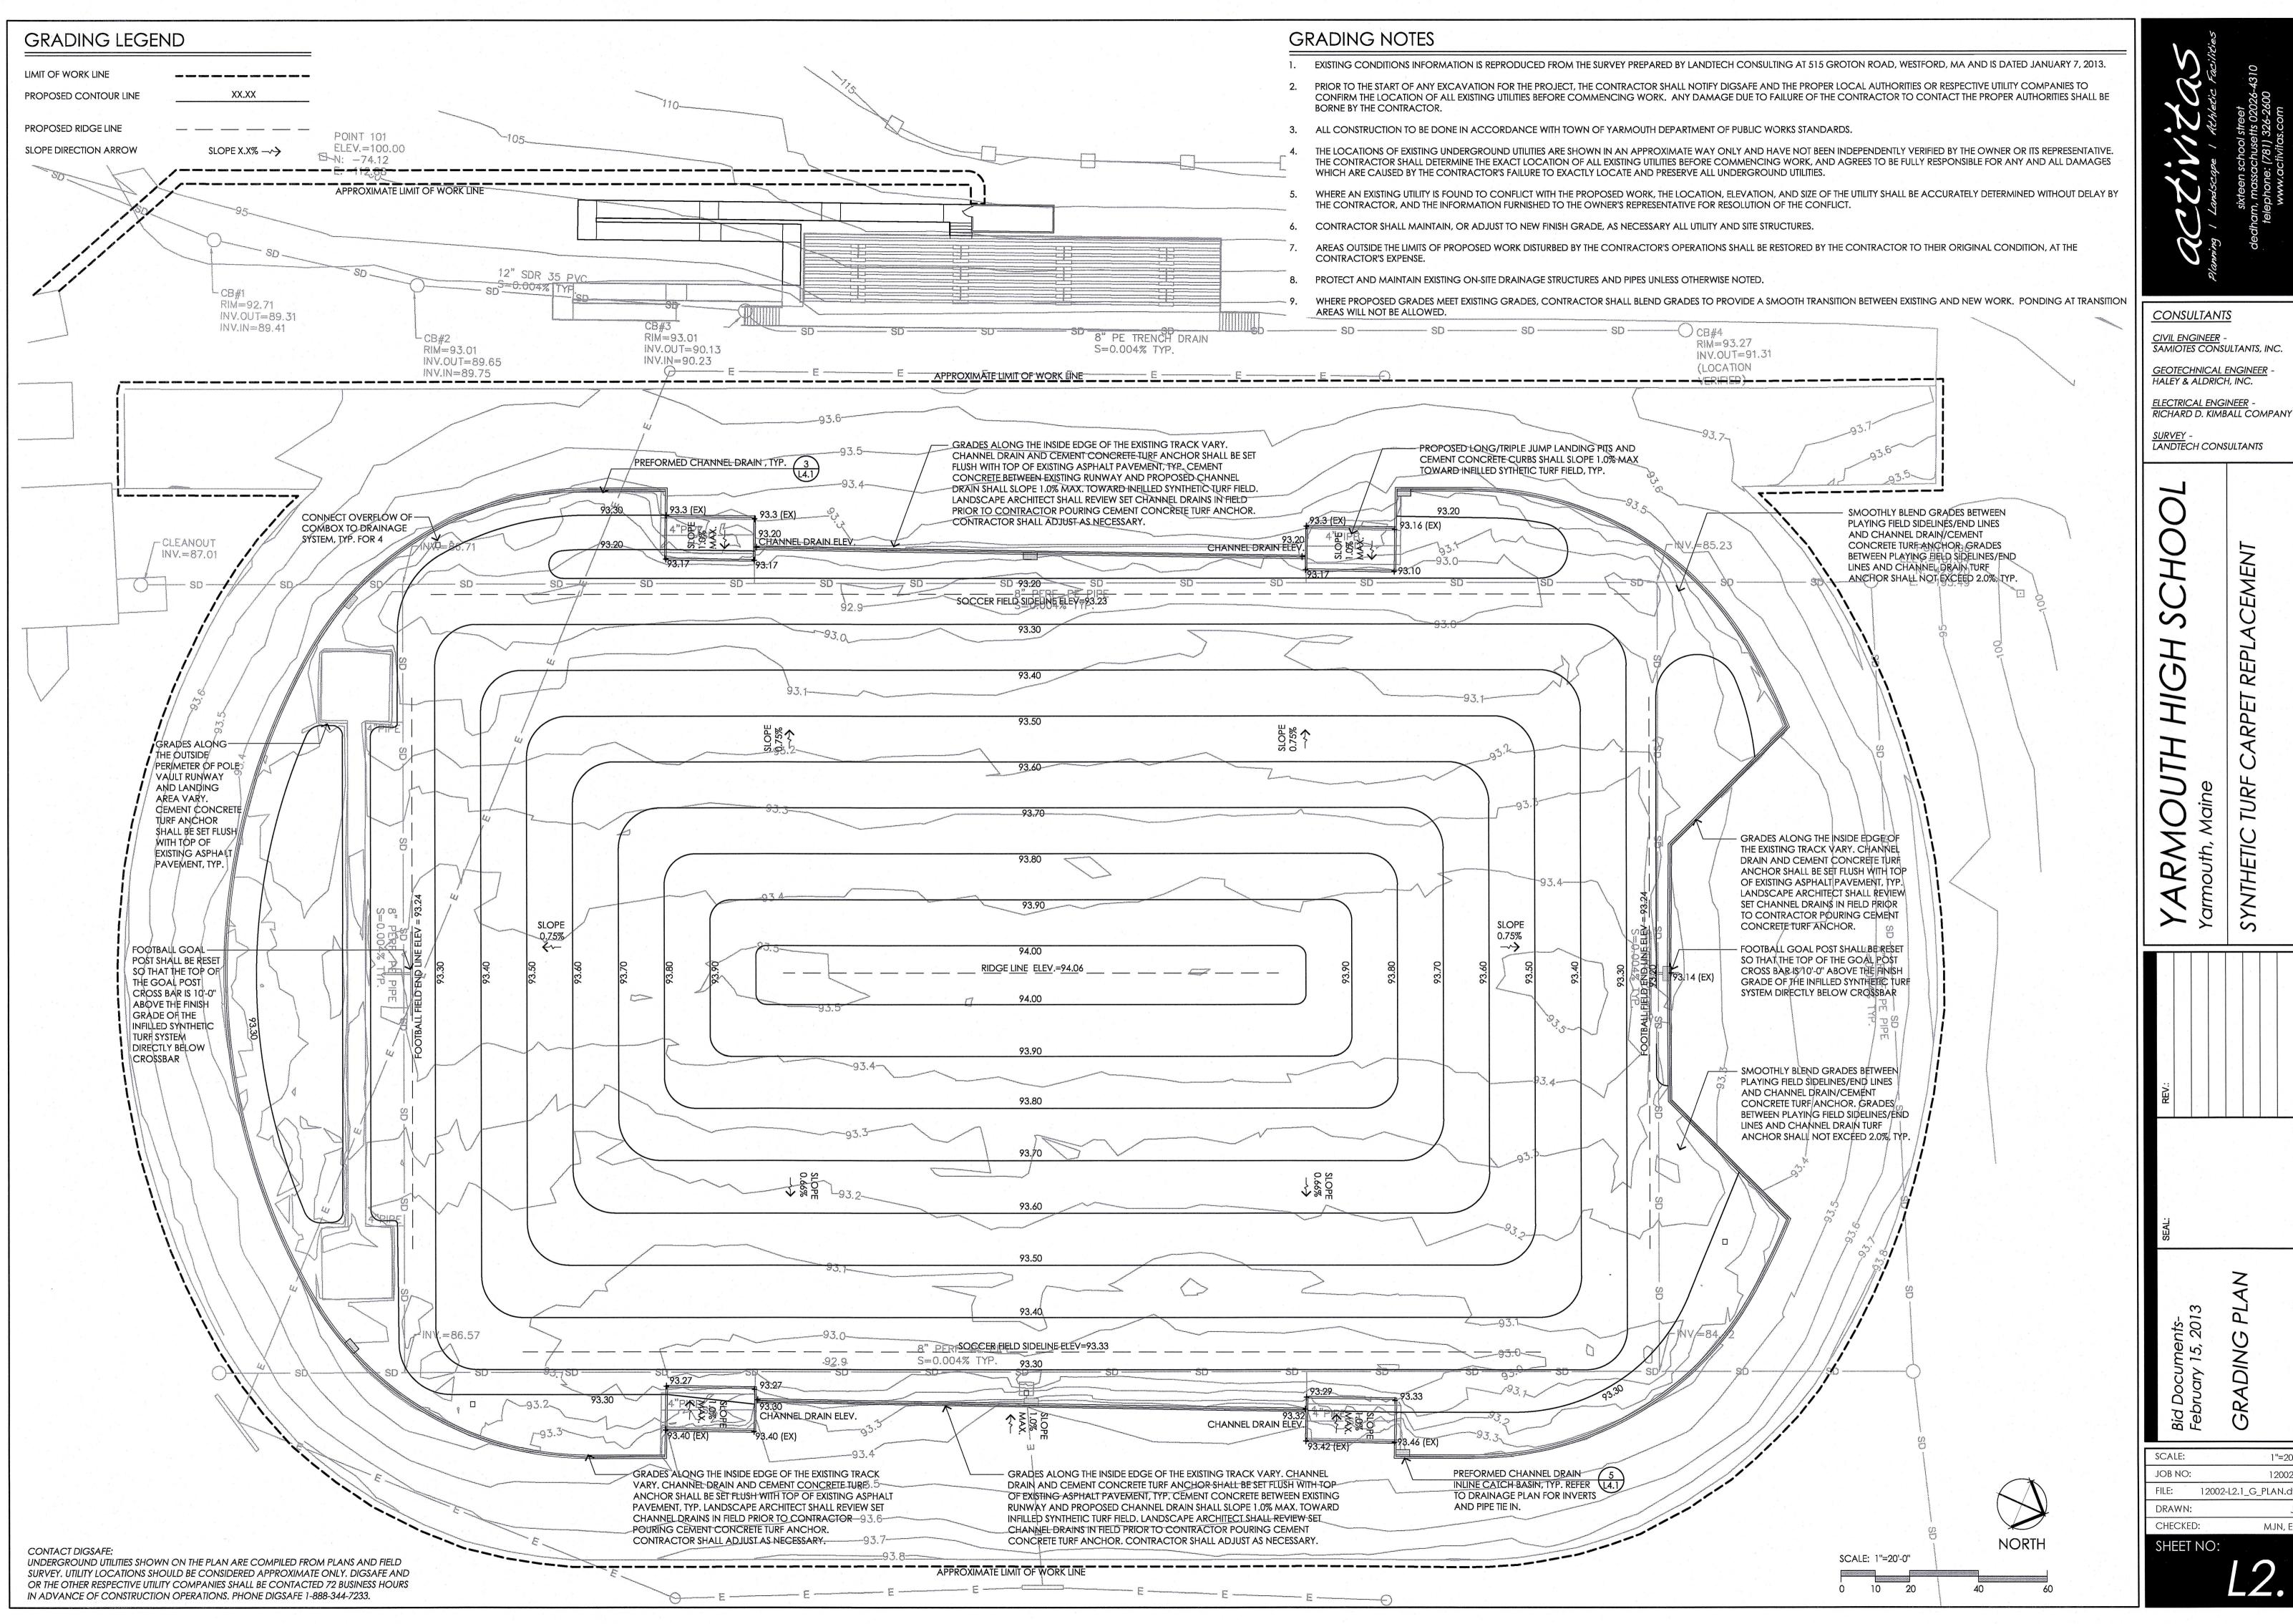

CONSULTANTS


GEOTECHNICAL ENGINEER HALEY & ALDRICH, INC.


<u>SURVEY</u> -LANDTECH CONSULTANTS


1"=20'-0"


JOB NO: 12002.00 12002-L2.1_G_PLAN.dwg CHECKED: MJN, EPM

SHEET NO:

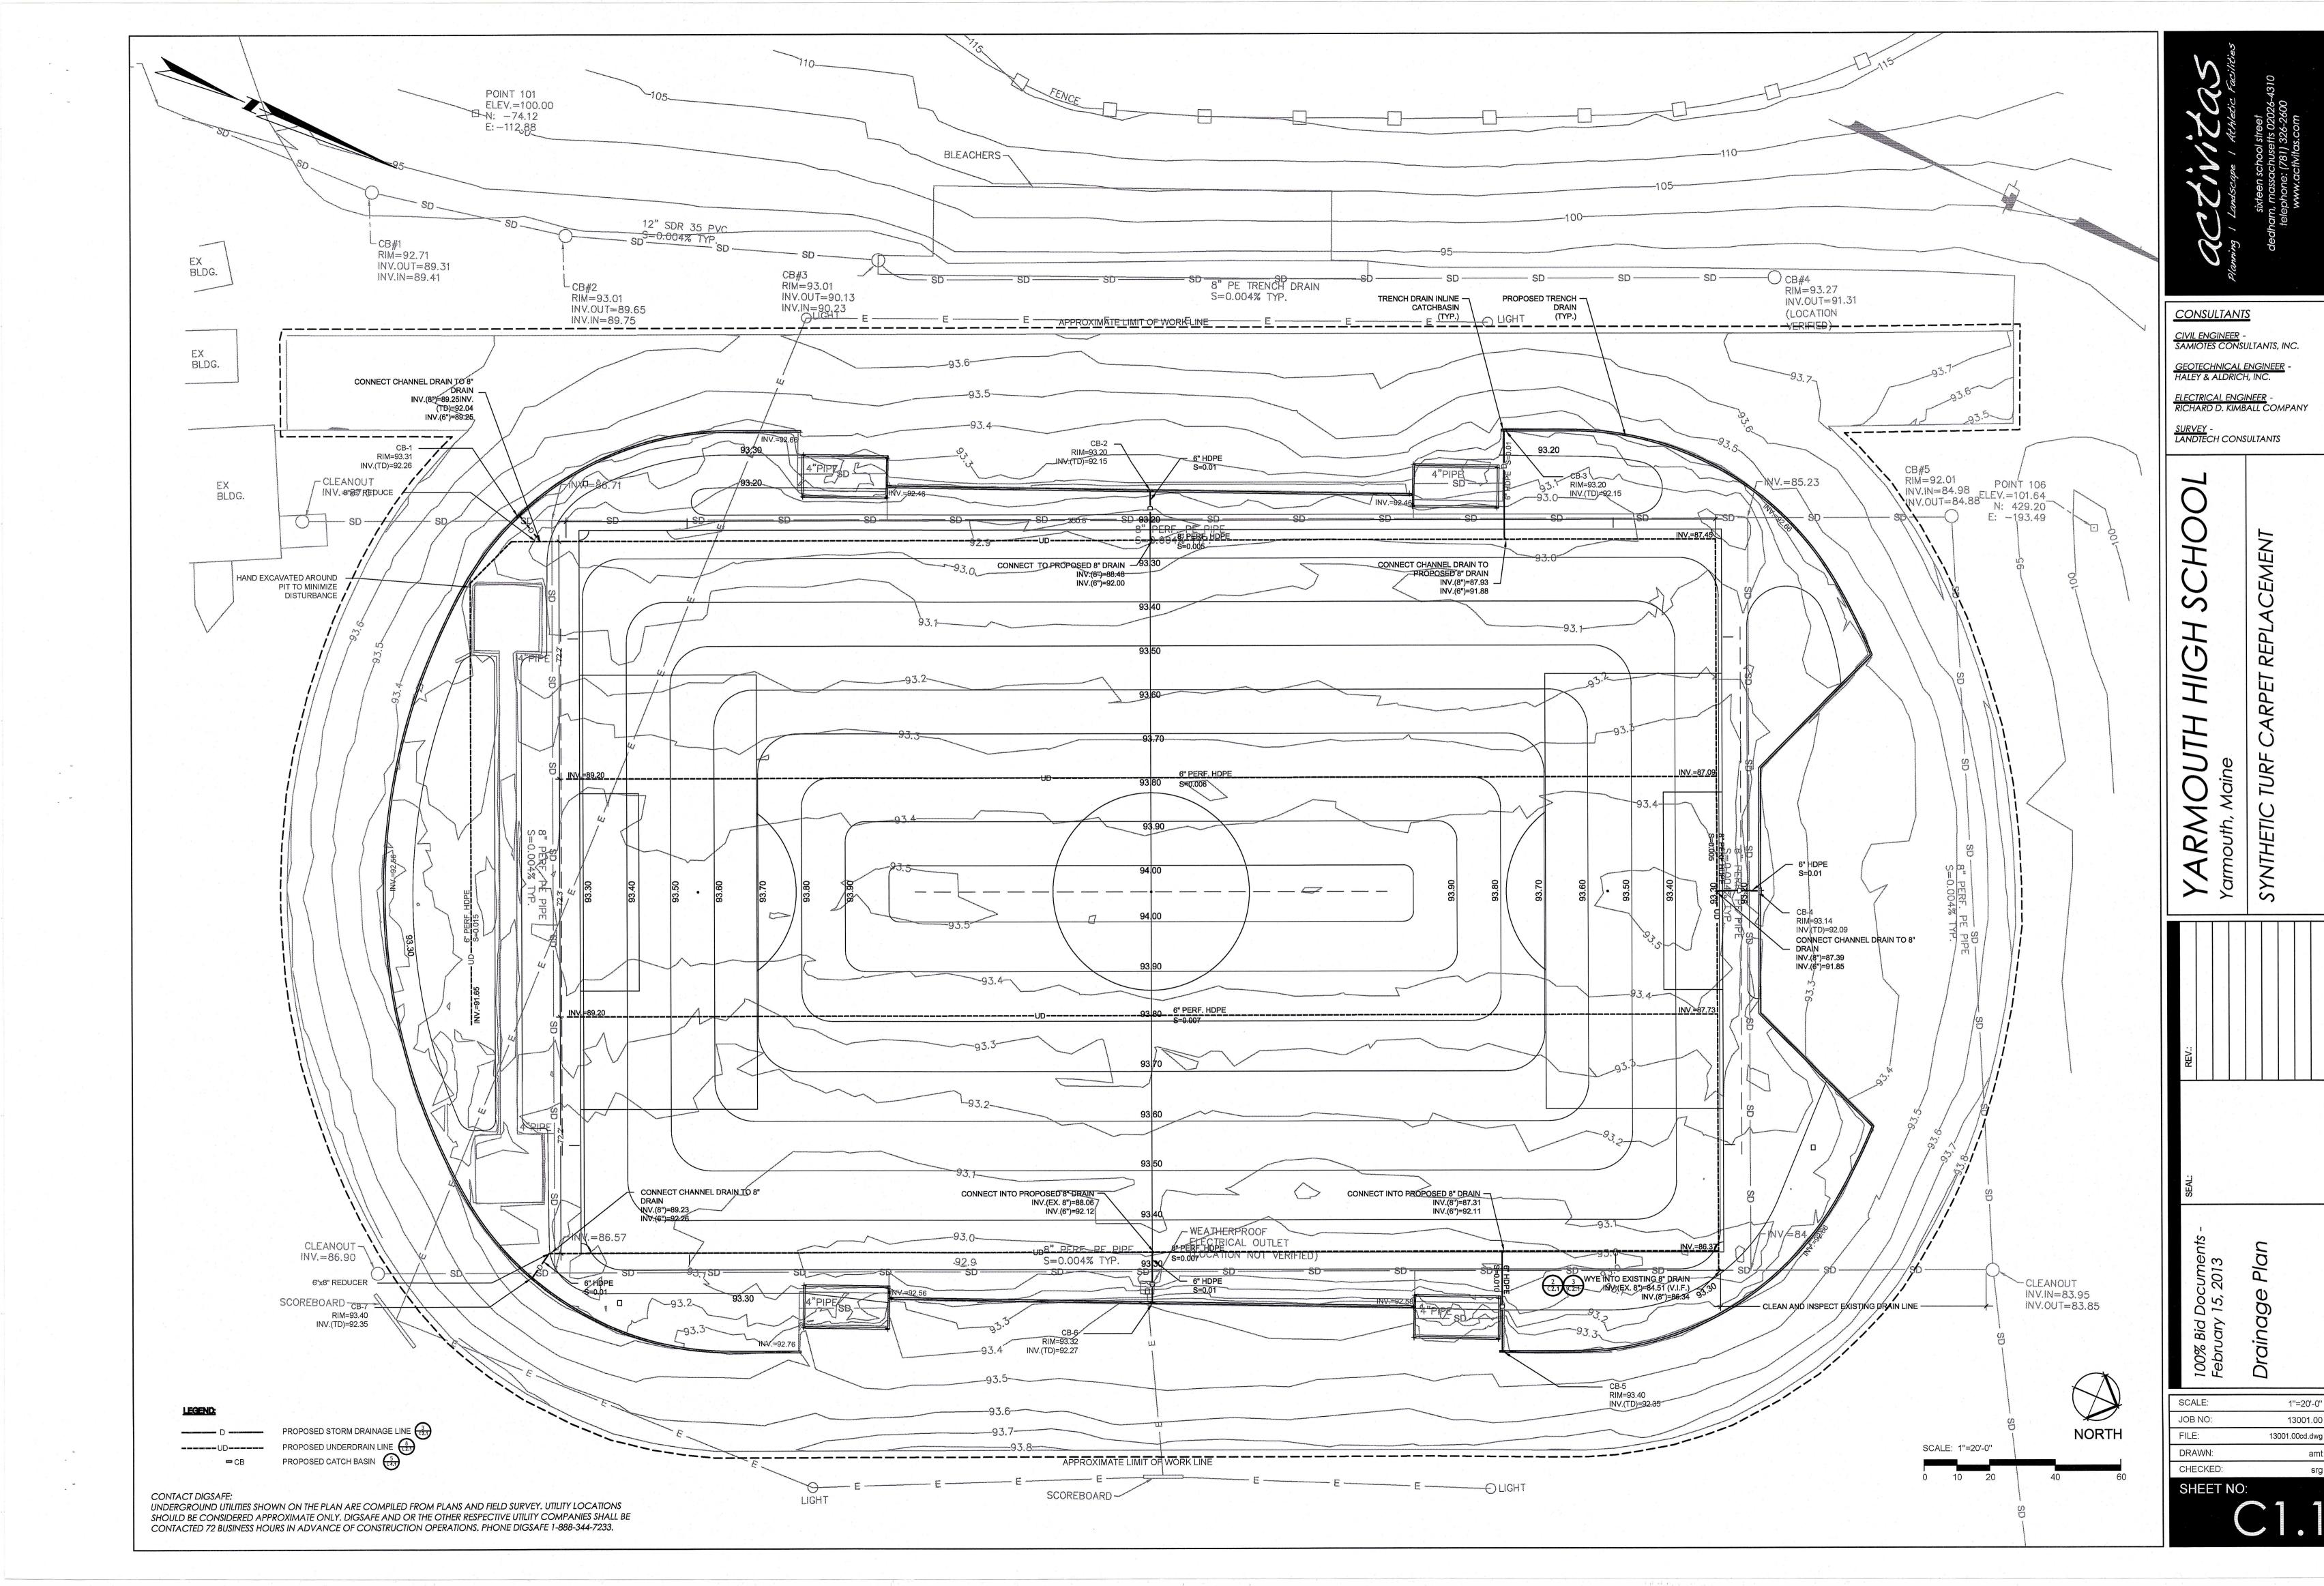

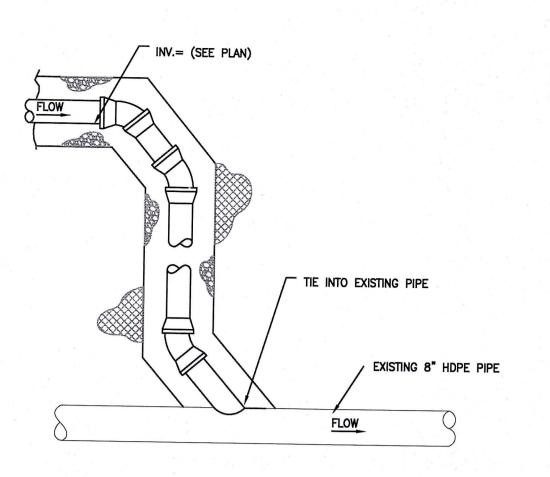

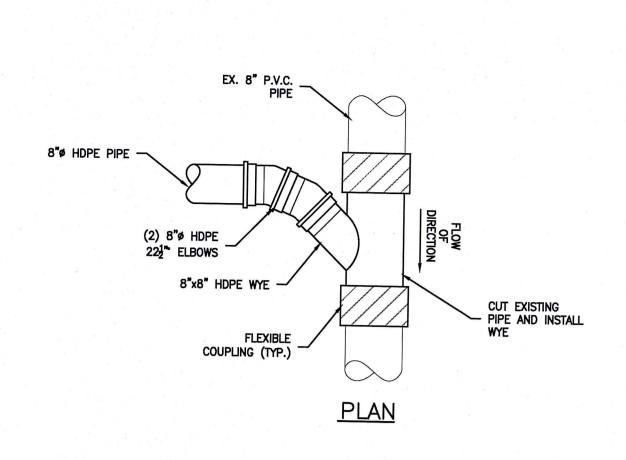

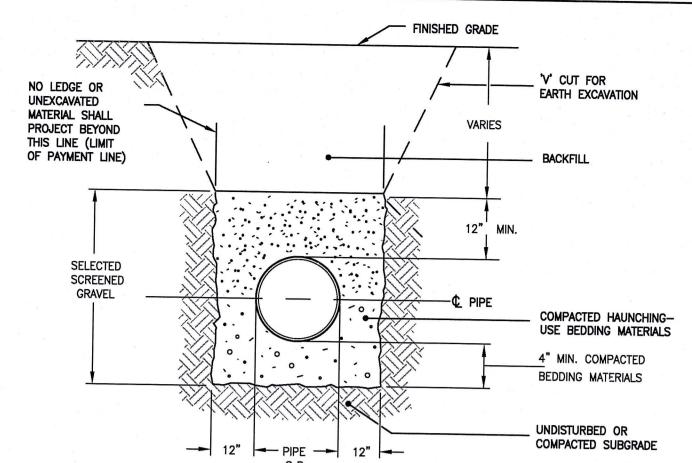

CONNECTION TO EXISTING STORMDRAIN

NTS

2 STORM DRAIN CONNECTION
NTS

TRENCH SECTION- HDPE GRAVITY PIPE

NTS

CCCCINICASS

Planning I Landssape I Athletic Facilities sixteen school street dedham, massachusetts 02026-4310 telephone: (781) 326-2600 www.activitas.com

CONSULTANTS

CIVIL ENGINEER SAMIOTES CONSULTANTS, INC.

GEOTECHNICAL ENGINEER HALEY & ALDRICH, INC.

ELECTRICAL ENGINEER RICHARD D. KIMBALL COMPANY

SURVEY LANDTECH CONSULTANTS

SURVEY - LANDTECH CONSULTANTS

CEMENT

taine TURF CARPET REPLACEMENT

Yarmouth, Maine
SYNTHETIC TURF CARP

REV.:

100% Bid Documents - February 15, 2013

Drainage Details

SCALE: 1"=20'-0"

JOB NO: 13001.00

FILE: 13001.00cd.dwg

E: 13001.00ca AWN: ECKED:

SHEET NO:

