
LONG CREEK YOUTH DEVELOPMENT CENTER CEILING REPLACEMENT

South Portland, Maine

LONG CREEK YOUTH **DEVELOPMENT CENTER CEILING REPLACEMENT**

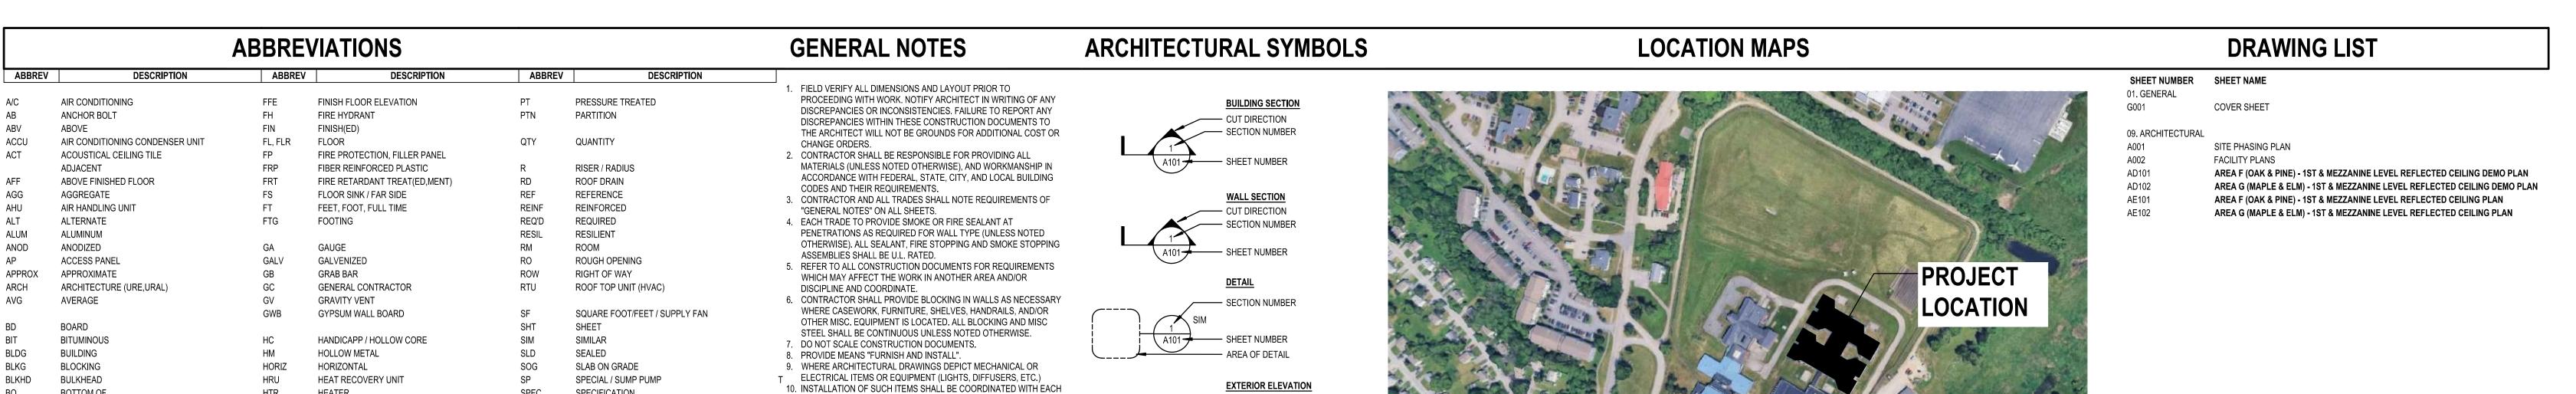

75 Washington Ave., Suite 3A



— ELEVATION DIRECTION

SECTION NUMBER

— ELEVATION NUMBER/ DIRECTION

EQUIPMENT/ACCESSORY TAG

— SHEET NUMBER

SHEET NUMBER

DATUM REFERENCE

KEY NOTE

Room Name — ROOM NAME

ROOM AREA (WHEN APPLICABLE)

REVISION NUMBER

— REVISION TAG

---- AREA OF REVISION

SPECIFICATION

STAINLESS STEEL

STEEL

STORAGE

SYSTEM

STRUCUR(E, AL)

TOP & BOTTOM

TELEPHONE

TOP OF

TEMPERATURE THICK

TOP OF CONCRETE

TOP OF MASONRY

TOP OF PIER

TOP OF STEEL

TELEVISION

UNIT HEATER UNFINISHED

TYPICAL

UTILITY

VERTICAL VESTIBULE

VINYL

VERIFY IN FEILD

VENT THROUGH ROOF

WIDE, WIDTH, WATER

WATERPROOF / WORKING POINT

WATER CLOSET

TOP OF FRAME / FOOTING

UNLESS NOTED OTHERWISE UNINTERUPTABLE POWER SUPPLY

VAPOR BARRIER / VINYL BASE

TOUNGE & GROOVE

SUSPEND(ED)

STOR

SYS

UPS

UTIL

STORM SEWER, STONE, STAIN

11. WHERE THE DRAWINGS DO NOT ADDRESS INSTALLATION

SPECIFICATIONS AND INDUSTRY STANDARDS.

13. ALL MATERIALS SHALL BE ASBESTOS-FREE.

14. PRODUCTS NOTED IN DRAWINGS WITH A SPECIFIC

UNLESS OTHERWISE DETAILED ON THE DRAWINGS.

FOR MANUFACTURER OR SUBSTITUTION OPTIONS.

IDENTIFY THE TYPE OF PRODUCT REQUIRED. REFER TO

SPECIFICATIONS FOR SPECIFIC PRODUCT REQUIREMENTS AND

METHODOLOGY, THE CONTRACTOR SHALL BE BOUND TO PERFORM

WRITTEN APPROVAL OF THE ARCHITECT/STRUCTURAL ENGINEER,

IN STRICT COMPLIANCE WITH CODES, THE MANUFACTURER'S

12. THE CONTRACTOR AND THEIR SUBCONTRACTORS SHALL NOT

MAKE STRUCTURAL CHANGES OR MODIFICATIONS WITHOUT

HEATING, VENTILATION, AIR CONDITIONING

IMPACT RESISTANT / INSULATED METAL PANEL

ISOLATION JOINT

JUNCTION BOX

JANITOR'S CLOSET

INTERIOR

LAVATORY

LIGHT GAUGE METAL FRAMING

LOW POINT / LIGHTING PANEL

MEDIUM DENSITY OVERLAY

MOISTURE-RESISTANT

NOT IN CONTRACT

NOT TO SCALE

ON CENTER

OVERHEAD

OPENING

OPPOSITE

PULL BOX

PLASTER

PLUMBING PLYWOOD

POWER PANEL

PUBLIC ADDRESS

PLATE / PROPERTY LINE

POUNDS PER LINEAR FOOT

POUNDS PER SQUARE FOOT

POUNDS PER SQUARE INCH

OUTSIDE DIAMETER

OWNER FURNISHED CONTRACTOR INSTALLED WP

OWNER FURNISHED OWNER INSTALLED

OUTSIDE FACE

BASIS OF DESIGN

CAST IN PLACE

CENTER LINE

CLEAR(ANCE)

CMU

COND

CONF

CONST CONT

COORD

BOTTOM OF FOOTING

CEMENTITIOUS BACKER BOARD

COLD FORMED METAL FRAMING

CONCRETE MASONRY UNIT

CONTINU(OUS, ATION

DISHWASHER

ELEVATION

ELECTRICAL

EDGE OF PAVEMENT

ELECTRICAL PANEL

EXISTING TO REMAIN

FRESH AIR INTAKE

FOUNDATION

FINISH FLOOR

FLOOR DRAIN, FIRE DAMPER

FIRE DEPT. VALVE CABINET

FIRE EXTINGUISHER CABINET

EQUIPMENT


ETR


EXH


EXHAUST FAN / EACH FACE

CONTROL JOINT / CONSTRUCTION JOINT



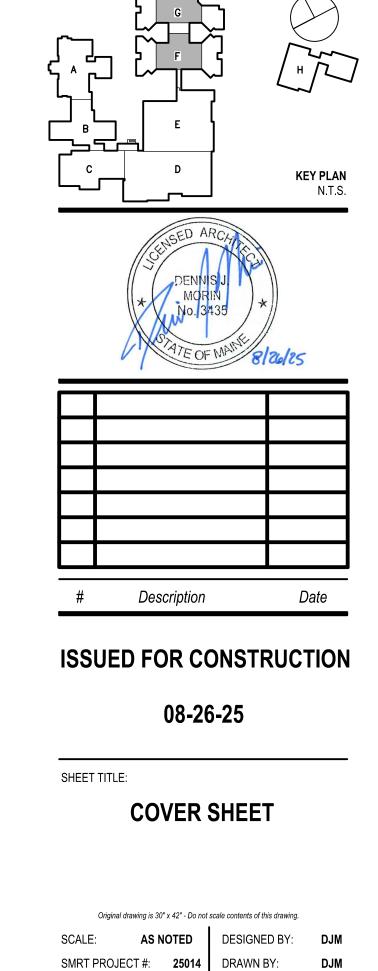

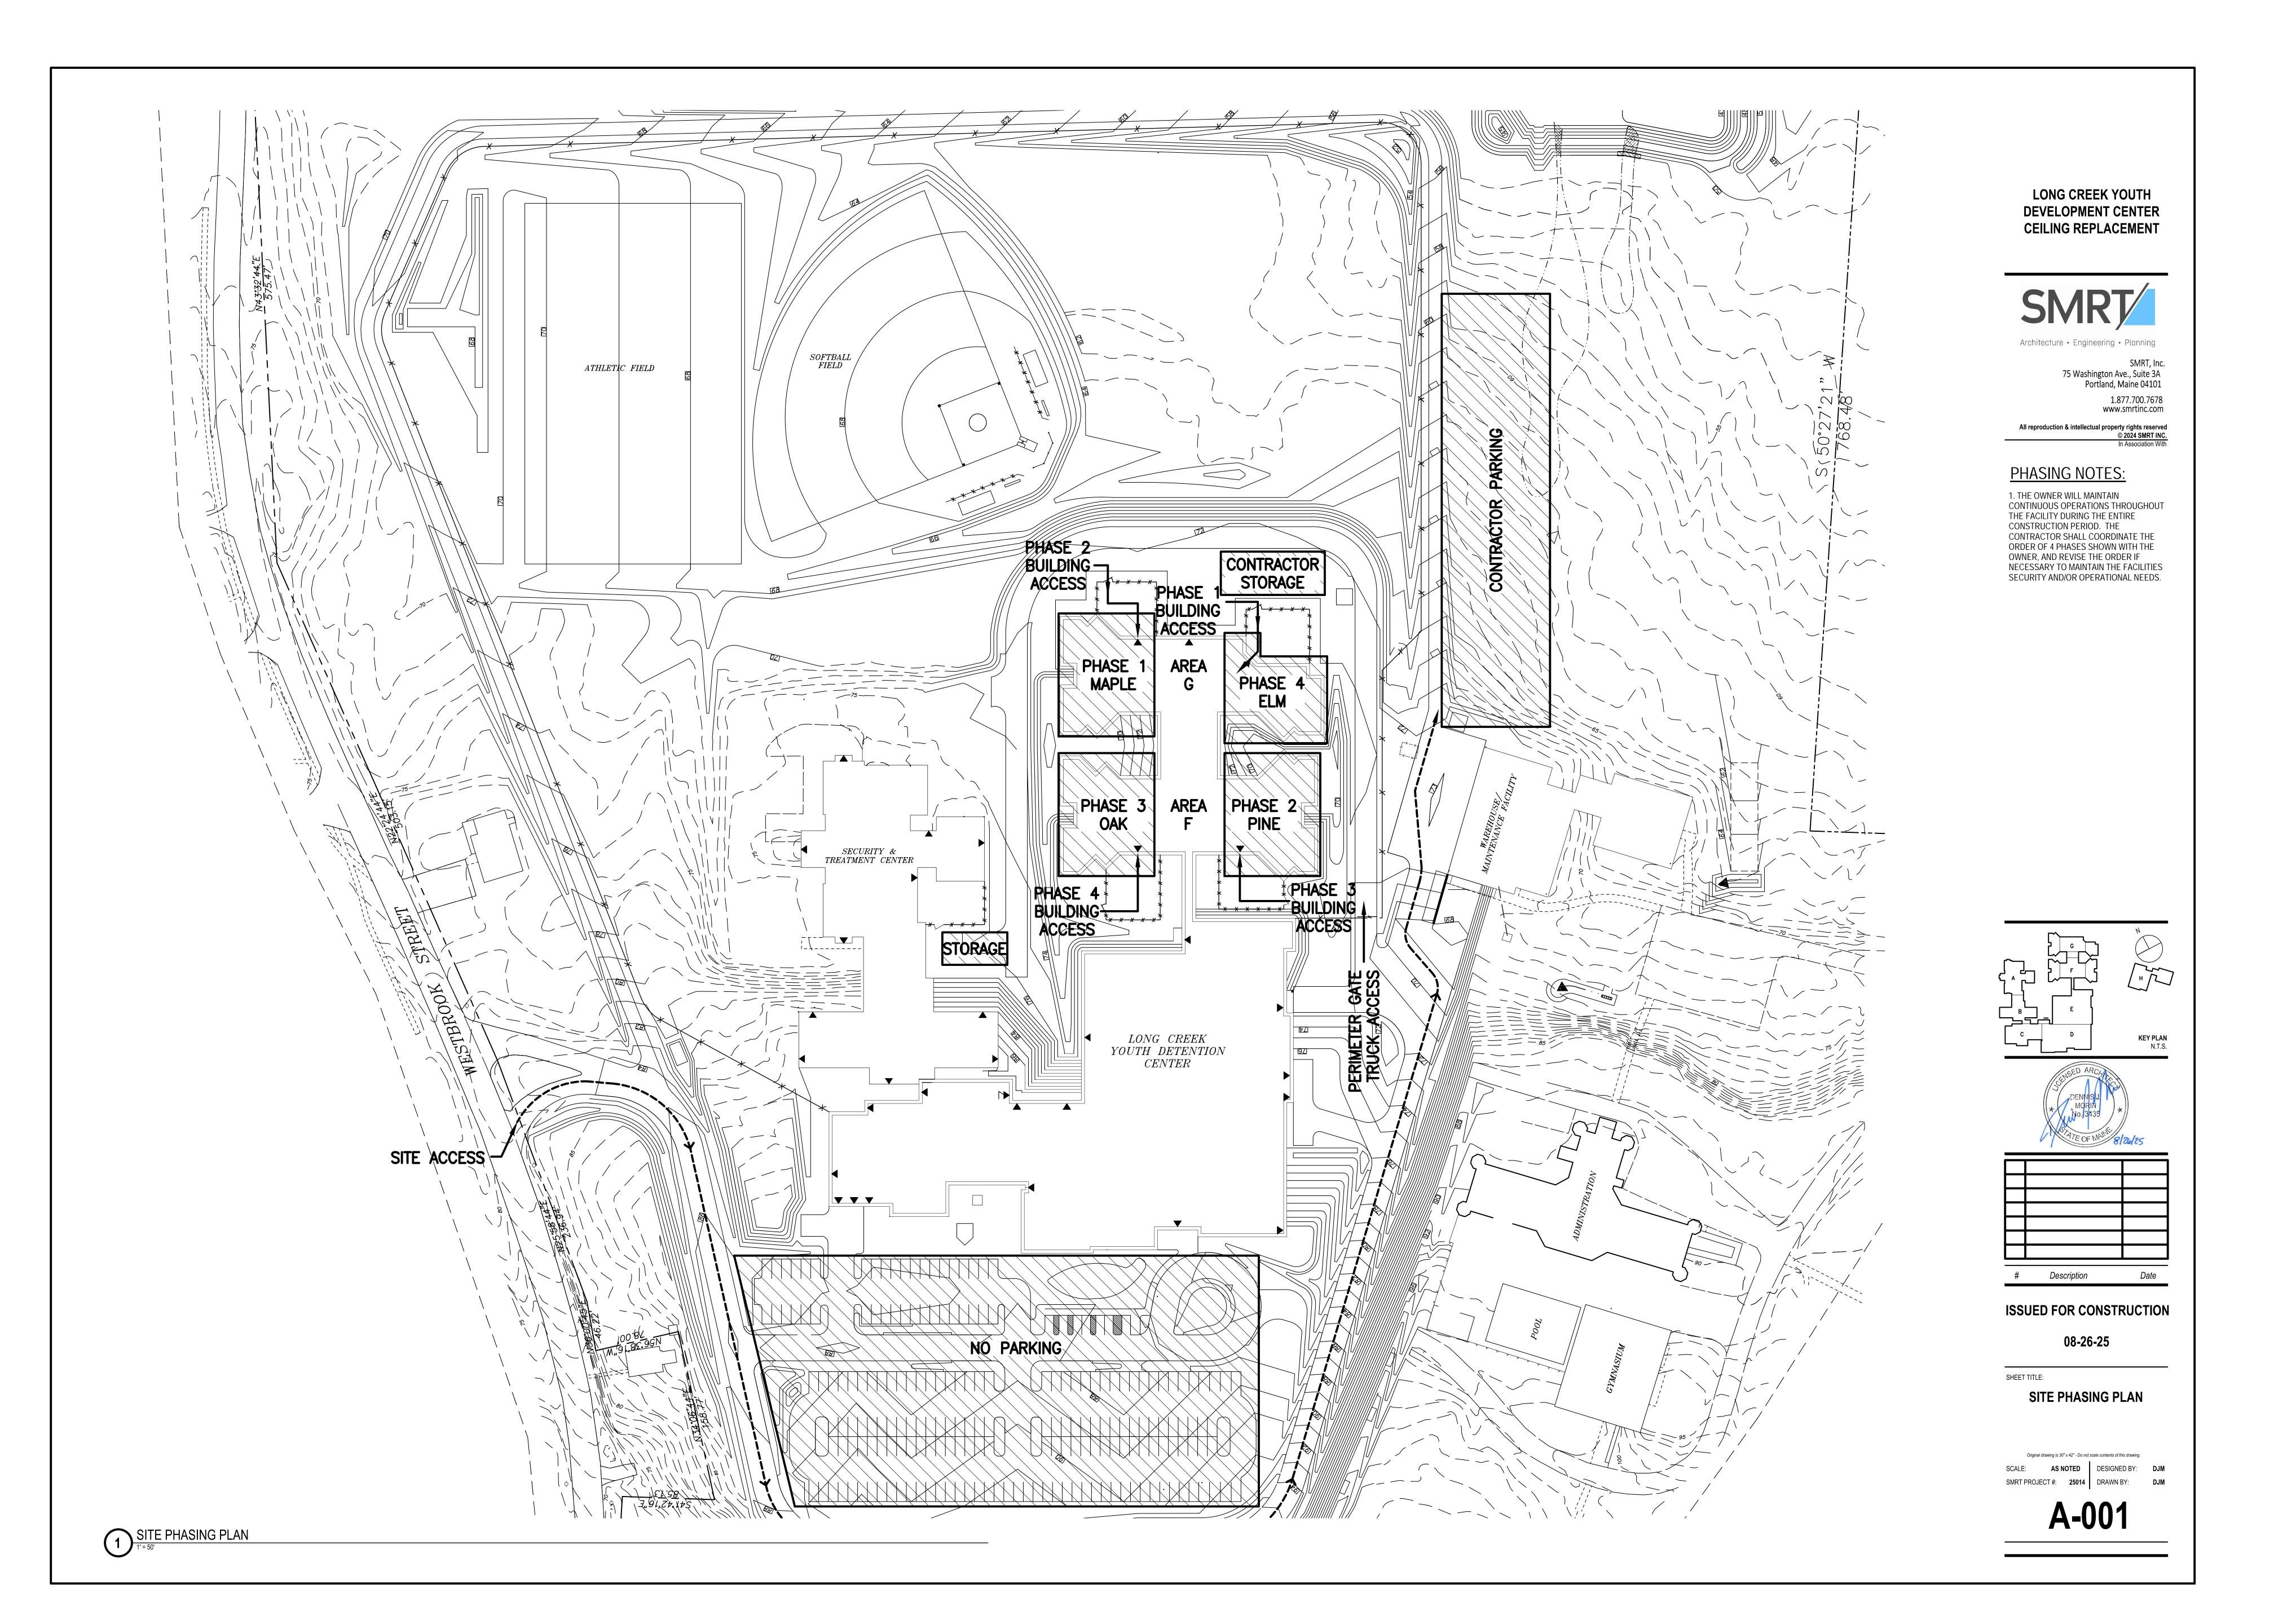

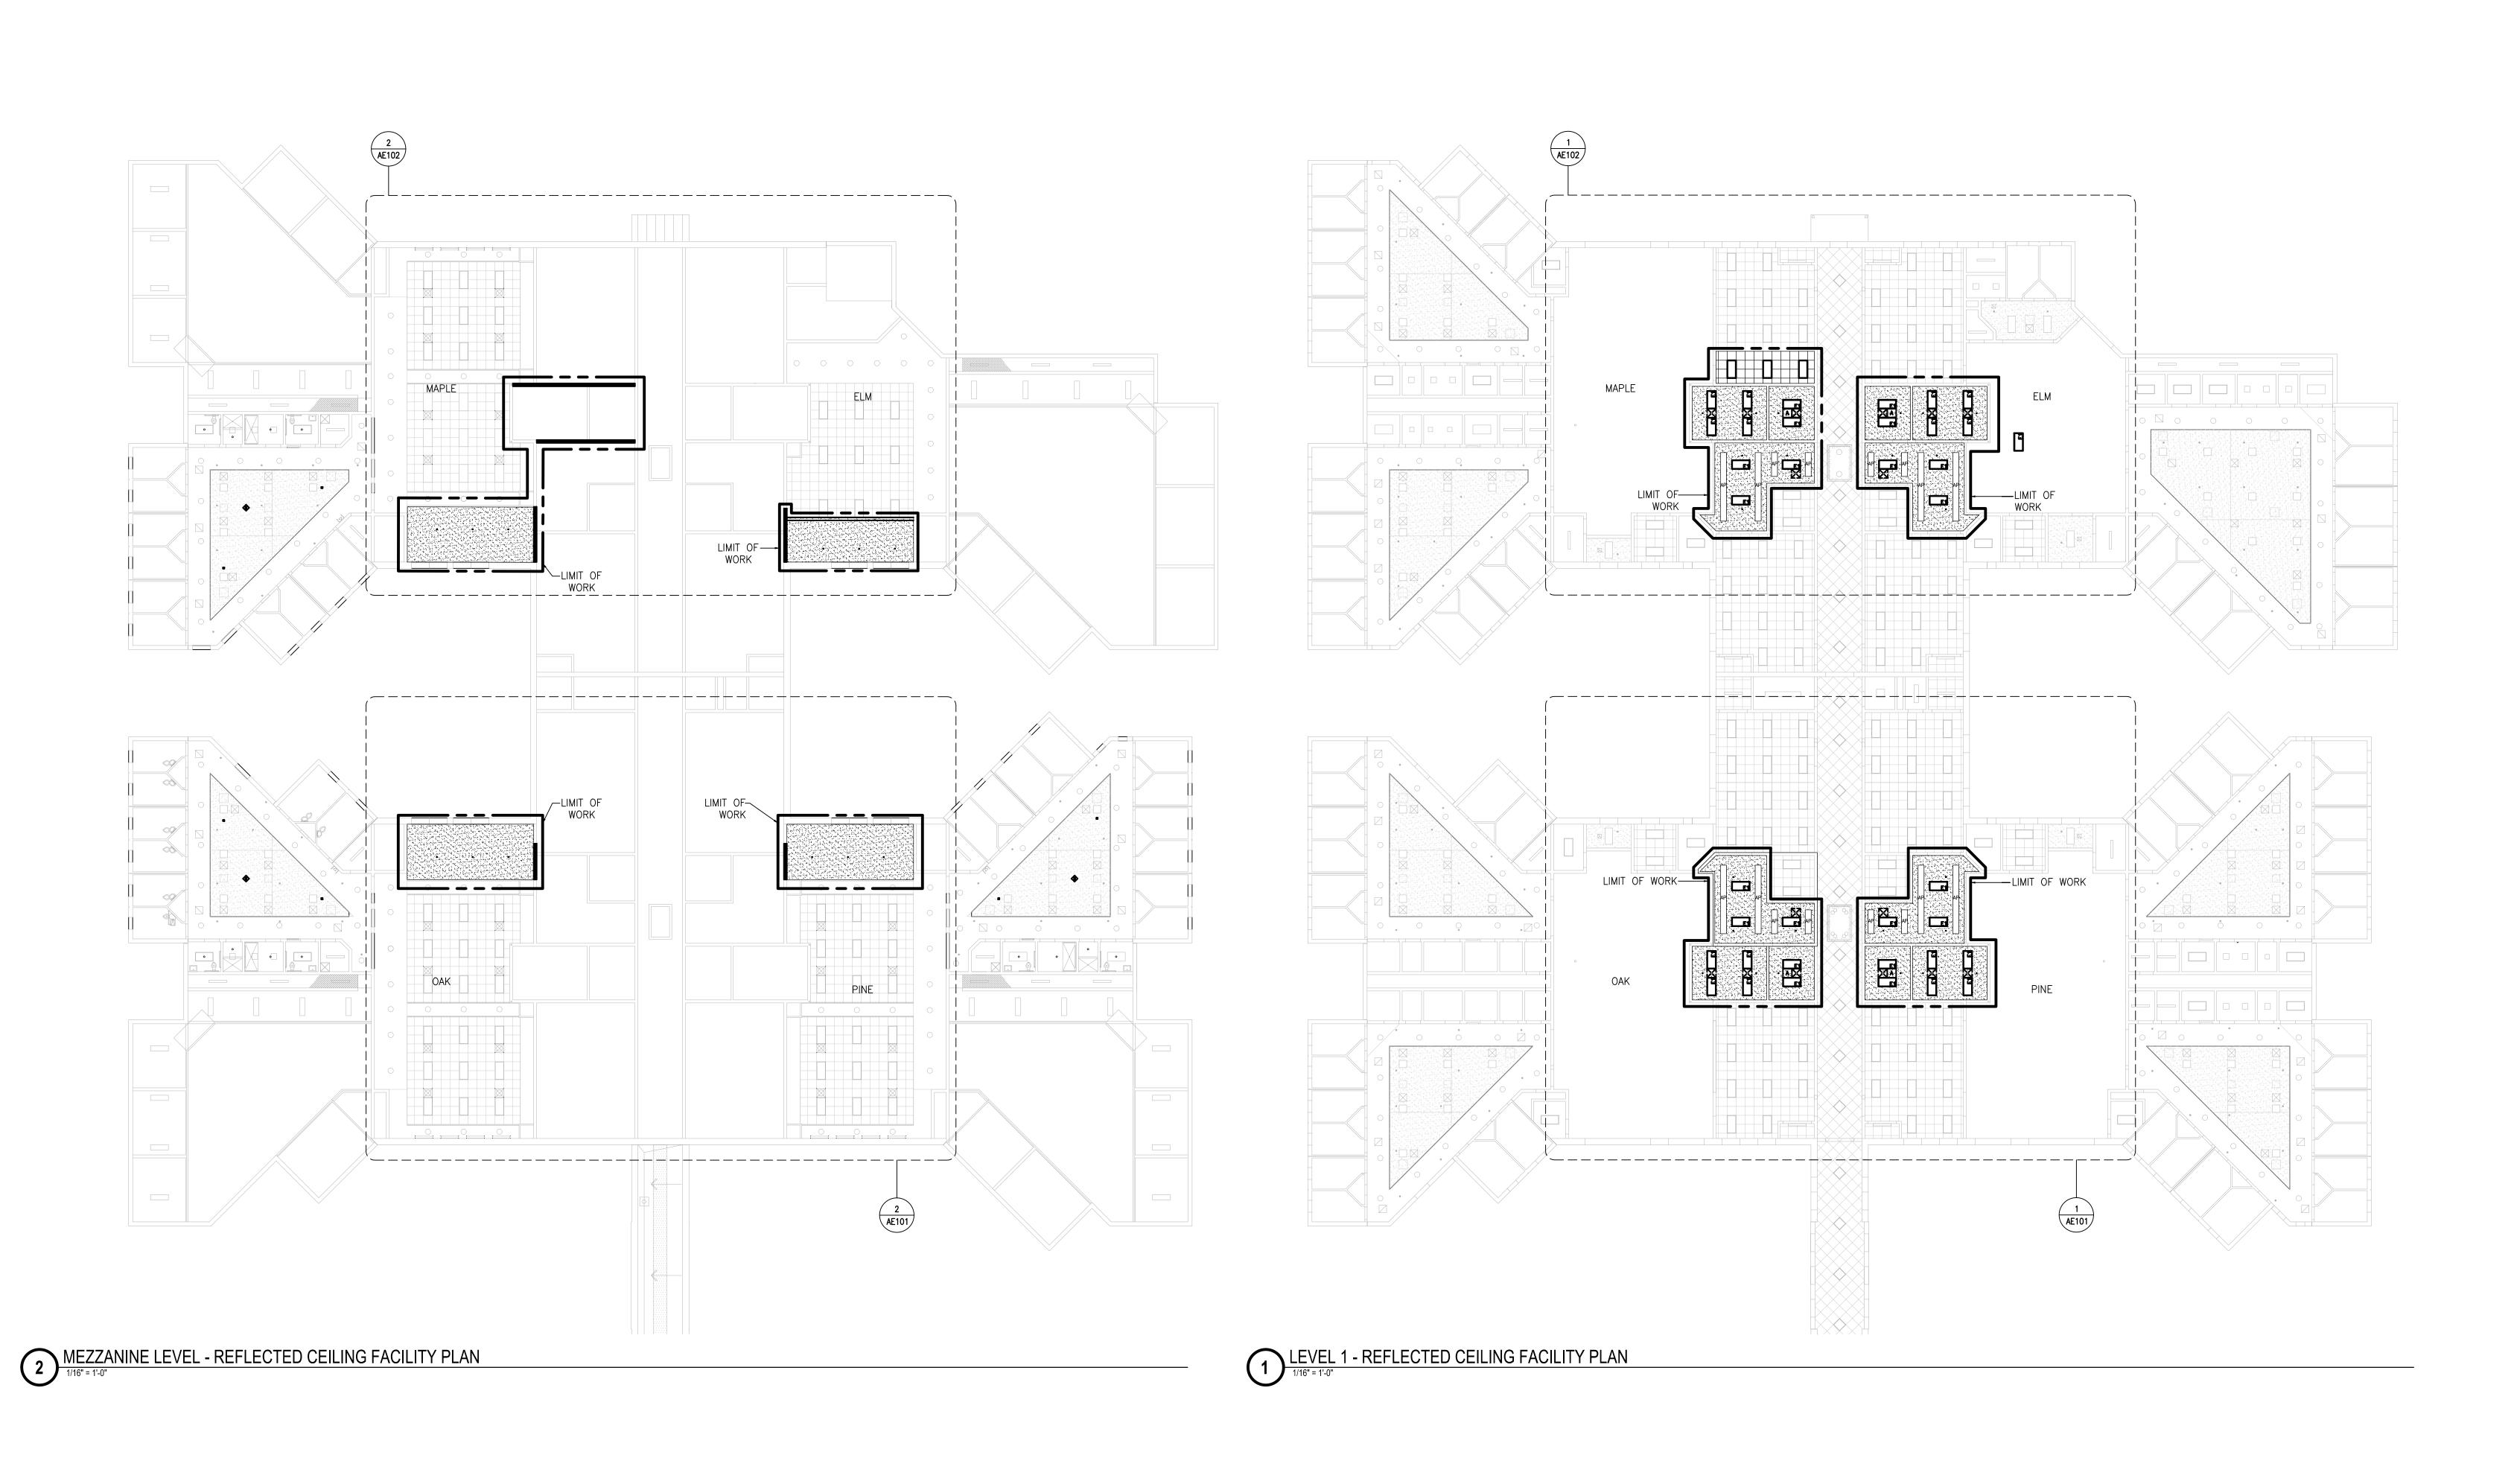


LONG CREEK YOUTH
DEVELOPMENT CENTER
CEILING REPLACEMENT



75 Washington Ave., Suite 3A
Portland, Maine 04101

1.877.700.7678
www.smrtinc.com

All reproduction & intellectual property rights reserved
© 2024 SMRT INC.
In Association With

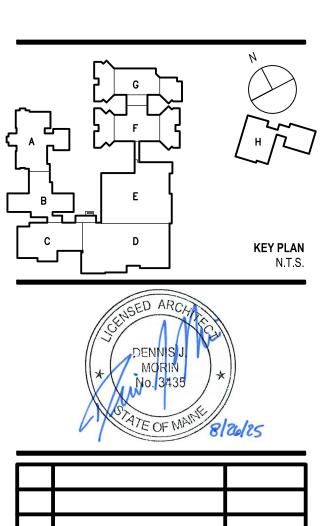

ISSUED FOR CONSTRUCTION

08-26-25

SHEET TITLE:

Description


FACILITY PLANS


Original drawing is 30" x 42" - Do not scale contents of this drawing.

SCALE: AS NOTED DESIGNED BY: DJM

SMRT PROJECT #: 25014 DRAWN BY: DJM


A-002

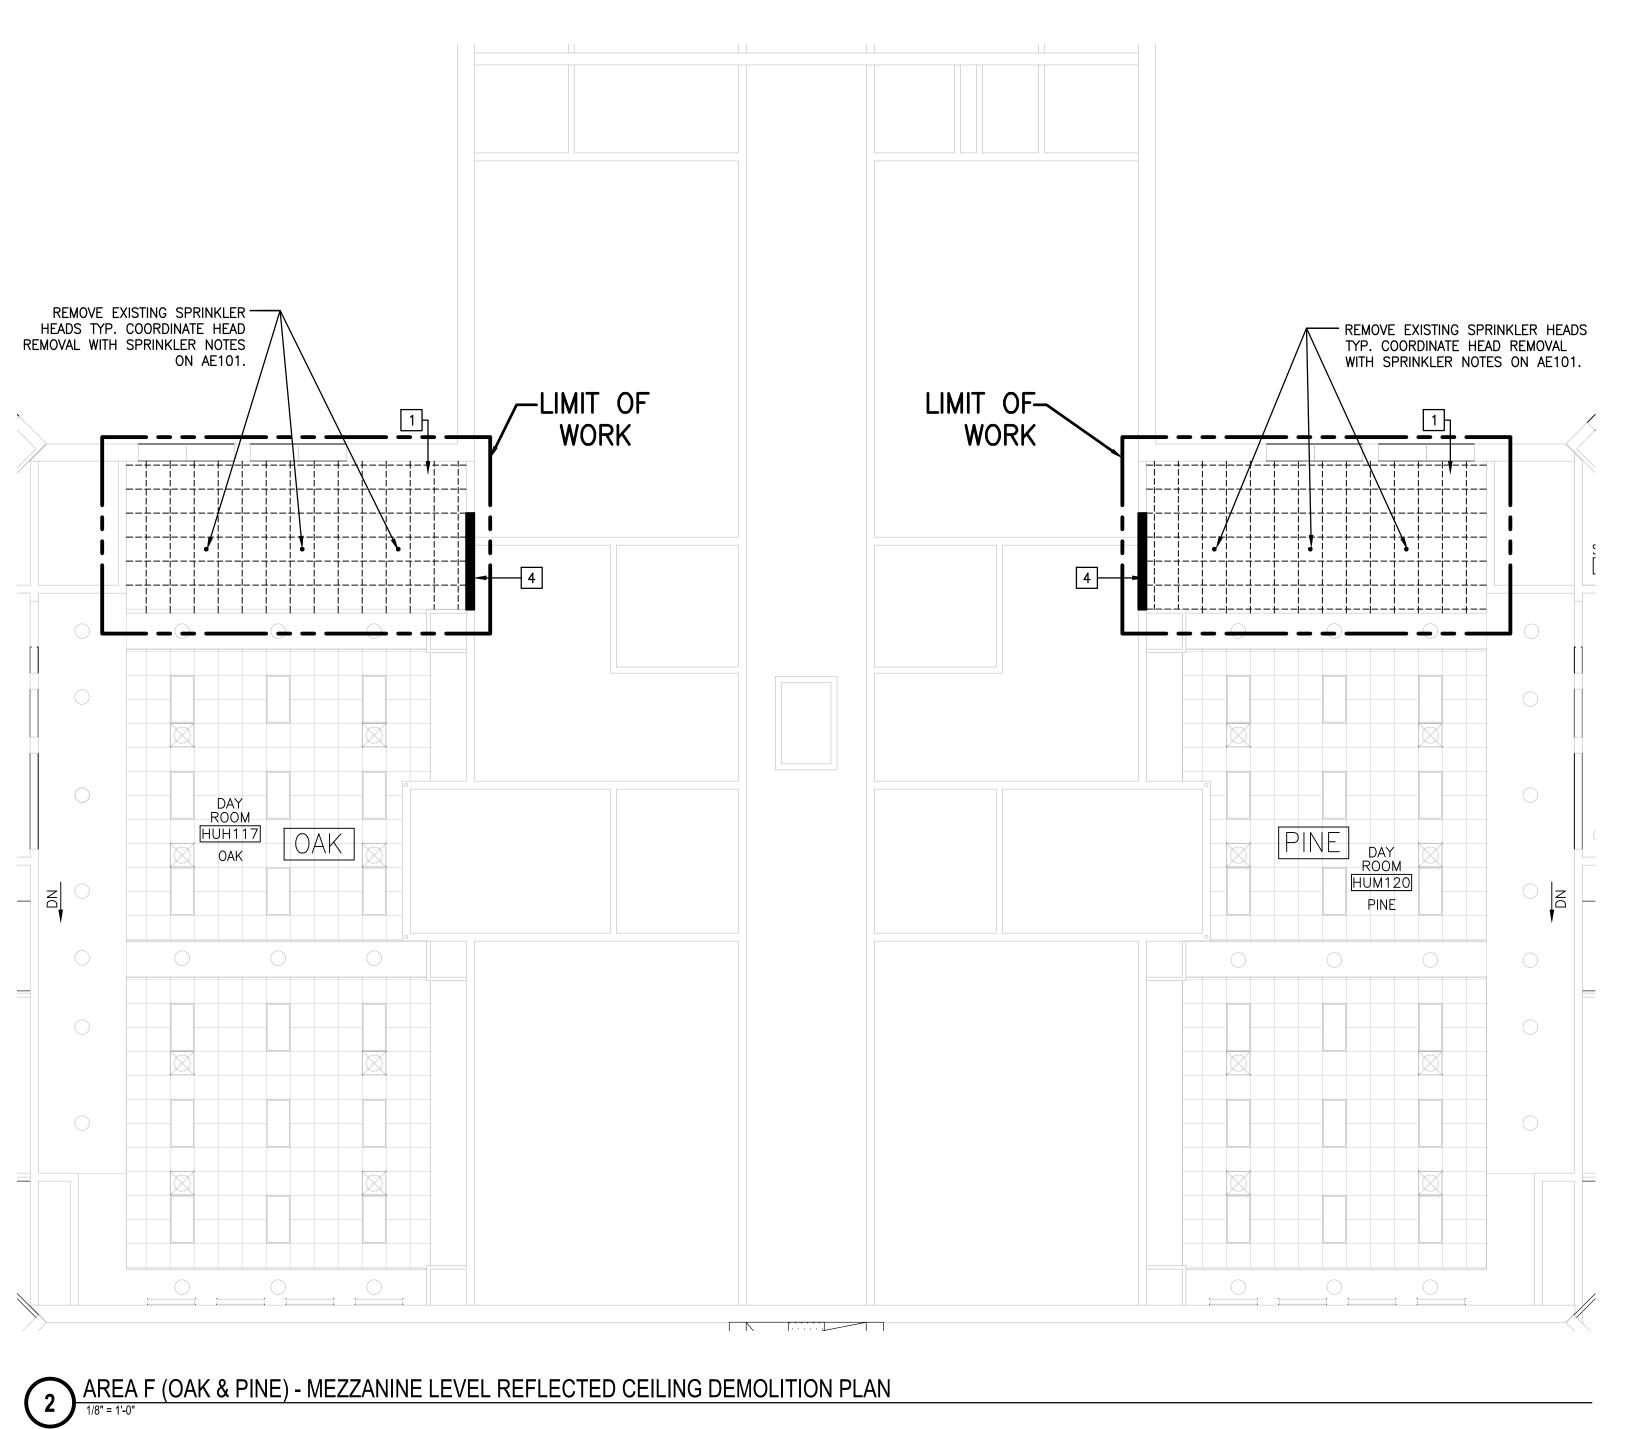

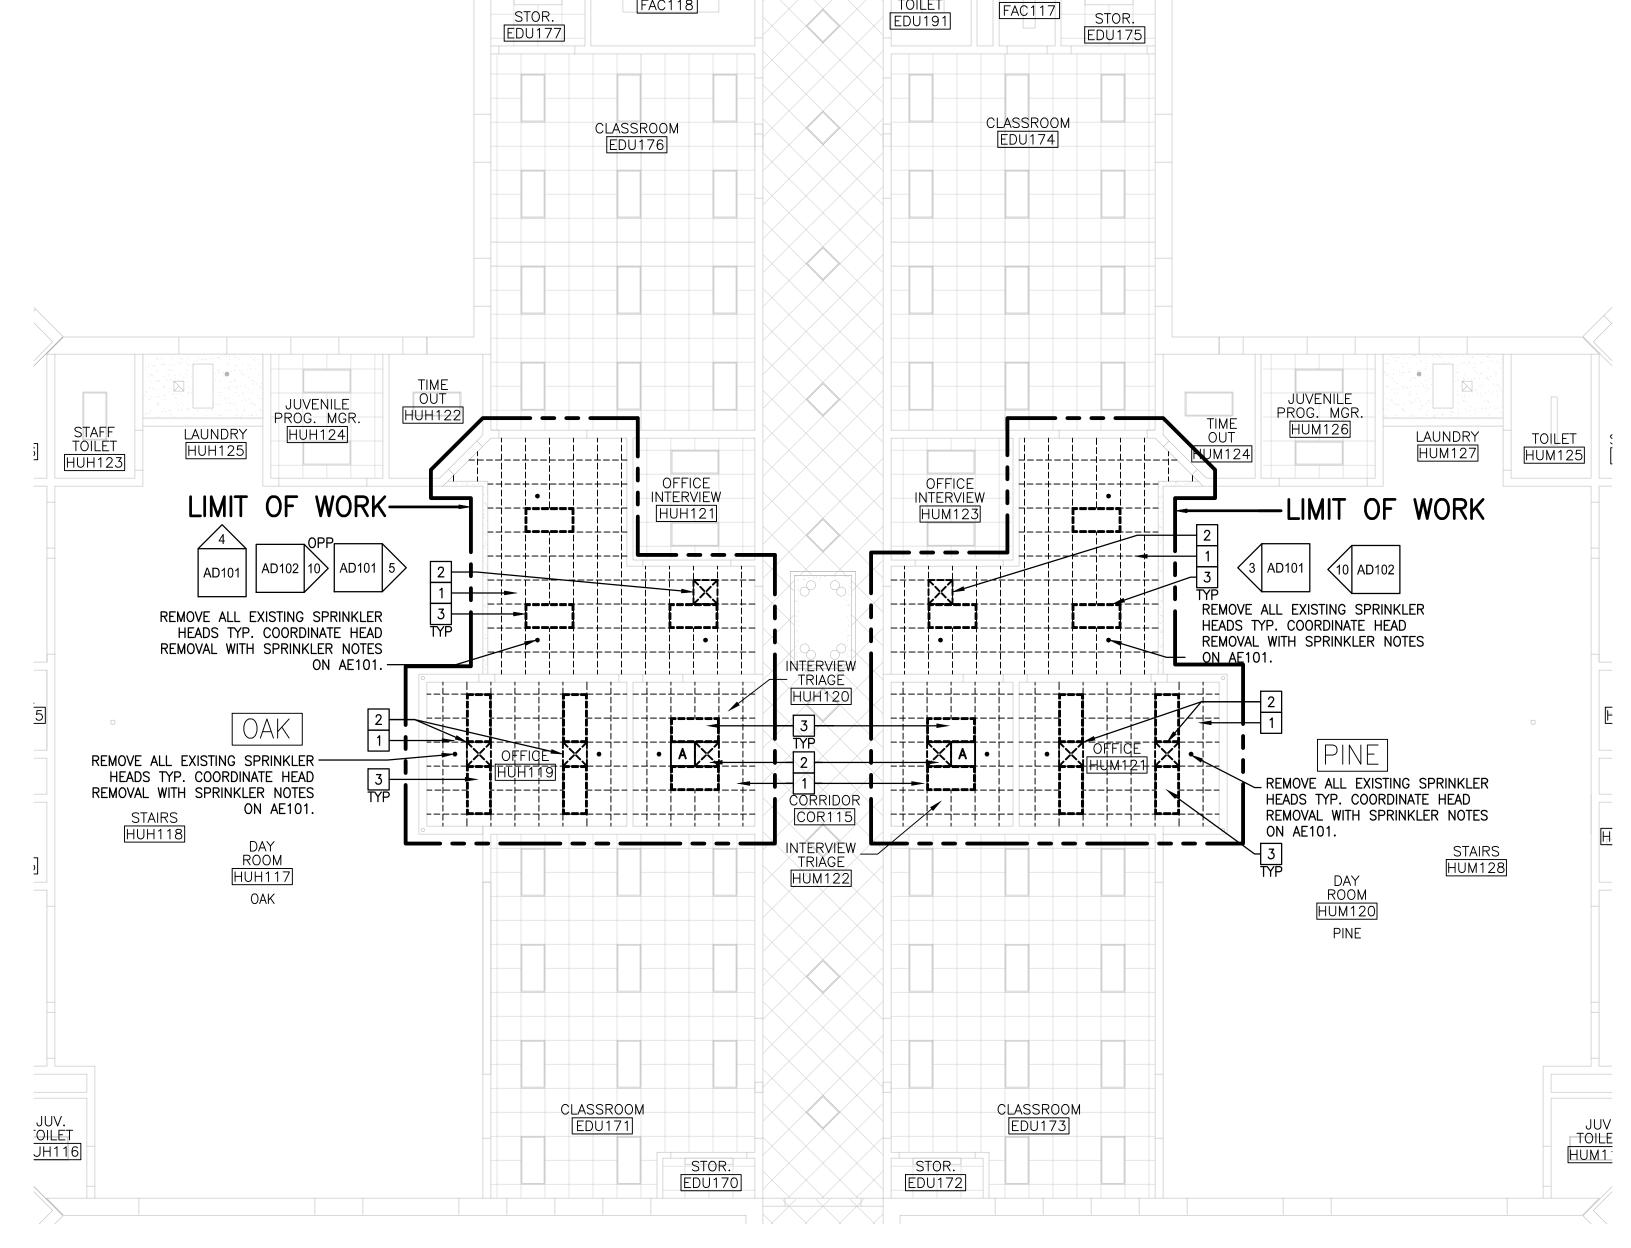

AREA F (OAK & PINE) - REFLECTED CEILING DEMOLITION PLAN

1/8" = 1'-0"

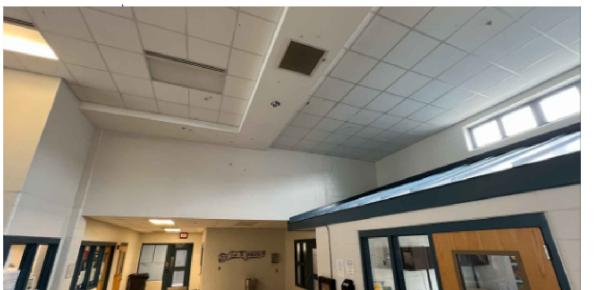

EXISTING CONDITION PHOTO

1/8" = 1'-0"



EXISTING CONDITION PHOTO

1/8" = 1'-0"



EXISTING CONDITION PHOTO


1/8" = 1'-0"

- **DEMOLITION NOTES:** 1. IT IS THE GENERAL CONTRACTORS RESPONSIBILITY TO EXECUTE DEMOLITION
- WORK AS REQUIRED TO ALLOW THE EXECUTION OF NEW WORK. 2. COORDINATE EXTENT OF DEMOLITION WITH LOCATIONS OF PARTITIONS DESCRIBED
- ON PLANS AND WITH LOCATIONS OF EXISTING FINISHES TO REMAIN. 3. ANY WALL, PARTITION OR SURFACE DISTURBED BECAUSE OF NEW WORK OR DEMOLITION SHALL BE PATCHED AND FINISHED TO THE NEAREST CORNER
- UNLESS NOTED OTHERWISE. MATCH EXISTING ADJACENT CONSTRUCTION,
- FINISHES, CONTINUITY AND FIRE RATINGS UNLESS NOTED OTHERWISE. 4. PROTECT ALL FINISHES, MATERIALS AND EQUIPMENT NOTED AS EXISTING TO
- REMAIN. CONTRACTOR SHALL BE RESPONSIBLE TO REPLACE ALL FINISHES, MATERIALS AND EQUIPMENT DAMAGED DURING CONSTRUCTION. 5. DIMENSIONS INDICATED =/- ARE EXISTING CONDITION DIMENSIONS TO BE FIELD

DEMOLITION KEY NOTES:

- 1 REMOVE EXISTING ACOUSTIC CEILING TILE AND GRID ASSEMBLY TO THE EXTENT DESCRIBED. COORDINATE EXTENTS OF REMOVAL WITH PARTITION LOCATIONS AND EXISTING FINISHES TO REMAIN.
- 2 REMOVE EXISTING CEILING DIFFUSER AND ASSOCIATED FLEX DUCT. PREPARE DUCTWORK FOR CONNECTION OF NEW FLEX DUCT AND INSTALLATION OF NEW DIFFUSER. COORDINATE ANY EQUIPMENT WHICH IS TO BE SALVAGED FOR REUSE OR RETURNED TO THE OWNER.
- REMOVE EXISTING LIGHT FIXTURE. COORDINATE ANY EQUIPMENT WHICH IS TO BE RETURNED TO THE OWNER. LIGHTING CIRCUITS AND FIXTURE "WHIPS" TO REMAIN FOR
- 4 REMOVE EXISTING GWB TO THE EXTENT SHOWN ON CORRESPONDING ELEVATIONS.
- 5 NOT USED 6 2'x2' SUSPENDED ACT ASSEMBLY. REMOVE THE EXISTING CEILING ASSEMBLY TO THE EXTENT NECESSARY TO PERFORM ABOVE CEILING GYPSUM BOARD SCOPE OF WORK. REMOVE LIGHT FIXTURES AND SALVAGE FOR REINSTALLATION. INSTALL NEW SUSPSENDED ACT CEILING ASSEMBLY & REINSTALL EXISTING LIGHT FIXTURES

FOLLOWING ABOVE CEILING GYPSUM BOARD SCOPE OF WORK.

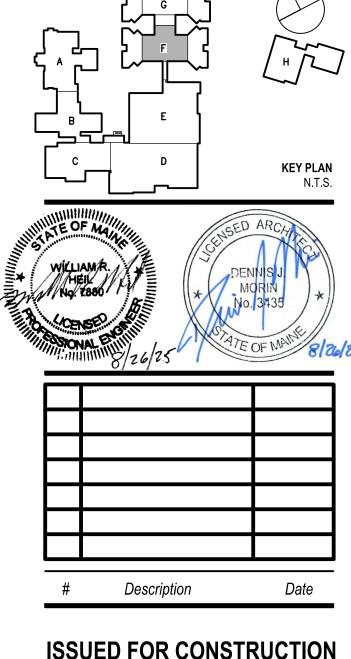

LONG CREEK YOUTH

DEVELOPMENT CENTER

CEILING REPLACEMENT

Architecture • Engineering • Planning

All reproduction & intellectual property rights reserved
© 2024 SMRT INC.
In Association With

75 Washington Ave., Suite 3A Portland, Maine 04101


> 1.877.700.7678 www.smrtinc.com


ISSUED FOR CONSTRUCTION

08-26-25

AREA F (OAK & PINE) 1ST & **MEZZANINE LEVEL** REFLECTED CEILING DEMO PLAN

> Original drawing is 30" x 42" - Do not scale contents of this drawing. SCALE: AS NOTED DESIGNED BY: DJM SMRT PROJECT #: 25014 DRAWN BY: DJM

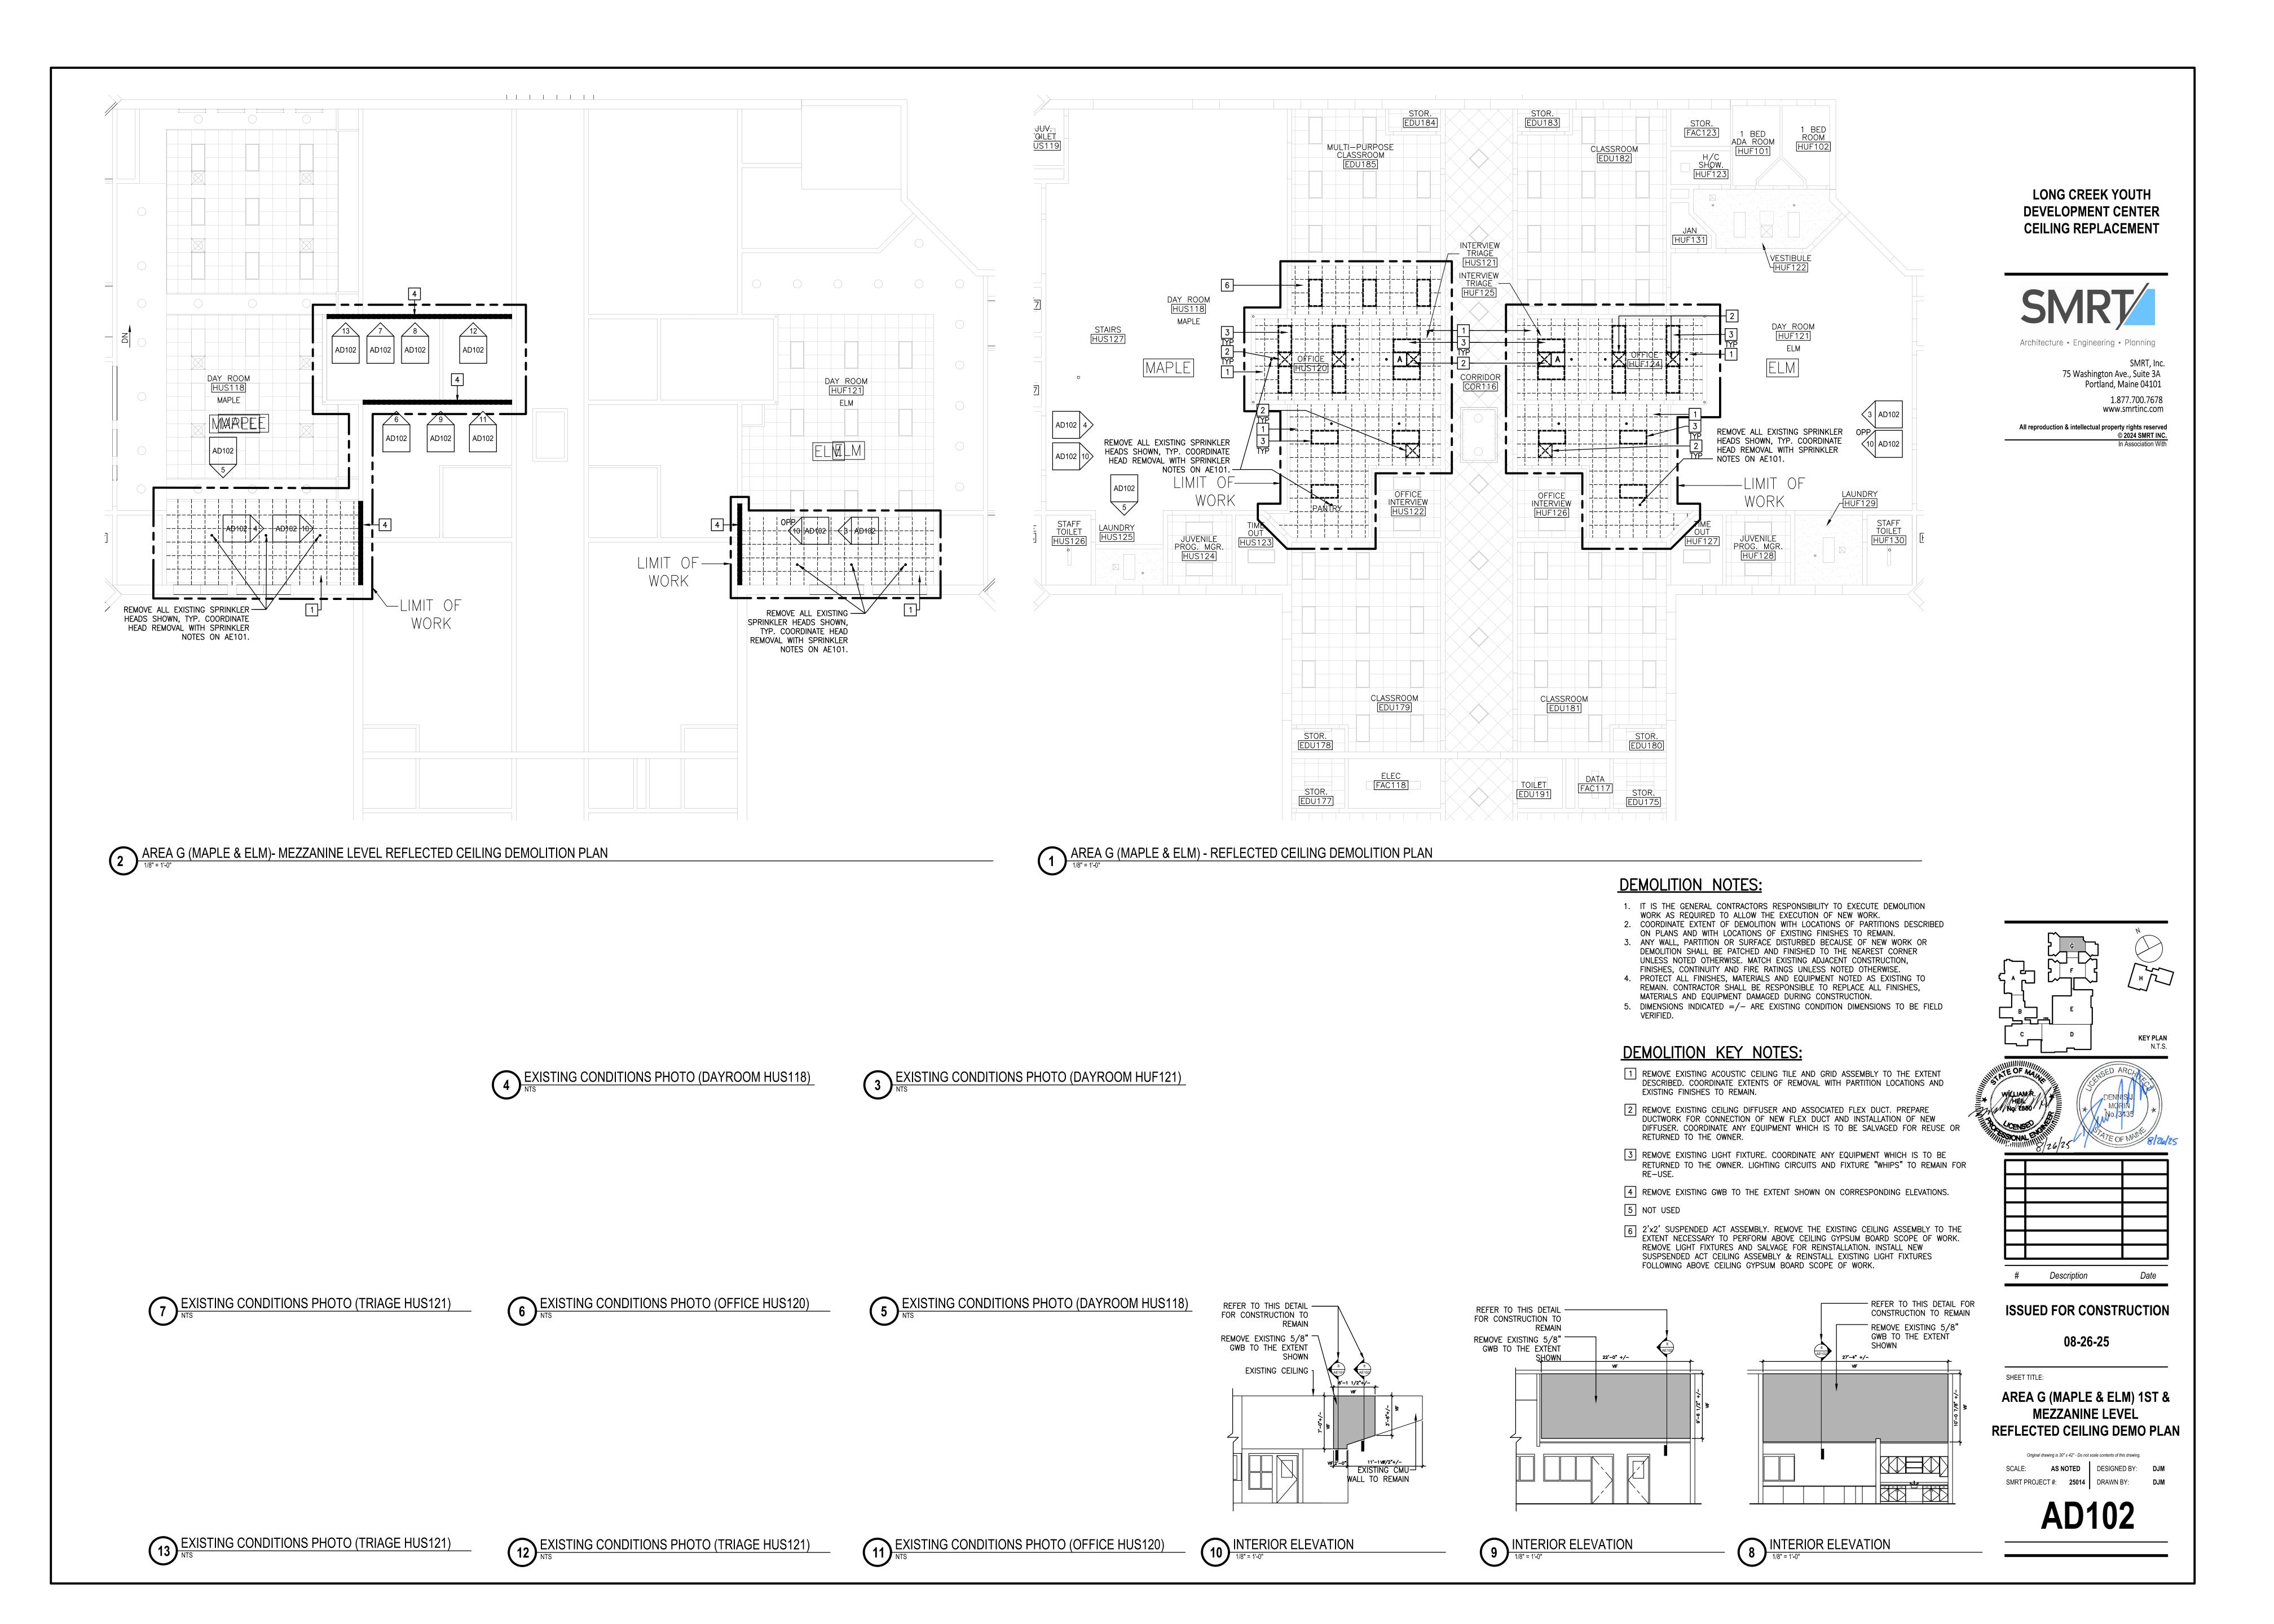

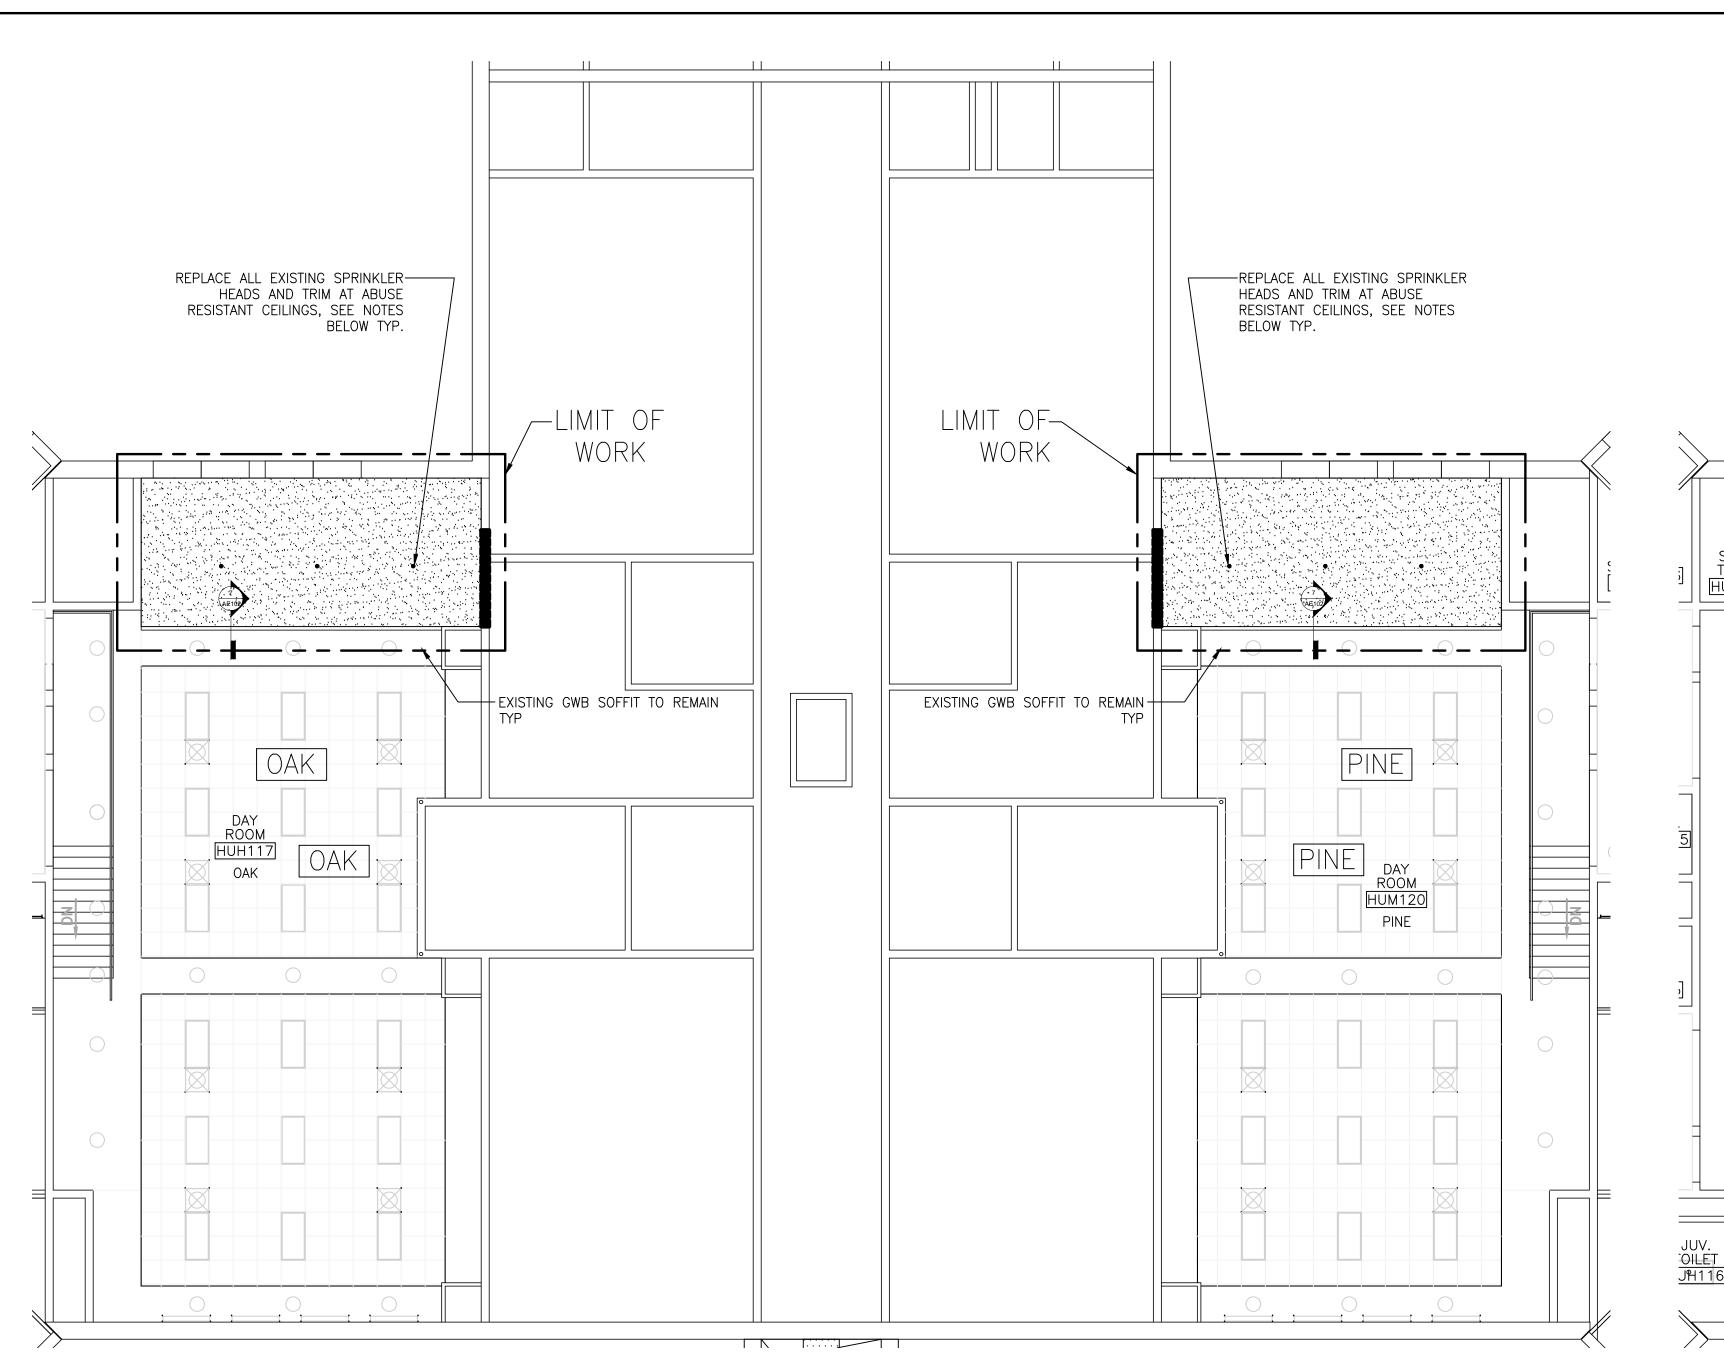



FINISH SCHEDULE: ROOM NUMBER SEE PLAN. ROOM NAME SEE PAN.

EXISTING TO REMAIN. REPAIR ALL DAMAGE DUE TO CONSTRUCTION TO MATCH EXISTING. EXISTING TO REMAIN, REPAIR ALL DAMAGE DUE TO CONSTRUCTION TO MATCH EXISTING. EXISTING TO REMAIN, REPAIR ALL DAMAGE DUE TO CONSTRUCTION TO MATCH EXISTING. CEILING IMPACT AND ABUSE RESISTANT DRYWALL, PAINTED. EXIST. CEILING PATCH/REPAIR EXISTING SURFACE, PAINTED.

LEGEND

2x2 SUSPENDED CEILING PANEL AND GRID ASSEMBLY.

2x4 SUSPENDED CEILING PANEL AND GRID ASSEMBLY.

ACCESS PANEL

ACOUSTIC PANELS

EXPANDED METAL & ABUSE RESISTANT GWB SUPPORTED BY NON-STRUCTURAL METAL FRAMING

2x2 LIGHT FIXTURE. 2x4 LIGHT FIXTURE.

1x4 LIGHT FIXTURE.

CEILING MOUNTED EXIT LIGHT.

RETURN AIR GRILLE

SUPPLY AIR GRILLE

EXHAUST AIR GRILLE.

SPRINKLER HEAD.

CEILING MOUNTED SPEAKER.

ACCESS PANEL, SEE NOTE 6.

ARCHITECTURAL NOTES:

1. SEE GENERAL NOTES GOO1. 2. APPLICABLE CODE: MAINE UNIFORM BUILDING AND ENERGY CODE (MUBEC) WHICH INCLUDES 2021 IBC, 2021 IEBC, & 2021 IECC.

3. CEILING AND DEVICE REPLACEMENT WORK IS LIMITED TO AREAS NOTED 4. PAINT NEW CEILINGS AND SOFFITS SHERWIN WILLIAMS EXTRA WHITE

(SW7006). 5. ÀLIGN CÉILING ITEMS AS SHOWN, WITH COMMON CENTERLINES, TYPICALLY. CENTER ITEMS IN CEILINGS, OR IN AREAS UNLESS INDICATED OTHERWISE.

6. AP: PROVIDE 24"x24" DETENTION GRADE ACCESS PANELS AT ALL VALVES, EQUIPMENT, EQUIPMENT RESET SWITCHES, DUCT SMOKE DETECTORS AND ELECTRICAL JUNCTION BOXES. COORDINATE WITH ALL TRADES. SEE PLANS FOR MINIMUM AMOUNT OF PANELS REQUIRED. 7. CJ: DRYWALL CONTROL JOINT.

8. FIRE SPRINKLERS ARE EXISTING TO REMAIN UNLESS NOTED OTHERWISE. 7. FIRE SPRINKLERS ARE SHOWN FOR COORDINATION PURPOSES ONLY, FIELD VERIFY ACTUAL LOCATIONS AND AMOUNT AS REQUIRED.

9. DIMENSIONS ARE FROM FACE OF GWB TO CENTERLINE OF DEVICES

UNLESS NOTED OTHERWISE.

SPRINKLER NOTES:

- 1. ROTATE SPRINKLER HEADS UPWARD AND PROVIDE UPRIGHT HEADS DURING CONSTRUCTION OF NEW CEILING. ALL WORK SHALL BE COMPLETED IN
- ACCORDANCE WITH NFPA 13 AND THE AUTHORITY HAVING JURISDICTION. INSTALL NEW DETENTION GRADE SPRINKLER HEADS TO PROVIDE COMPLETE SPACE COVERAGE IN ACCORDANCE WITH NFPA 13 REQUIREMENTS AND THE AUTHORITY HAVING JURISDICTION. PRODUCT TO BE TYCO RAVEN 5.6K INSTITUTIONAL SPRINKLERS OR APPROVED EQUAL.
- 3. ALL SPRINKLER SHUT DOWNS SHALL HAPPEN DURING NORMAL WORK HOURS UNLESS PREVIOUSLY AUTHORIZED BY THE OWNER. NO SHUT-DOWN SHALL OCCUR OVER-NIGHT.

LIGHTING FIXTURES:

EFFICIENCY MAINE ELIGIBLE:

E1: MEDIUM SECURITY 2x4 LIGHT. BASIS OF DESIGN: FAIL SAFE MODEL (COOPER LIGHTING) FMR-D-24-4-LD4-3-STD-40-UNV-81/86-EDC-1-SWBR-SF3-PF24-4FT.

ELECTRICAL NOTES:


1. CONNECT NEW FIXTURES TO EXISTING FIXTURE WHIPS AND LIGHTING CIRCUITS.

MECHANICAL NOTES:

- 1. CONTRACTOR SHALL MEASURE AND DOCUMENT EXISTING AIRFLOWS PRIOR TO DEMOLITION AND CONSTRUCTION.
- 2. R1: MINIMUM SECURITY GRILLE, BASIS OF DESIGN: PRICE MODEL MSL GRILLE W/ LATTICE FACEPLATE AND SURFACE MOUNT BOARDER, SURFACE MOUNT BORDER. BORDER SHALL BE FASTENED WITH TAMPERPROOF SCREWS.
- 3. GRILLES SHALL BE SIZED AS FOLLOWS: 22x10 NECK, 801-1570 CFM.
- 4. INSTALLATION OF GRILLES SHALL INCLUDE CONNECTING THE EXISTING RIGID DUCTWORK TO THE PROPOSED GRILLE, AND ANY ASSOCIATED DUCTWORK
- MODIFICATIONS NECESSARY FOR INSTALLATION. 5. S1: MINIMUM SECURITY DIFFUSER, BASIS OF DESIGN: PRICE MODEL MSD LOUVERED FACE 4-WAY DIRECTIONAL DIFFUSER WITH LATTICE FACEPLATE AND TYPE 1 SURFACE MOUNT BORDER. BORDER SHALL BE FASTENED WITH
- TAMPERPROOF SCREWS. 6. DIFFUSERS SHALL BE SIZED AS FOLLOWS: 6x6 NECK, 0 - 150 CFM; 9x9 NECK, 151-300 CFM; 12x12 NECK, 301-500 CFM. 7. INSTALLATION OF DIFFUSERS SHALL INCLUDE FLEXIBLE DUCT CONNECTING THE EXISTING RIGID DUCTWORK TO THE PROPOSED DIFFUSER. FLEXIBLE DUCT SHALL BE UL 181, CLASS 1, 2-PLY VINYL FILM SUPPORTED BY HELICALLY


WOUND, SPRING-STEEL WIRE WITH R-8 FIBEROUS GLASS INSULATION AND

POLYETHYLENE VAPOR BARRIER FILM. 8. PROVIDE SQUARE TO ROUND DUCT CONNECTORS BETWEEN THE DIFFUSER NECK AND THE FLEXIBLE DUCTWORK.

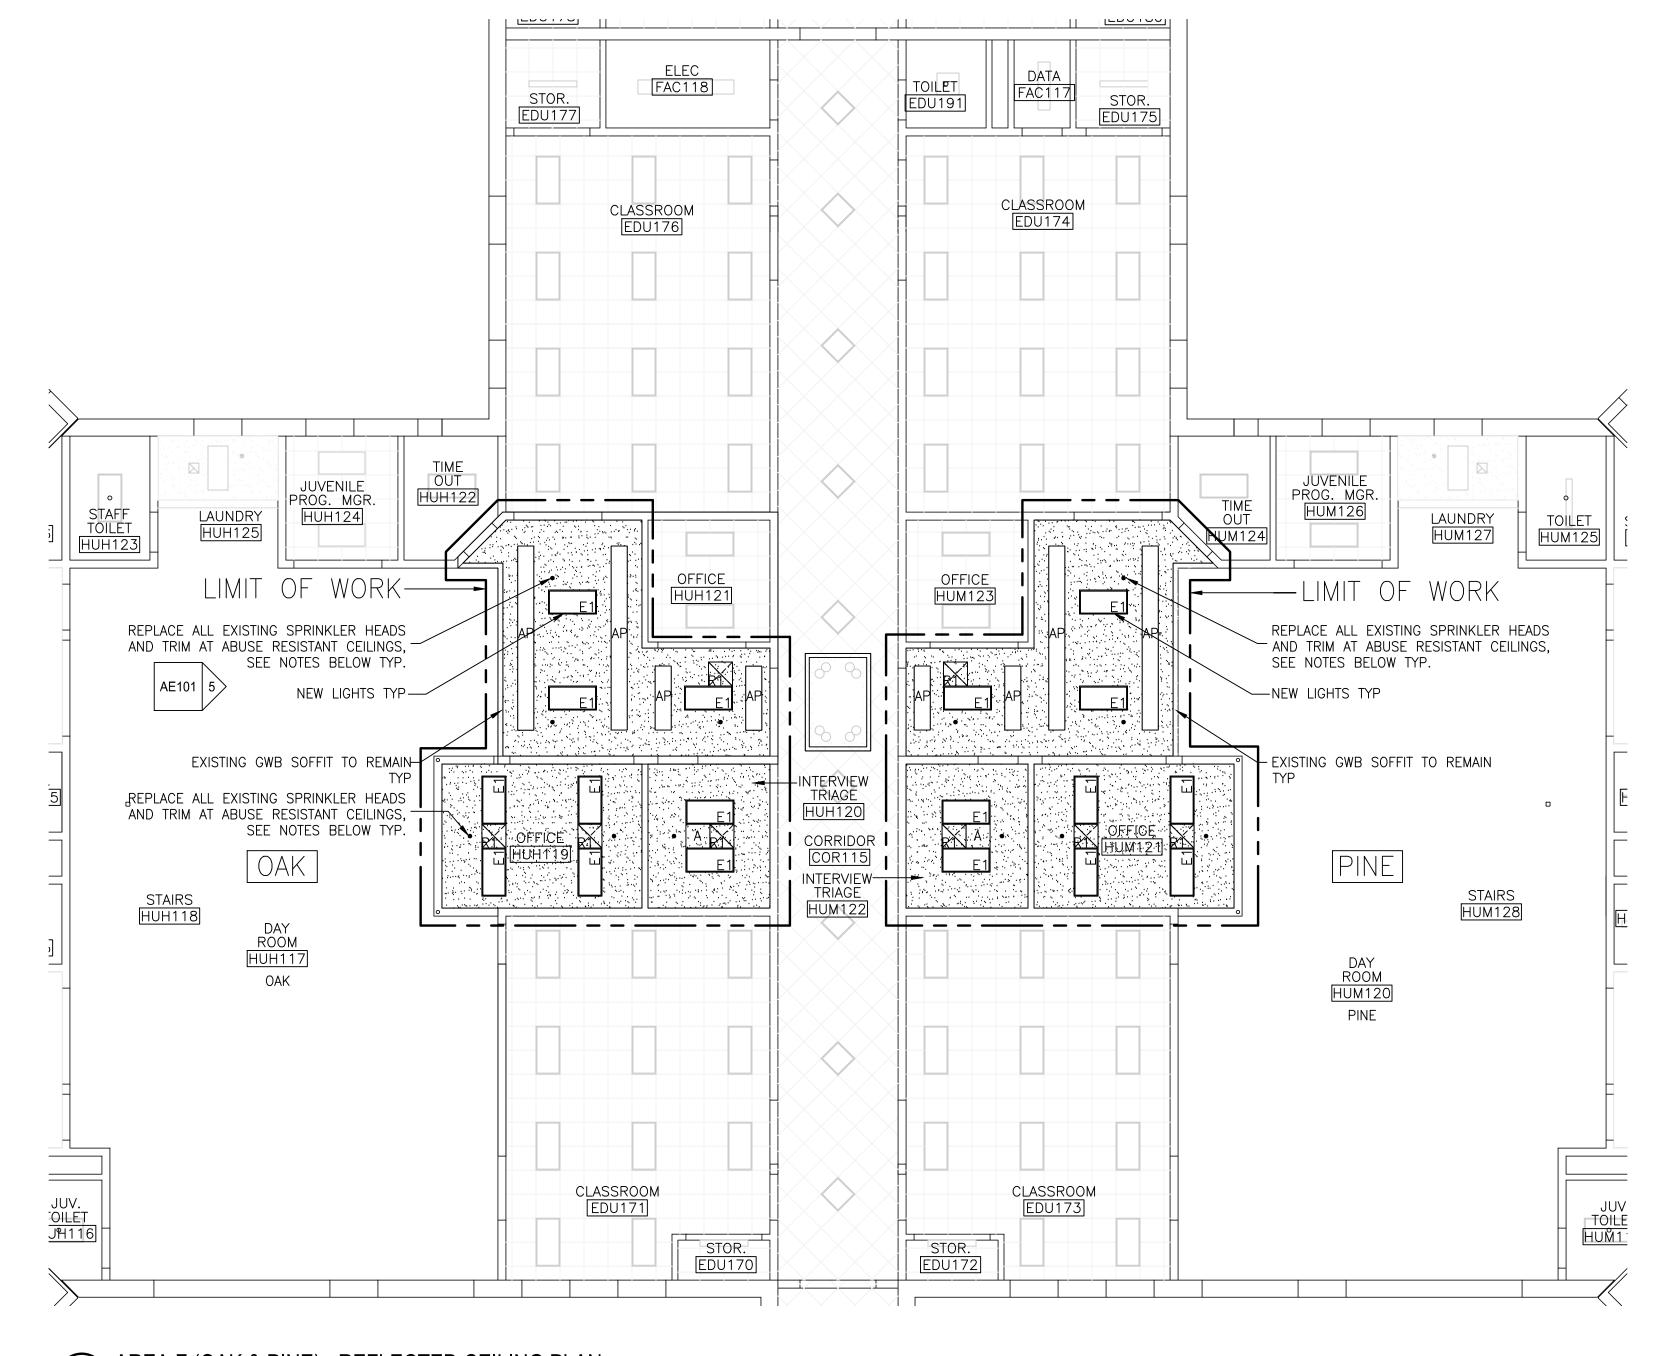

AREA F (OAK & PINE) - REFLECTED CEILING PLAN


1/8" = 1'-0"

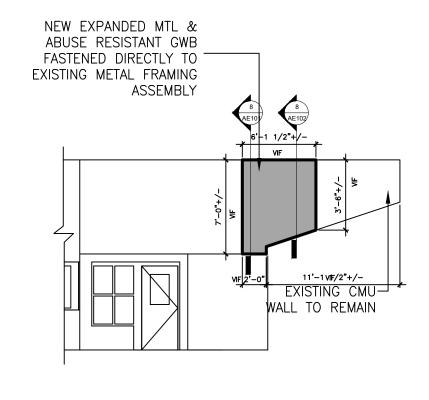

5 INTERIOR ELEVATION

1/8" = 1'-0"

TYPICAL SECTION DETAIL
1 1/2" = 1'-0"

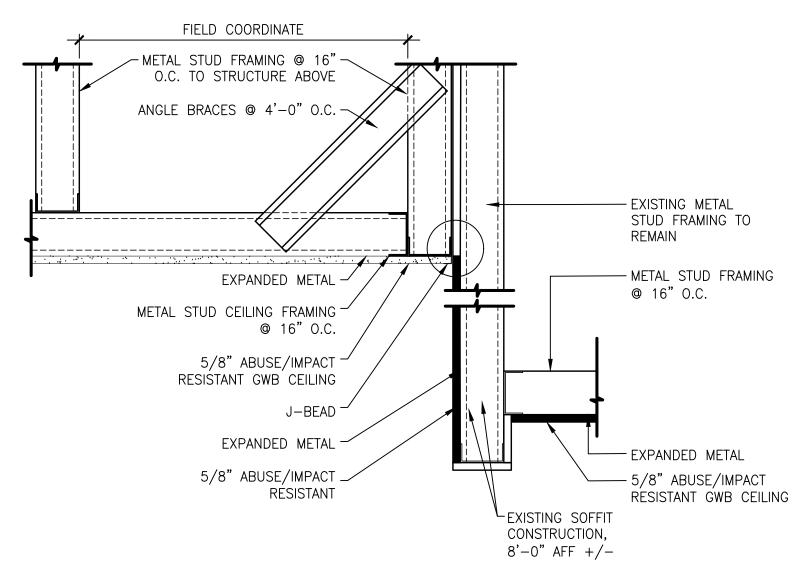

KEY PLAN N.T.S. Description **ISSUED FOR CONSTRUCTION**

LONG CREEK YOUTH

DEVELOPMENT CENTER

CEILING REPLACEMENT

Architecture - Engineering - Planning

All reproduction & intellectual property rights reserved

75 Washington Ave., Suite 3A

Portland, Maine 04101


1.877.700.7678 www.smrtinc.com


© 2024 SMRT INC.
In Association With

08-26-25

SHEET TITLE: AREA F (OAK & PINE) 1ST & **MEZZANINE LEVEL** REFLECTED CEILING PLAN

Original drawing is 30" x 42" - Do not scale contents of this drawing. SCALE: AS NOTED DESIGNED BY: DJM SMRT PROJECT #: 25014 DRAWN BY: DJM

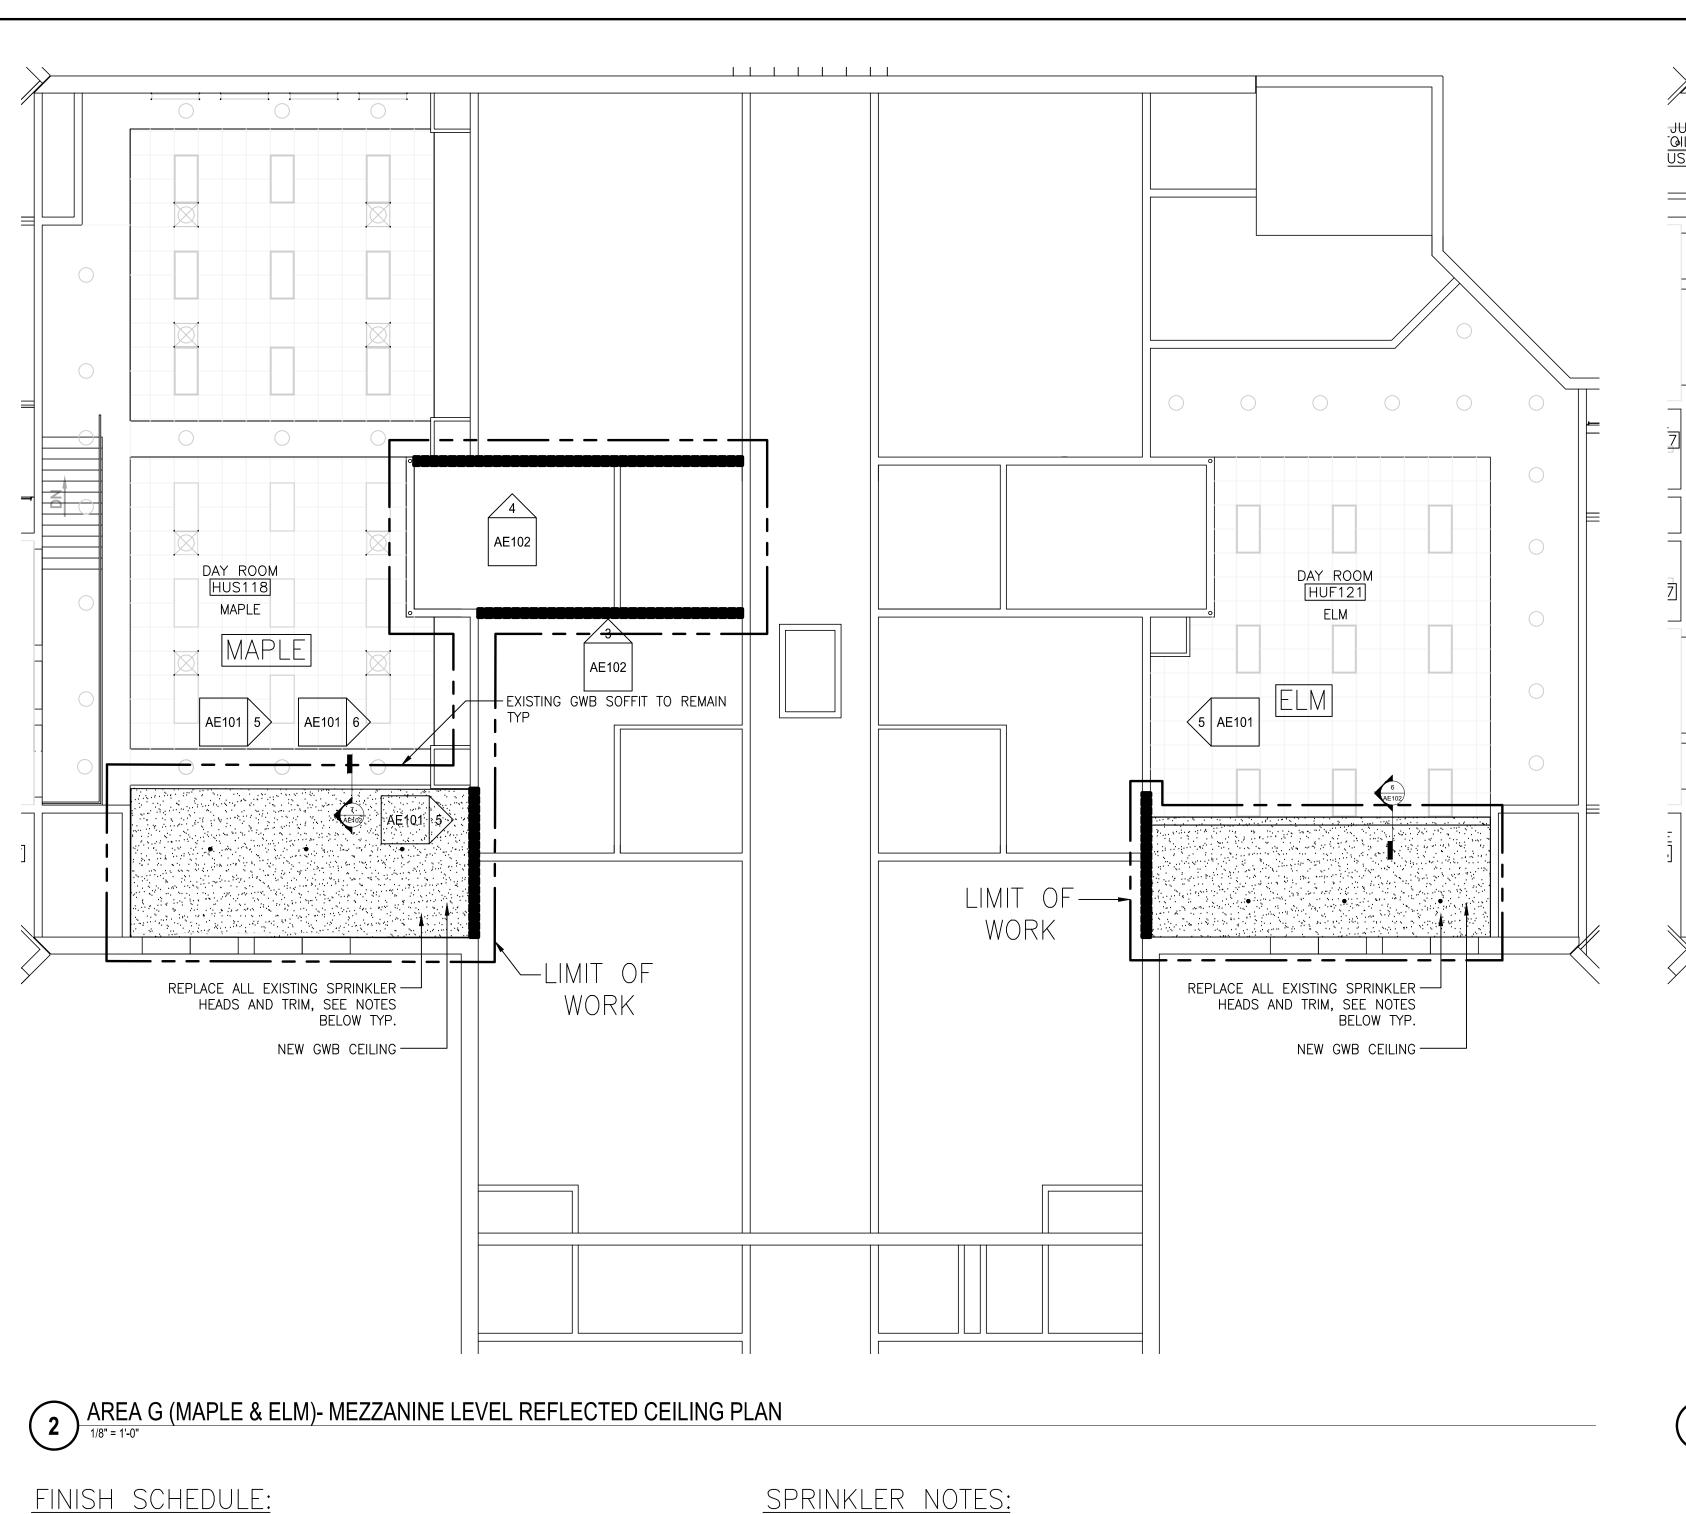

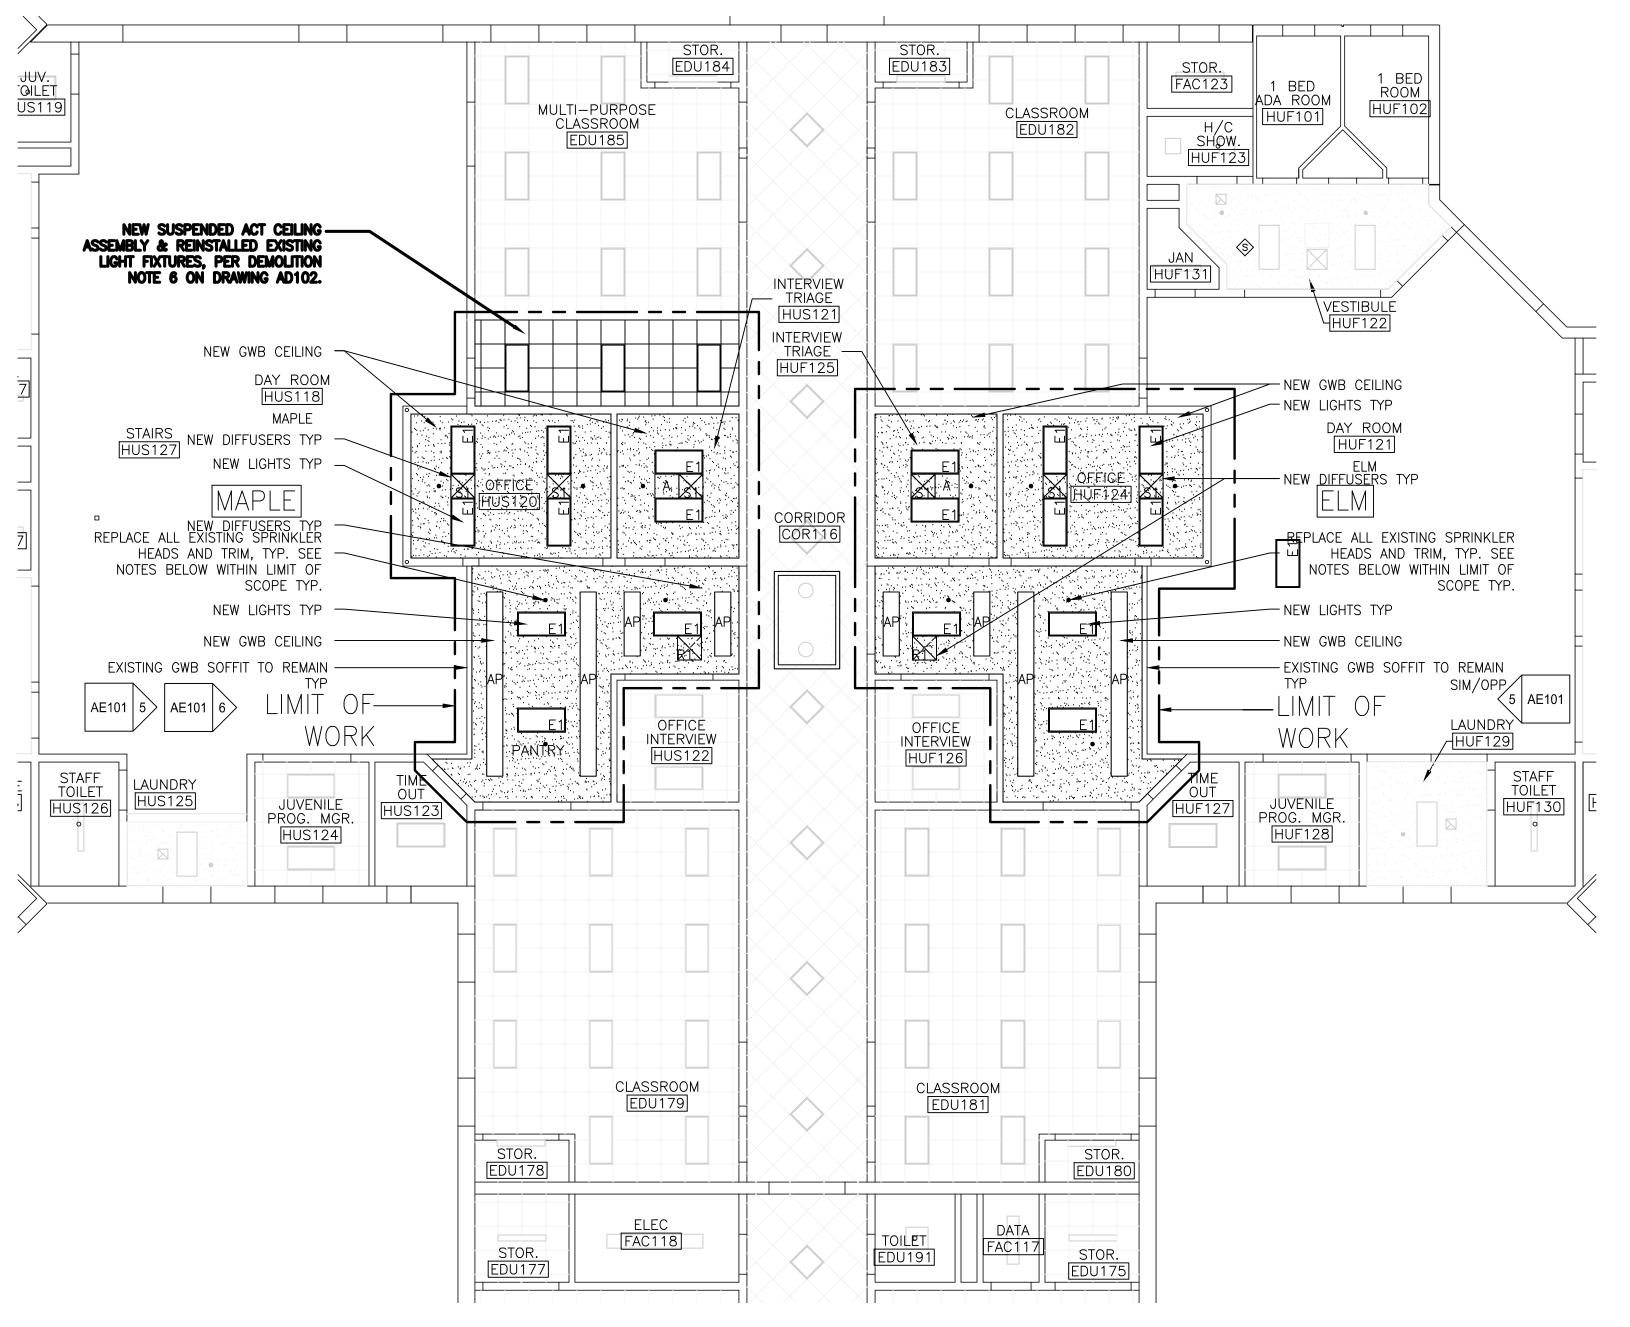

AREA G (MAPLE & ELM) - REFLECTED CEILING PLAN

1/8" = 1'-0"

STUDS TO REMAIN

CEILING PLANS

INSÚLATION

3 1/2" BATT

FINISH SCHEDULE: ROOM NUMBER SEE PLAN.

ROOM NAME SEE PAN. EXISTING TO REMAIN. REPAIR ALL DAMAGE DUE TO CONSTRUCTION TO MATCH EXISTING. EXISTING TO REMAIN, REPAIR ALL DAMAGE DUE TO CONSTRUCTION TO MATCH EXISTING EXISTING TO REMAIN, REPAIR ALL DAMAGE DUE TO CONSTRUCTION TO MATCH EXISTING. CEILING IMPACT AND ABUSE RESISTANT DRYWALL, PAINTED.

EXIST. CEILING PATCH/REPAIR EXISTING SURFACE, PAINTED.

LEGEND

2x2 SUSPENDED CEILING PANEL AND GRID ASSEMBLY.

2x4 SUSPENDED CEILING PANEL AND GRID ASSEMBLY.

ACCESS PANEL

ACOUSTIC PANELS EXPANDED METAL & ABUSE RESISTANT GWB SUPPORTED

BY NON-STRUCTURAL METAL FRAMING

2x2 LIGHT FIXTURE. 2x4 LIGHT FIXTURE.

1x4 LIGHT FIXTURE.

CEILING MOUNTED EXIT LIGHT.

RETURN AIR GRILLE

SUPPLY AIR GRILLE

EXHAUST AIR GRILLE. SPRINKLER HEAD.

UNLESS NOTED OTHERWISE.

CEILING MOUNTED SPEAKER.

ACCESS PANEL, SEE NOTE 6. ARCHITECTURAL NOTES:

1. SEE GENERAL NOTES GOO1. 2. APPLICABLE CODE: MAINE UNIFORM BUILDING AND ENERGY CODE (MUBEC) WHICH INCLUDES 2021 IBC, 2021 IEBC, & 2021 IECC. 3. CEILING AND DEVICE REPLACEMENT WORK IS LIMITED TO AREAS NOTED

4. PAINT NEW CEILINGS AND SOFFITS SHERWIN WILLIAMS EXTRA WHITE

- (SW7006). 5. ALIGN CEILING ITEMS AS SHOWN, WITH COMMON CENTERLINES, TYPICALLY. CENTER ITEMS IN CEILINGS, OR IN AREAS UNLESS
- INDICATED OTHERWISE. 6. AP: PROVIDE 24"x24" DETENTION GRADE ACCESS PANELS AT ALL VALVES, EQUIPMENT, EQUIPMENT RESET SWITCHES, DUCT SMOKE DETECTORS AND ELECTRICAL JUNCTION BOXES. COORDINATE WITH ALL
- TRADES. SEE PLANS FOR MINIMUM AMOUNT OF PANELS REQUIRED. 7. CJ: DRYWALL CONTROL JOINT. 8. FIRE SPRINKLERS ARE EXISTING TO REMAIN UNLESS NOTED OTHERWISE. 7. FIRE SPRINKLERS ARE SHOWN FOR COORDINATION PURPOSES ONLY,

FIELD VERIFY ACTUAL LOCATIONS AND AMOUNT AS REQUIRED. 9. DIMENSIONS ARE FROM FACE OF GWB TO CENTERLINE OF DEVICES

- 1. ROTATE SPRINKLER HEADS UPWARD AND PROVIDE UPRIGHT HEADS DURING CONSTRUCTION OF NEW CEILING. ALL WORK SHALL BE COMPLETED IN ACCORDANCE WITH NFPA 13 AND THE AUTHORITY HAVING JURISDICTION.
- INSTALL NEW DETENTION GRADE SPRINKLER HEADS TO PROVIDE COMPLETE SPACE COVERAGE IN ACCORDANCE WITH NFPA 13 REQUIREMENTS AND THE AUTHORITY HAVING JURISDICTION. PRODUCT TO BE TYCO RAVEN 5.6K INSTITUTIONAL SPRINKLERS OR APPROVED EQUAL
- 3. ALL SPRINKLER SHUT DOWNS SHALL HAPPEN DURING NORMAL WORK HOURS UNLESS PREVIOUSLY AUTHORIZED BY THE OWNER. NO SHUT-DOWN SHALL OCCUR OVER-NIGHT.

LIGHTING FIXTURES:

EFFICIENCY MAINE ELIGIBLE:

E1: MEDIUM SECURITY 2x4 LIGHT. BASIS OF DESIGN: FAIL SAFE MODEL (COOPER LIGHTING) FMR-D-24-4-LD4-3-STD-40-UNV-81/86-EDC-1-SWBR-SF3-PF24-4FT.

ELECTRICAL NOTES:

1. CONNECT NEW FIXTURES TO EXISTING FIXTURE WHIPS AND LIGHTING CIRCUITS.

MECHANICAL NOTES:

- 1. CONTRACTOR SHALL MEASURE AND DOCUMENT EXISTING AIRFLOWS PRIOR TO DEMOLITION AND CONSTRUCTION.
- 2. R1: MINIMUM SECURITY GRILLE, BASIS OF DESIGN: PRICE MODEL MSL GRILLE W/ LATTICE FACEPLATE AND SURFACE MOUNT BOARDER, SURFACE MOUNT BORDER. BORDER SHALL BE FASTENED WITH TAMPERPROOF SCREWS.

EXIST MTL ROOF DECK TO-

EXIST 4" 22GA DEEP LEG -

HEAD TRACK TO REMAIN

EXIST 1 1/2" BENT MT. -

REMOVE DAMAGED OF 5/8"——/

EXIST MASONRY WALL TO-

EXISTING METAL ROOF &

CEILING TYPE & HEIGHT —

CEILING PLANS

AS SHOWN ON REFLECTED

SECTION DETAIL

1 1/2" = 1'-0"

FLASHING WHERE SHOWN

IN PHOTOS & ELEVATIONS.


GWB AND REPLACE W/ NEW

CHANNÉL TO REMAIN


5/8"GWB

REMAIN


- 3. GRILLES SHALL BE SIZED AS FOLLOWS: 22x10 NECK, 801-1570 CFM.
- 4. INSTALLATION OF GRILLES SHALL INCLUDE CONNECTING THE EXISTING RIGID DUCTWORK TO THE PROPOSED GRILLE, AND ANY ASSOCIATED DUCTWORK MODIFICATIONS NECESSARY FOR INSTALLATION.
- 5. S1: MINIMUM SECURITY DIFFUSER, BASIS OF DESIGN: PRICE MODEL MSD LOUVERED FACE 4-WAY DIRECTIONAL DIFFUSER WITH LATTICE FACEPLATE AND TYPE 1 SURFACE MOUNT BORDER. BORDER SHALL BE FASTENED WITH TAMPERPROOF SCREWS.
- 6. DIFFUSERS SHALL BE SIZED AS FOLLOWS: 6x6 NECK, 0 -150 CFM; 9x9 NECK, 151-300 CFM; 12x12 NECK, 301-500 CFM. 7. INSTALLATION OF DIFFUSERS SHALL INCLUDE FLEXIBLE DUCT CONNECTING THE EXISTING RIGID DUCTWORK TO THE PROPOSED DIFFUSER. FLEXIBLE DUCT SHALL BE UL 181, CLASS 1, 2-PLY VINYL FILM SUPPORTED BY HELICALLY WOUND, SPRING-STEEL WIRE WITH R-8 FIBEROUS GLASS INSULATION AND
- POLYETHYLENE VAPOR BARRIER FILM. 8. PROVIDE SQUARE TO ROUND DUCT CONNECTORS BETWEEN THE DIFFUSER NECK AND THE FLEXIBLE DUCTWORK.

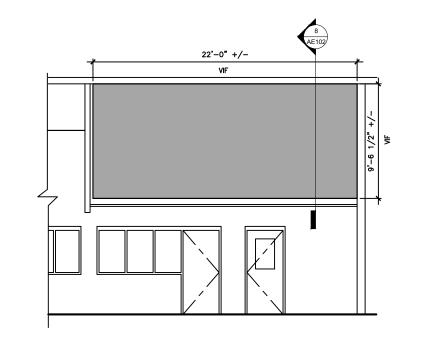



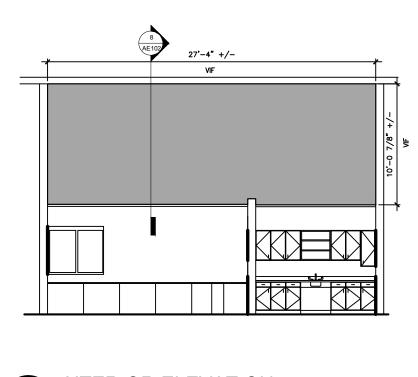

3 INTERIOR ELEVATION

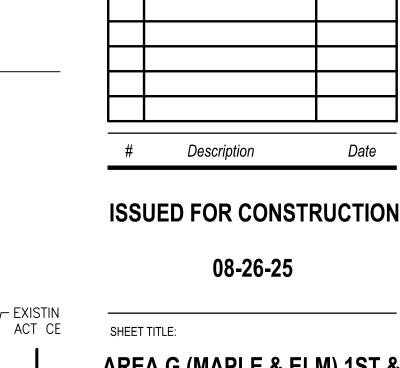

-EXISTING SOFFIT

CONSTRUCTION,

AREA G (MAPLE & ELM) 1ST & **MEZZANINE LEVEL**

REFLECTED CEILING PLAN

N.T.S.

LONG CREEK YOUTH

DEVELOPMENT CENTER

CEILING REPLACEMENT

Architecture - Engineering - Planning

All reproduction & intellectual property rights reserved


75 Washington Ave., Suite 3A Portland, Maine 04101


1.877.700.7678

© 2024 SMRT INC.
In Association With

www.smrtinc.com

Original drawing is 30" x 42" - Do not scale contents of this drawing. AS NOTED DESIGNED BY: DJM SMRT PROJECT #: 25014 DRAWN BY: DJM

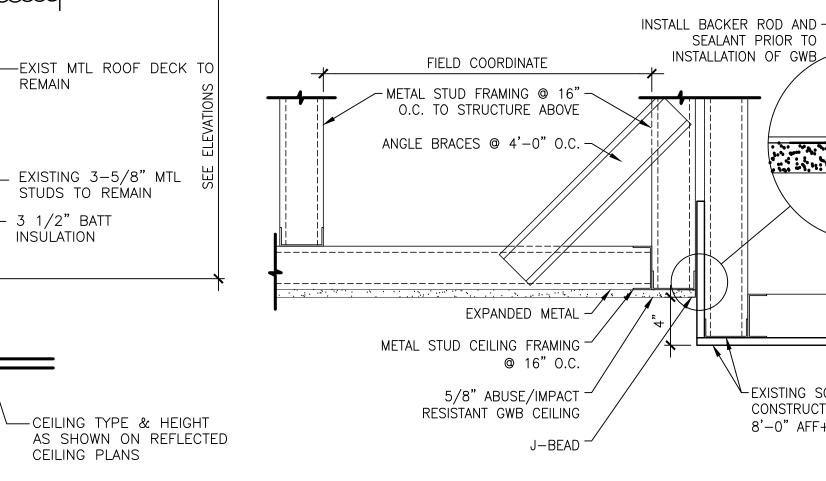

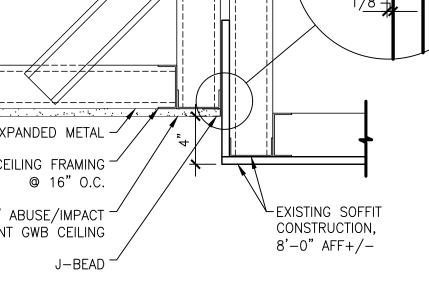



TYPICAL SOFFIT DETAIL

1 1/2" = 1'-0"

EXPANDED METAL -

5/8" ABUSE/IMPACT -

RESISTANT GWB CEILING

@ 16" O.C.

J-BEAD

FIELD COORDINATE

−METAL STUD FRAMING @ 16"−

O.C. TO STRUCTURE ABOVE

ANGLE BRACES @ 4'-0" O.C

METAL STUD CEILING FRAMING