# MCJA - BUILDING C LIMITED RENOVATIONS 15 OAK GROVE RD VASSALBORO, ME 04989

PERMIT SET DATE OF ISSUE: APR 16, 2025

### ADDENDUM <sup>2</sup> APRIL 30, 2025

# **PROJECT TEAM**

### **OWNER:**


Maine Criminal Justice Academy 15 Oak Grove RD Vassalboro, ME 04989 Jack Peck, Director jack.d.peck@maine.gov

### **ARCHITECTS:**

Simons Architects 75 York Street Portland, ME 04101 207.772.4656 Rvan Kanteres, AIA ryan@simonsarchitects.com Pat Barendt, AIA pat@simonsarchitects.com

### STRUCT ENGINEERING,

**MEP/FP ENGINEERING:** Allied Engineering | a Salas O'Brien Company 160 Veranda St. Portland, ME 04103 207.221.2260 Anthony Davis, P.E., LEED AP anthony.davis@salasobrien.com Kenneth Coley, P.E. kenneth.coley@salasobrien.com **Geoff Chartier** *jeff.chartier@salasobrien.com* James Fox, P.E. james.fox@salasobrien.com

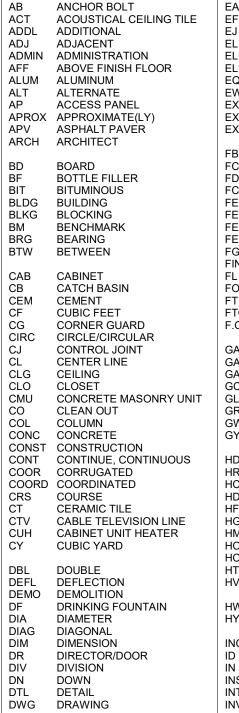

ABUSE RESISTAN

ELEC EQ EWC EXAM	EAST EACH EXHAUST FAN EXPANSION JOINT ELEVATION ELECTRIC/ELECTRICAL EQUAL ELECTRIC WATER COOLER EXAMINATION EXISTING EXTERIOR
FCO FD FCP FE FEC/SR FEC/FR FG FIN FL FOS FT FTG	FURNISHED BY OWNER FLOOR CLEAN OUT FLOOR DRAIN FIRE CONTROL PANEL FIRE EXTINGUISHER FIRE EXTINGUISHER CABINET FEC, SEMI RECESSED FEC. FULLY RECESSED FIBERGLASS FINISH FLOOR FACE OF STUD FOOT FOOTING FACE OF
GAL	GAUGE GALLON GALVANIZED GENERAL CONTRACTOR GLASS GRANITE GYPSUM WALL BOARD GYPSUM
HD HR HC HFS HGT HM HO HORZ HTG HVAC HW HYD	HIGH DENSITY HOUR HOLLOW CORE HARDWARE HALF FULL SCALE HEIGHT HOLLOW METAL HOLD OPEN HORIZONTAL HEATING HEATING, VENTILATION & AIR CONDITIONING HOT WATER HYDRANT
INCL ID IN INSUL INT INV	INCLUDE/INCLUDING INSIDE DIAMETER INCH INSULATE/INSULATION INTERIOR INVERT

**ARCHITECTUAL ABBREVIATIONS** 

JAN JC	JANITOR JANITOR CLOSET	QT
JT	JOINT	R RD
KIT	KITCHEN	REC RECT
LAM LAV LCC LF LGT LIN	LAMINATE/LAMINATED LAVATORY LEAD COATED COPPER LINEAR FOOT LIGHT LINEN	REG REF REQ REFR REINF RESIL REV RFG
MTRL MAS MAX MECH	MATERIAL MASONRY MAXIMUM MECHANICAL	RM RND RO
MED MFR MGR MH MIN MISC MO MOLD MR MTD MTG MTL	MEDICAL MANUFACTURER MANAGER MANHOLE MINIMUM MISCELLANEOUS MASONRY OPENING MOLDING MOISTURE RESISTANT MOUNTED MOUNTING METAL	S SAN SC SD SECT SF SHT SIM SPEC SPF1 SQ STC
N NATL NIC NL NO NTS	NORTH NATURAL NOT IN CONTRACT NIGHT LIGHT NUMBER NOT TO SCALE	STD STL STOR SS SUSP
OC OFCI OZ	ON CENTER OWNER FURNISHED CONTRACTOR INSTALLED ONCE	
PNL PNT PART BE PC PERM	PANEL PAINT PARTICLE BOARD PIECE PERIMETER	

SUSP SUSPENDED

ΜΑΤ	ERIALS

STONE

PLYWOOD

`я <sup>4</sup>4 . 4

BARE

# **ARCHITECTURAL SYMBOLS**

PNT

PREP

PSF

PSI

PT

PTD

PLATE

PLAM PLASTIC LAMINATE

PLAS PLASTER

PLYWD PLYWOOD

PVMT PAVEMENT

PAINT

POLY POLYURETHANE


PAINTED

PREPARATION

POUNDS / SQUARE FOOT

POUNDS / SQUARE INCH

PRESERVATIVE TREATED

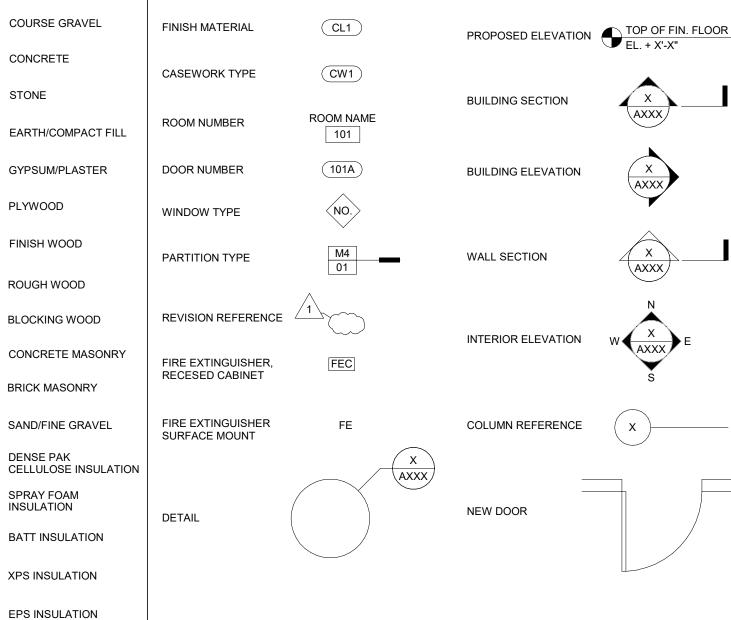


### PROJECT SUMMARY

**RENOVATION OF FLOORS** 2, 3, AND 4 AT MCJA BUILDING C.

**EXISTING DORMITORY SPACES** ON FLOOR 2 WILL RECEIVE NEW MECHANICAL SYSTEMS AND REFRESHED FINISHES; SPATIAL RELATIONSHIPS WILL REMAIN AS EXISTING.

EXISTING DORMITORY SPACES ON FLOORS 3 AND 4 WILL BE **RECONFIGURED WITH NEW** WALLS, NEW RESTROOMS, AND NEW MEP SYSTEMS.

TOTAL PROJECT AREA EXCLUSIVE OF EXTERIOR WALLS IS 11,095 GSF.

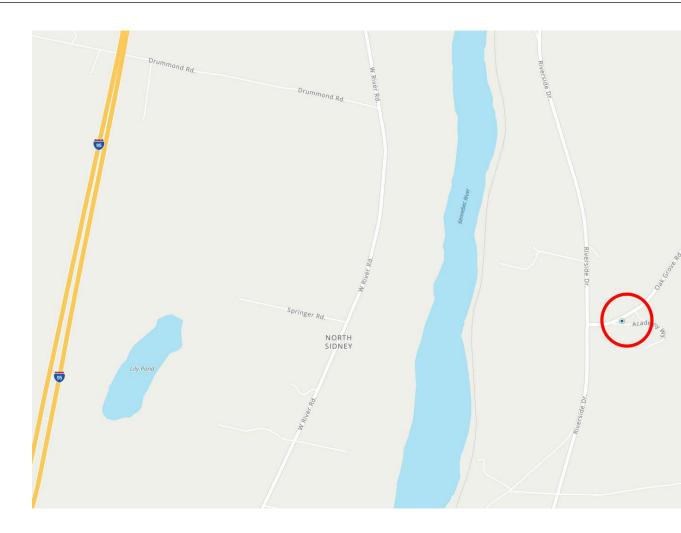

# **DRAWING LIST**

	• ISSUED IN SET 0 INCORPORATED WITHOUT CHANGES					זכ ואר ו
	SHEET NO.	SHEET NAME	2025.04.08 - ISS. FOR BID	2025.04.30 - ADDENDUM	2025.05.06 - ADDENDUM	TBD
	G001 G002	COVER SHEET LIFE SAFETY PLANS				
	G002 G003	CODE SUMMARY				
Ц С	G004	PARTITION TYPES & TYP. DETAILS				
	G005	FIRE DETAILS				
	G006	ACCESSIBILITY REQUIREMENTS	•			
C	AD102	SECOND FLOOR DEMO PLAN				
	AD103	THIRD FLOOR DEMO PLAN	•			
	AD104	FOURTH FLOOR DEMO PLAN				
DN	AD105	ROOF DEMO PLAN				
			-		-	1
	A102	BUILDING C - SECOND FLOOR PLAN				
		BUILDING C - THIRD FLOOR PLAN BUILDING C - FOURTH FLOOR PLAN				
	A104 A105	BUILDING C - FOURTH FLOOR PLAN BUILDING C - ROOF PLAN				<u> </u>
	_	ENLARGED BATH PLANS & ELEVATIONS				
RCHIT	A112	INTERIOR ELEVATIONS - DORMS				
AF	A113	INTERIOR ELEVATIONS - CORRIDORS	•			
	A122	SECOND FLOOR FINISH PLAN				
	A123	THIRD FLOOR FINISH PLAN				
	A124	FOURTH FLOOR FINISH PLAN				
	A125	RESTROOM TILE LAYOUT DETAILS				
	A126	FINISHES BOARD				
	A132	SECOND FLOOR RCP				
	A133 A134	THIRD FLOOR RCP FOURTH FLOOR RCP				
	A134 A143	THIRD FLOOR FURNITURE PLAN				
	A144	FOURTH FLOOR FURNITURE PLAN				
	A301	BUILDING SECTIONS	•			
	A302	BUILDING SECTIONS				
	A303	BUILDING SECTIONS				
	A400	DEDUCT ALT 1				
	A401	PLAN DETAILS				<u> </u>
	A411	VERTICAL DETAILS				<u> </u>
	A421 A422	MILLWORK DETAILS TILE & TRANSITION DETAILS				<u> </u>
	A422 A601	DOOR SCHEDULES				
	A602	DOOR DETAILS				
	A603	SIGNAGE SCHEDULE	•			
	A604	EXISTING WINDOWS FOR ROLLER SHADES				
	S000	STRUCTURAL GENERAL INFORMATION STRUCTURAL SPECIAL INSPECTIONS				
	S001 S102	EXISTING SECOND FLOOR PLAN				
	S102	EXISTING THIRD FLOOR PLAN				
	S104	EXISTING FOURTH FLOOR PLAN				
	S105	EXISTING ROOF PLAN	•			
	S110	STRUCTURAL FRAMING PART PLANS				
	S500	STRUCTURAL DETAILS				
	P000	PLUMBING AND HVAC NOTES, LEGEND, AND ABBREVIATIONS				
	PD102	PLUMBING DRAINAGE DEMOLITION PLAN - SECOND	-			-
		FLOOR				
	PD103	PLUMBING DRAINAGE DEMOLITION PLAN - THIRD FLOOR				
	PD104	PLUMBING DRAINAGE DEMOLITION PLAN - FOURTH FLOOR	•			<u> </u>
	PD201	PLUMBING SUPPLY DEMOLITION PART PLANS				<u> </u>
	PD202	PLUMBING SUPPLY DEMOLITION PLAN - SECOND FLOOR				
1	ציוערויקן			1	1	1

PD203 PLUMBING SUPPLY DEMOLITION PLAN - THIRD FLOOR

SHEET NO.	
<b>D</b> ( <b>a</b> (	
P101	PL
P102	PL
P103	PL
P104	PL
P202	PL
P203	PL


P204

Ċ.	MD104	ME
ШШ	MD105	ME
	MD202	ME
	MD203	ME
	MD204	ME
	MH101	ME
	MH102	ME
	MH103	ME
	MH104	ME
	MH105	ME
	MP102	ME
	MP103	ME
	MP104	ME
	M500	ME
	M501	ME
	M600	ME
ICAL	E000	ELI
RIC	E001	ELI
CT	EL102	LIG
ELECTRI	EL103	LIG
ш	EL104	LIG
	EL600	LIG
	EP100	PO
	EP102	PO
	EP103	PO
	EP104	PO
	EP105	PO
	E400	ELI
	E500	ON
	E501	ELI
	E600	ELI
	E601	PA
	E601	PA

DEDUCT ALTERNATE 1

**DEDUCT ALTERNATE 2** DELETE HEAT PUMPS AND CORRESPONDING OUTDOOR UNITS FROM FLOOR 2 SPACES ONLY. VENTILATION AIR TO REMAIN AS DOCUMENTED.



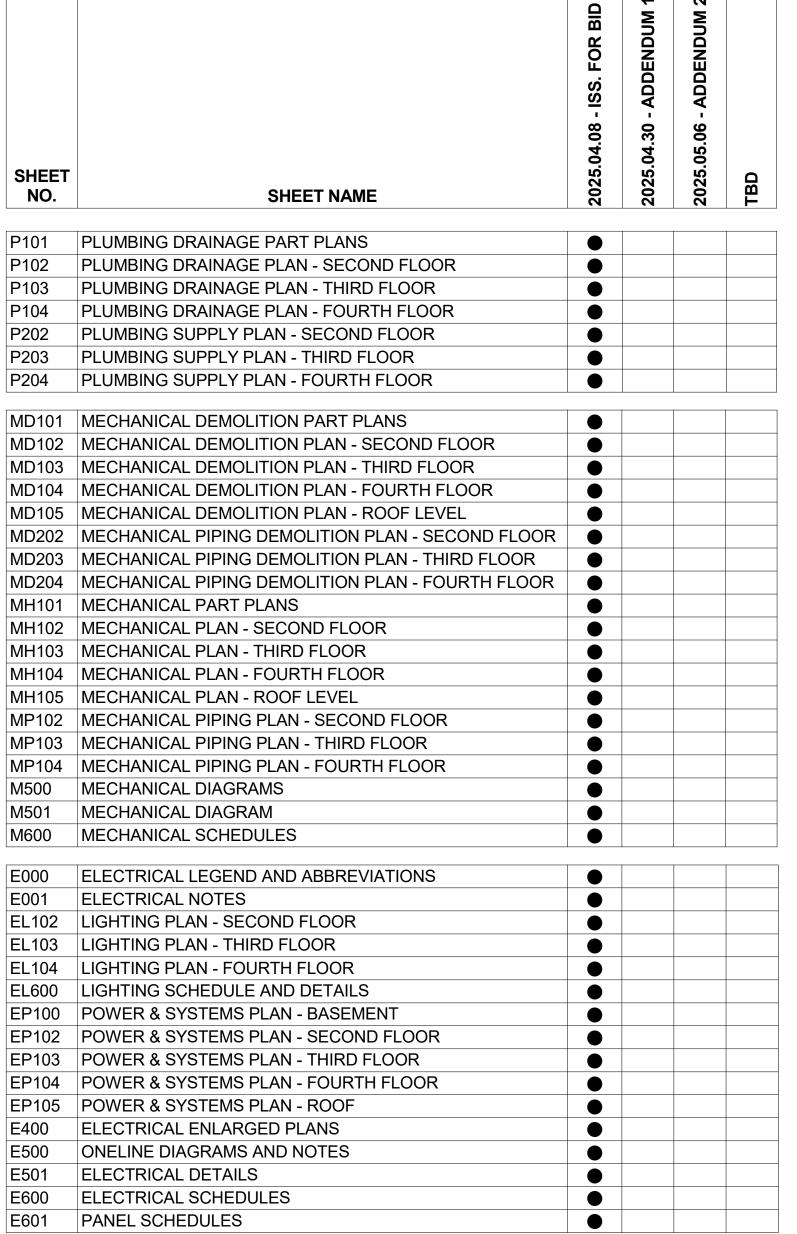

**ALTERNATES** 

DELETE TYPE W6 WALLS FROM PROJECT

PARTIAL LIST OF ASSOCIATED WORK: - EXISTING EXTERIOR WALLS TO REMAIN AND BE REPAINTED ON INTERIOR SIDE. DELETE NEW WINDOW SILLS; REFINISH EXISTING WOOD WINDOW SILLS.

- REDUCE WORK AT WINDOW JAMBS AND HEADS


- DELETE CEILING SOFFIT AT EXTERIOR WALLS ON FLOOR 3.

- DELETE ADJUSTMENT TO RADIATOR PIPING AT EXTERIOR WALLS ON

FLOORS 3 AND 4. - RETAIN EXISTING WIREMOLD AT EXTERIOR WALLS, RECONFIGURE OUTLETS. REFER TO ARCHITECTURAL, MECHANICAL, PLUMBING, AND ELECTRICAL DRAWINGS FOR ADDITIONAL INFORMATION.





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# **COVER SHEET**

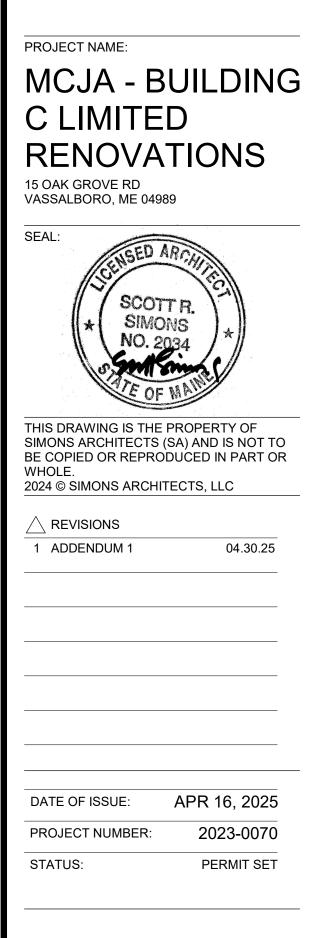
# G001



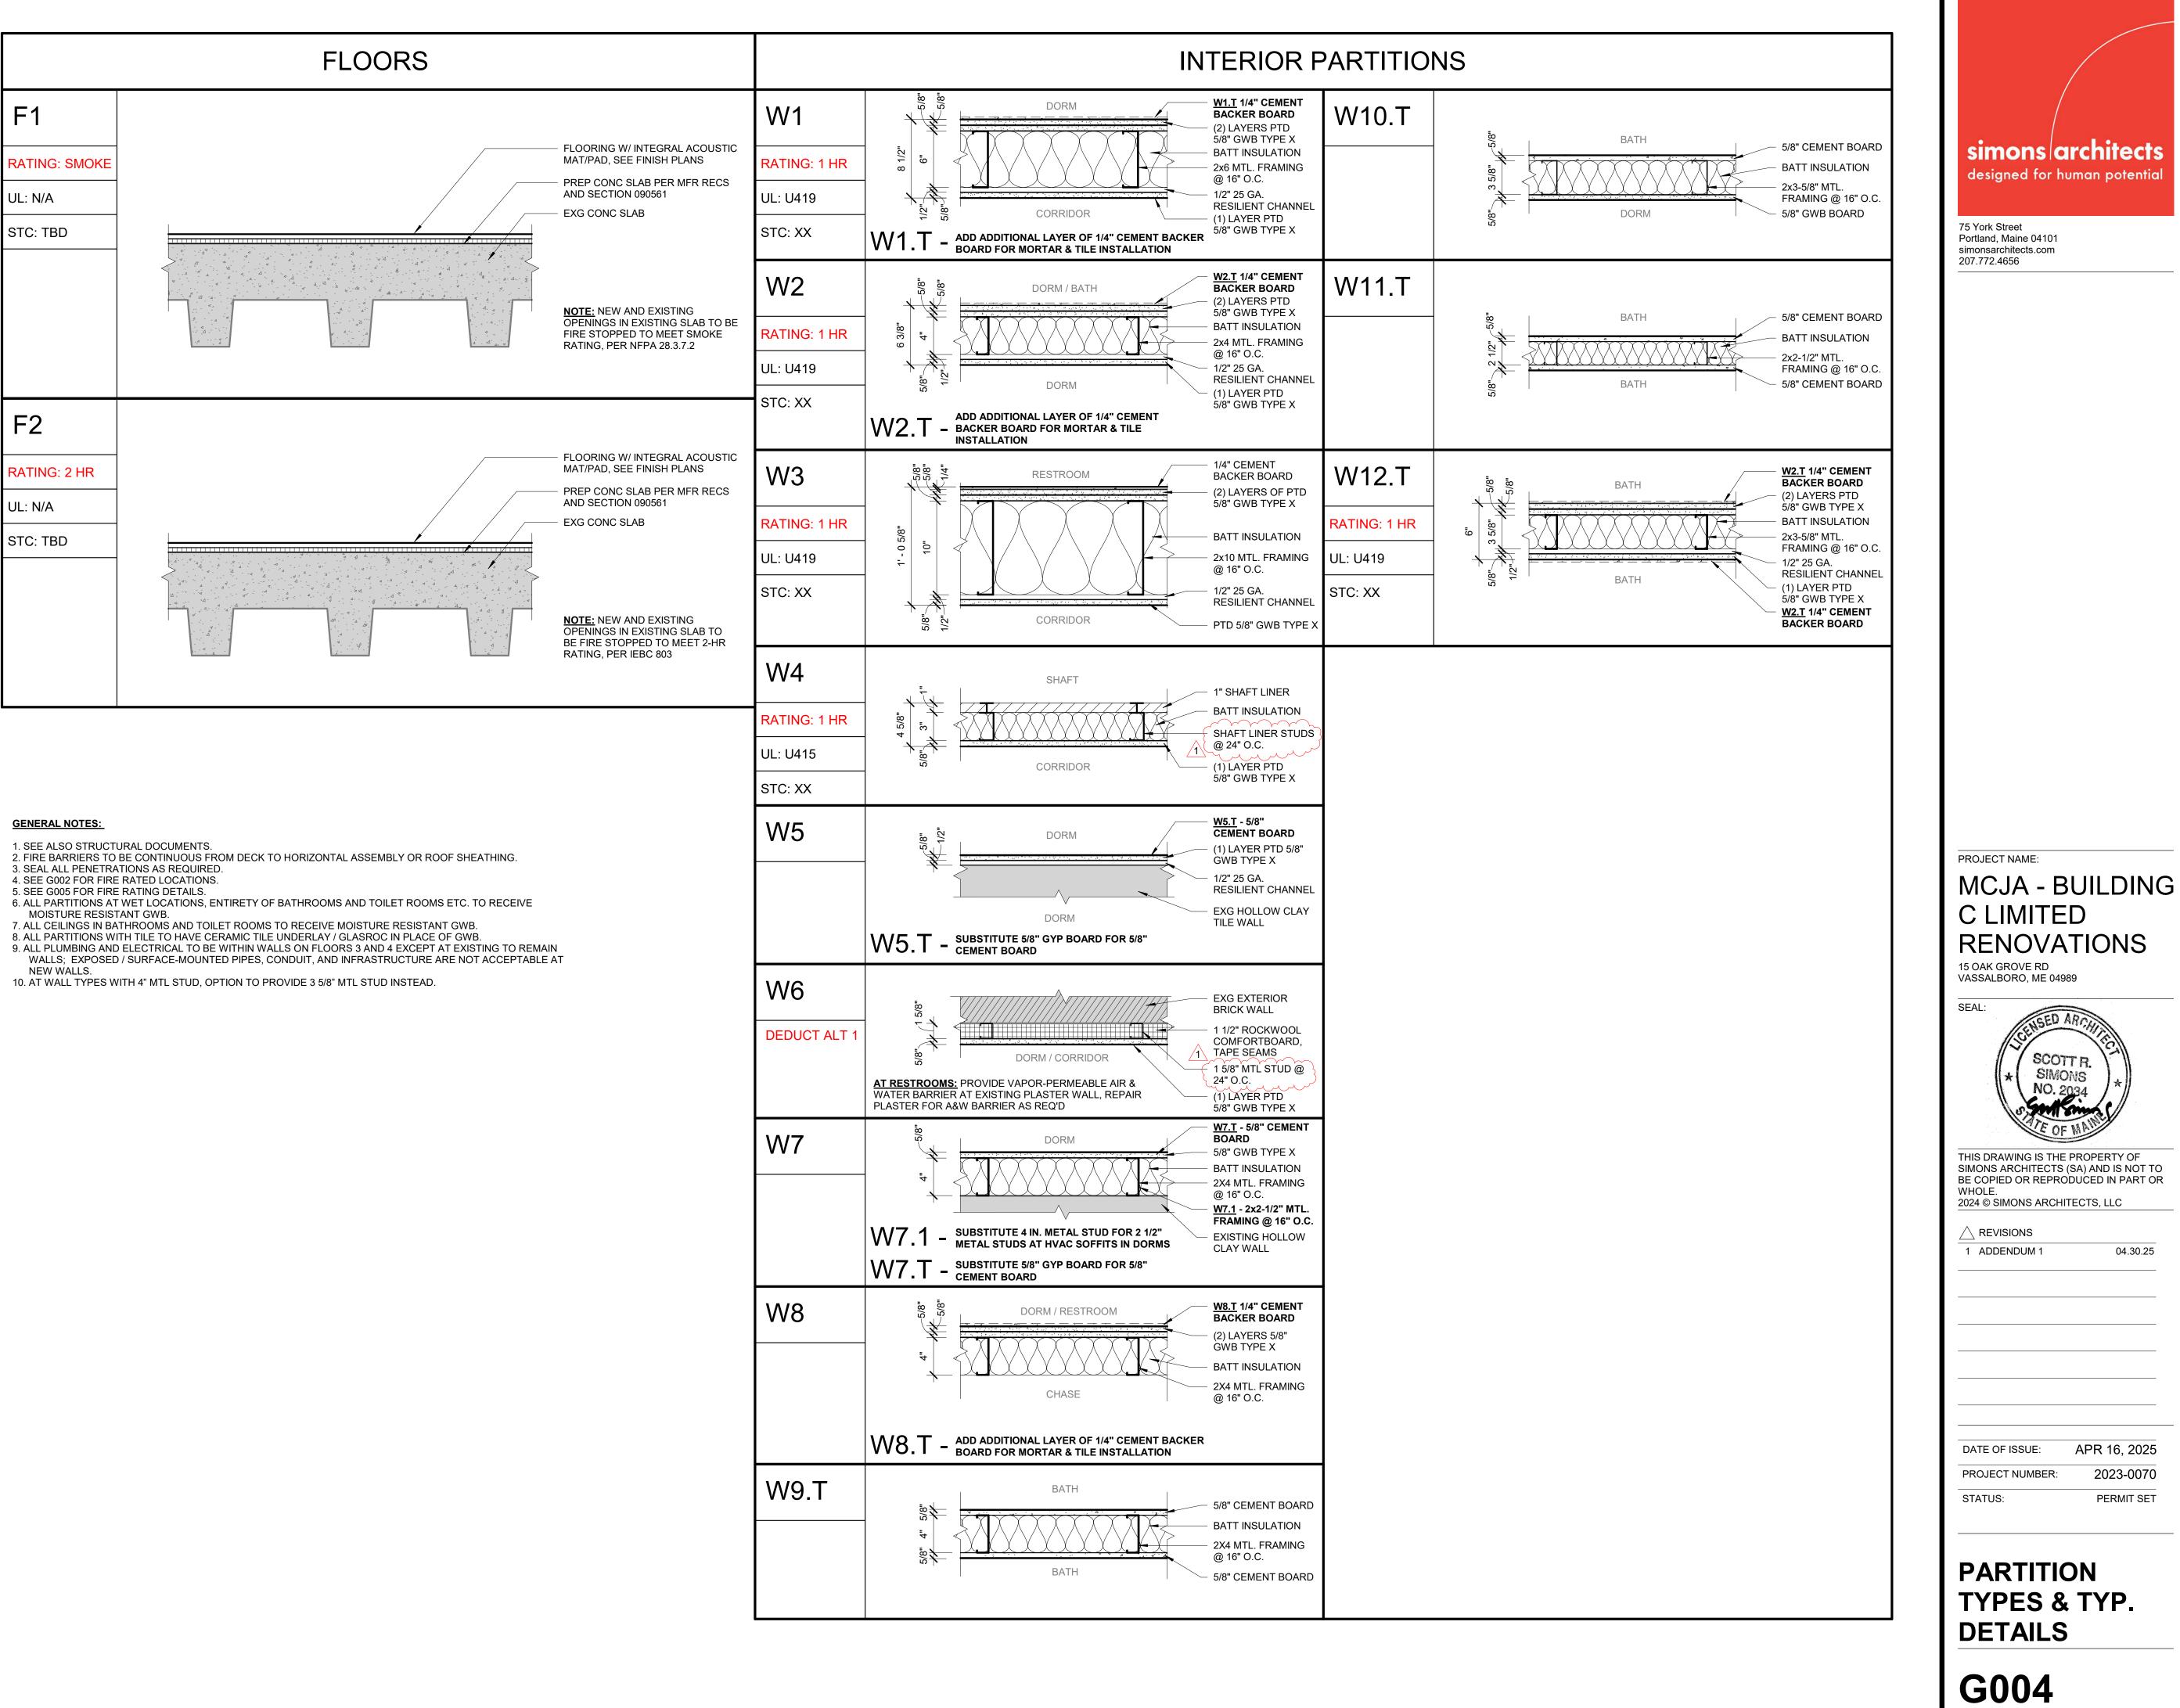

	<u>GENE</u>	RAL DEMOLITION NOTES:		
TCH FLOOR,	A.	G.C. TO PROTECT ADJACENT AREAS NOT AFFECTED BY CONSTRUCTION.		
VARE	В.	G.C. AND SUBCONTRACTOR TO FIELD VERIFY ALL FIELD CONDITIONS PRIOR TO CONSTRUCTION.		
AP WASTE LINE OOR AS	C.	ALL EXISTING MATERIALS NOTED TO BE REMOVED SHALL BE PROPERLY DISPOSED BY G.C. UNLESS NOTED OTHERWISE. OWNER RESERVES THE RIGHT TO RETAIN AN ITEM NOTED FOR DEMOLITION.		
S LOCATION FOR H FLOOR AROUND UCT DWGS.	D.	G.C. SHALL COORDINATE EXTENT OF ALL DEMOLITION WORK WITH NEW CONSTRUCTION. REFER TO COMPLETE DRAWING SET TO COORDINATE DEMOLITION WORK WITH TRADES.	simons architects designed for human potential	
G AND REMOVE GS.	E.	ALL ELECTRICAL, PLUMBING, AND MECHANICAL LOCATED IN WALLS AND CEILINGS NOTED TO BE REMOVED SHALL BE EITHER REMOVED BACK TO THE SOURCE OR LOCATED OUT OF HARM'S WAY. FOR RELOCATIONS IN NEW CONSTRUCTION, G.C. TO COORDINATE.	75 York Street Portland, Maine 04101	
G.	F.	CHIP OUT EXG PLASTER AT ALL WINDOWS ON FLOORS 3 AND 4 TO RECEIVE NEW DRYWALL BEAD. SEE A400. OMIT THIS SCOPE IN DEDUCT ALT 1.	simonsarchitects.com 207.772.4656	
INS & PARTITION	G.	REMOVE ALL LIGHT FIXTURES IN DEMO'D CLGS AND DISPOSE UNLESS OTHERWISE NOTED TO BE SALVAGED.		
LOCATION FOR H ROOF AROUND RUCTURAL &	H.	REFER TO MECHANICAL, ELECTRICAL, AND PLUMBING FOR ADDITIONAL DEMOLITION SCOPE.		
RTHER DEMO	I.	NO DEMOLITION TO EXTERIOR WALLS, TYP, UNO.		
	J.	SPRINKLER IN DEMO CEILING TO BE REMOVED.		
RK, CONDUIT, & ECESSARY AT ALL	K.	FA DEVICES IN DEMO CEILING TO BE REMOVED, SEE EP DWGS.		
DM DEMOLISHED	L.	FILL / SEAL EXISTING FLOOR PENETRATIONS TO MEET REQUIRED SEPARATION REQUIREMENTS. SEE LIFE SAFETY PLANS ON G002.		

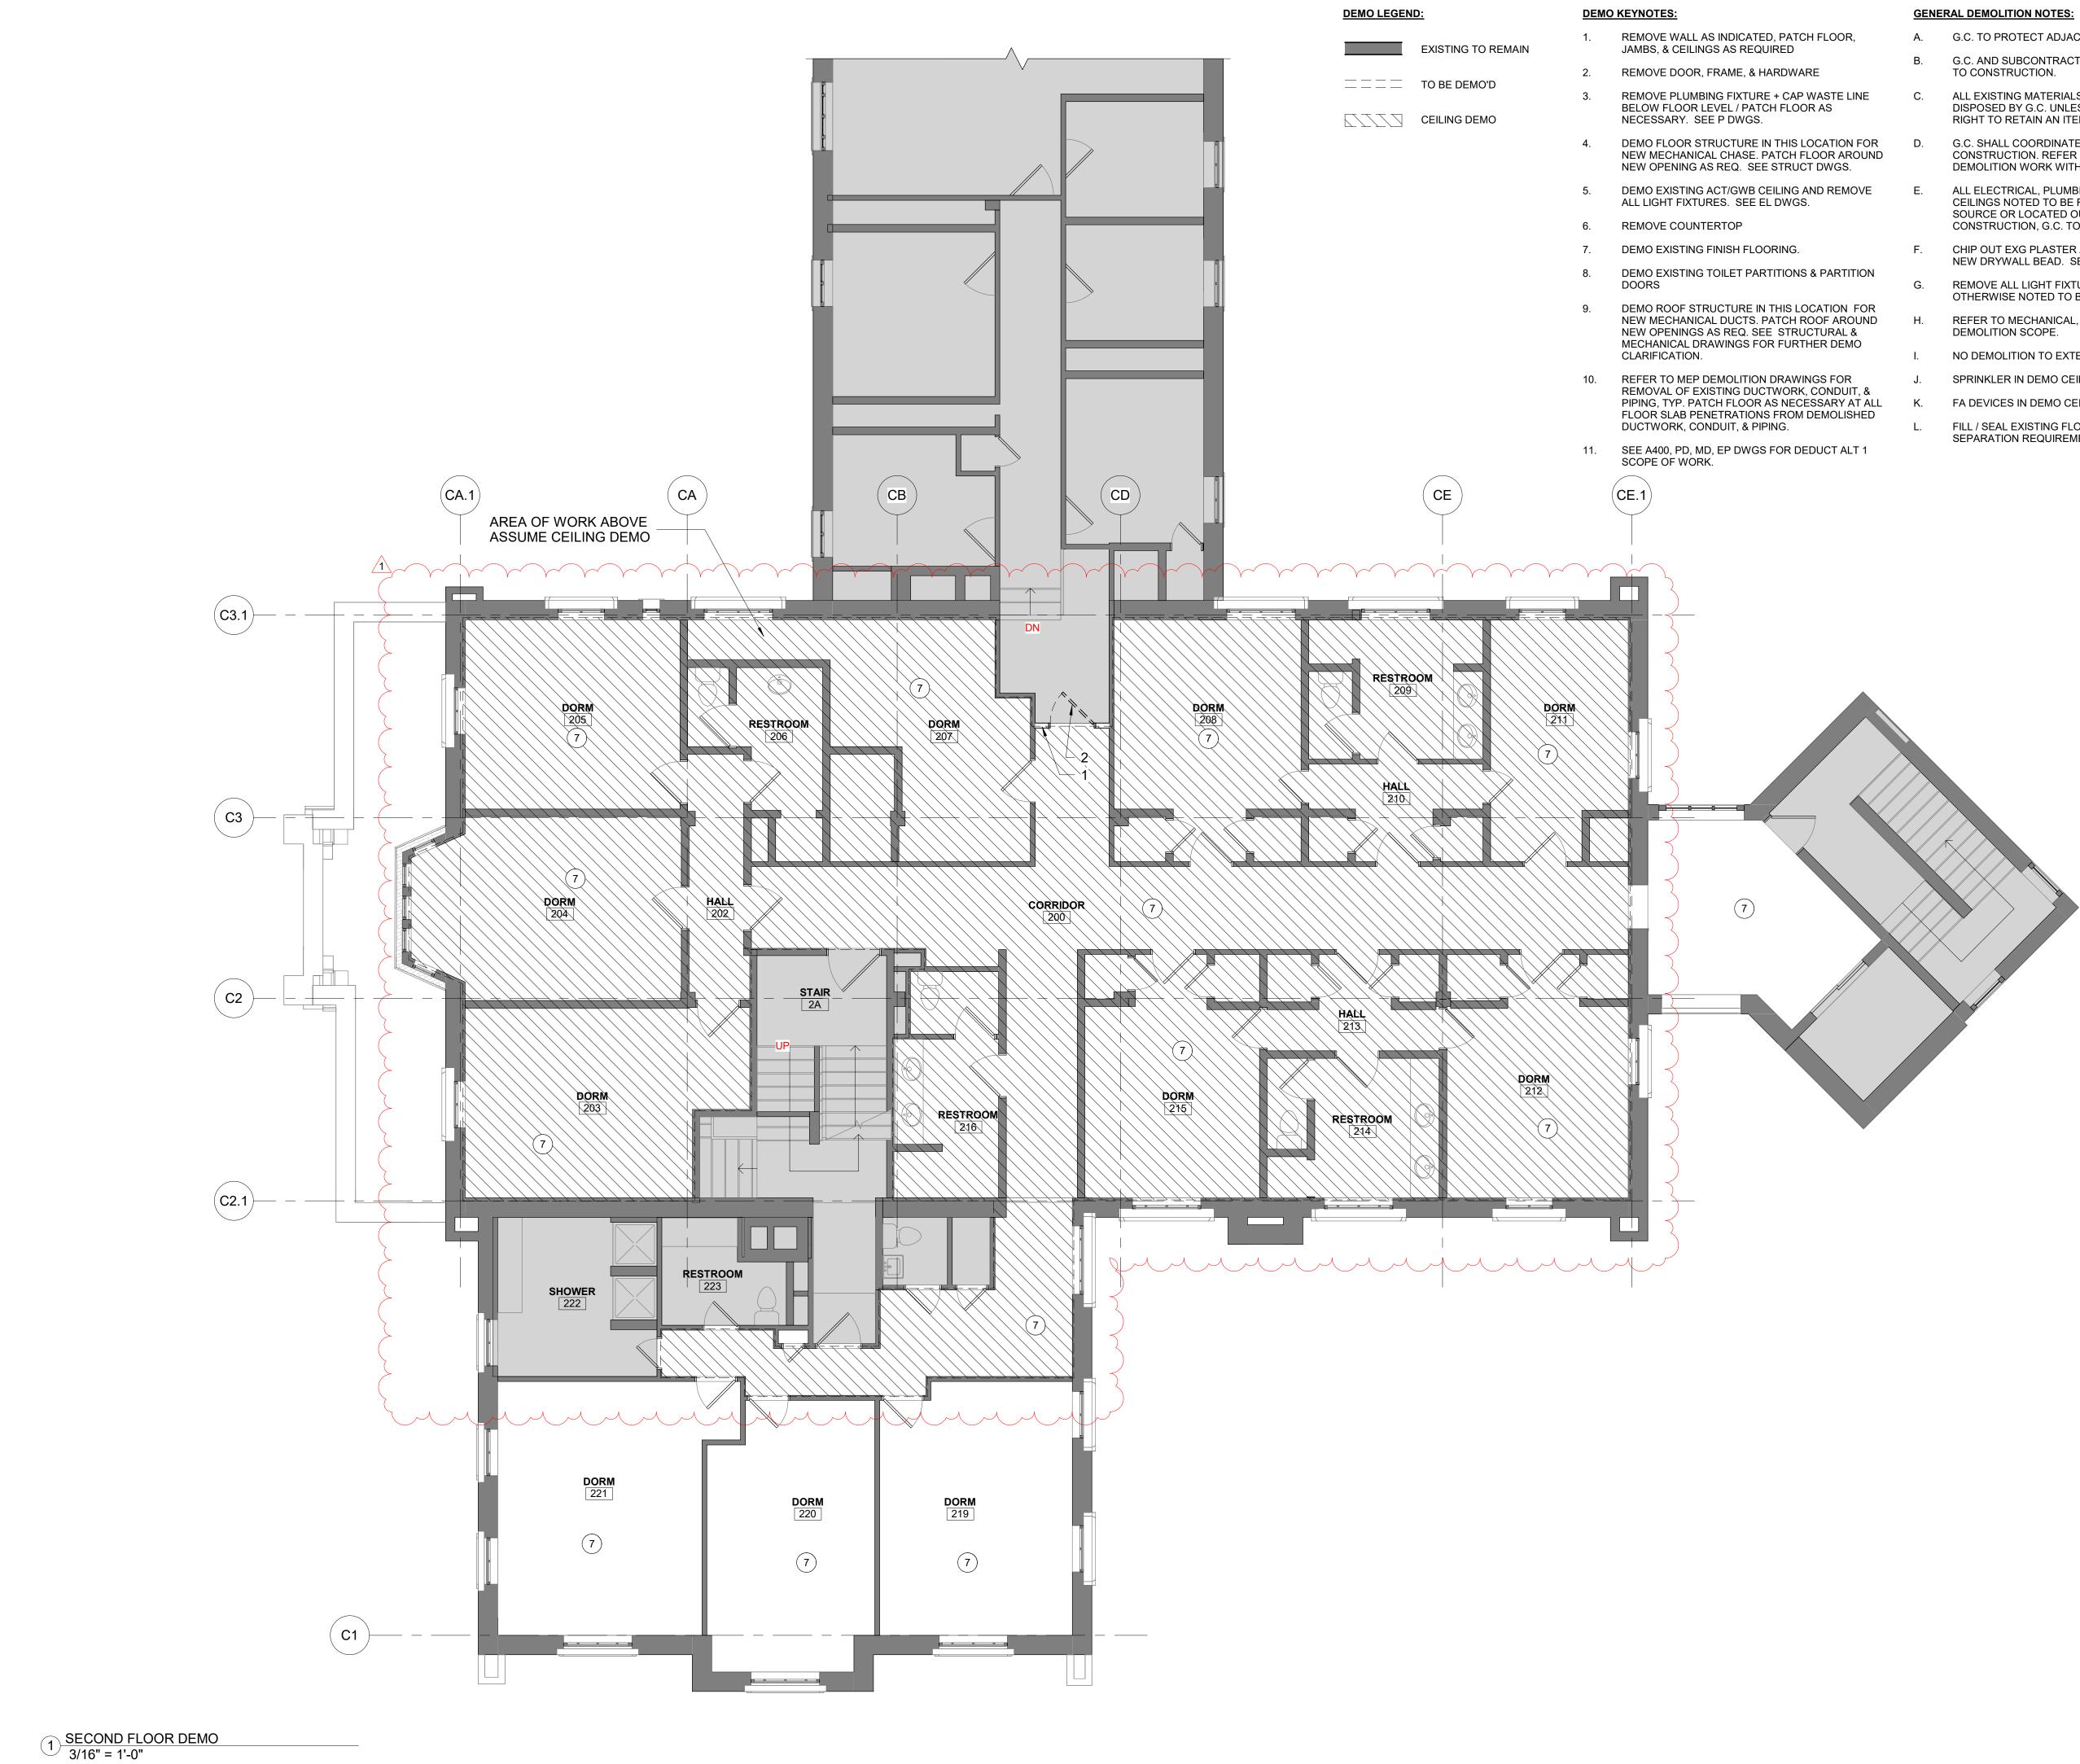

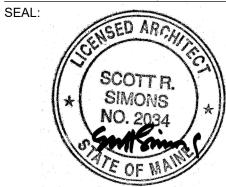

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 REVISIONS

 1

 ADDENDUM 1

04.30.25


DATE OF ISSUE:	APR 16, 2025
PROJECT NUMBER:	2023-0070
STATUS:	PERMIT SET

SECOND FLOOR DEMO PLAN

AD102



DATE OF ISSUE:	APR 16, 20
PROJECT NUMBER:	2023-00
STATUS:	PERMIT S

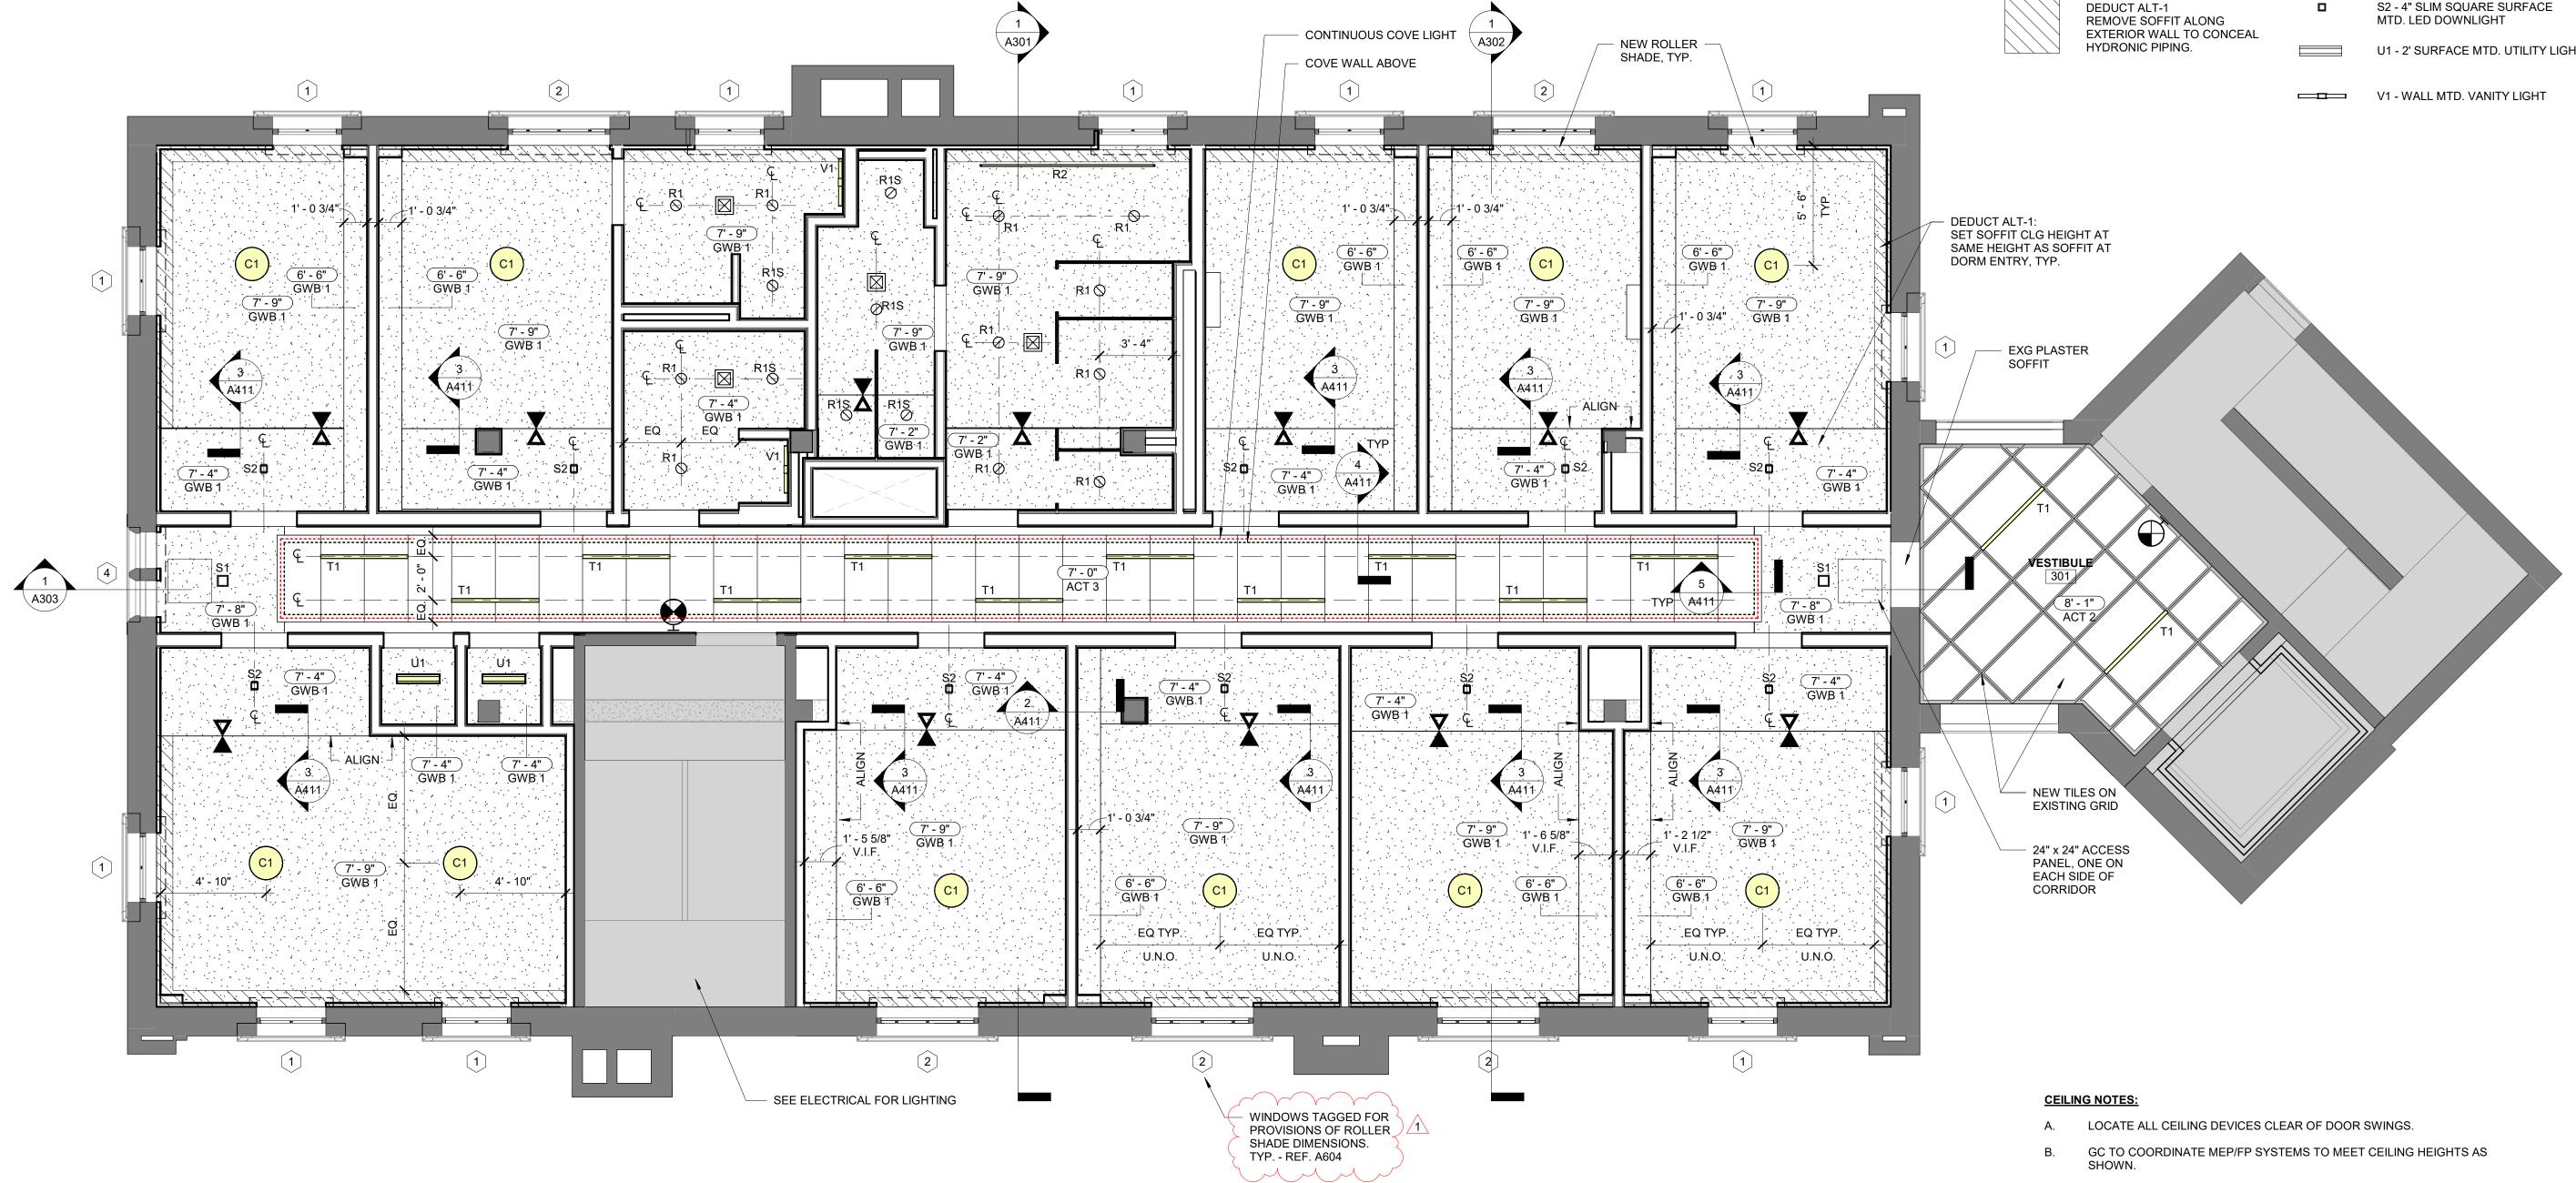

1 <u>THIRD FLOOR RCP</u> 1/4" = 1'-0"

### CEILING LEGEND

### LIGHTING LEGEND

NEW PTD GWB	$\bigcirc$	C1 - CLG/SURFACE MTD. DOWNLIGHT
		T1 - 4' T-BAR. MTD TO ACT GRID
NEW ACT: ACT 1: 2x2 ACT 2: 2x4 ACT 3: 2x6	$\oslash$	R1 - 6" RECESSED LED DOWNLIGHT
REFINISH EX. GWB. CLG. NEW PT.	$\oslash$	R1S - 6" RECESSED LED DOWNLIGHT, SHOWER RATED
		R2 - RECESSED LED STRIP DOWNLIGHT
EXISTING TO REMAIN		S1 - 6" SLIM SQUARE SURFACE MTD. LED DOWNLIGHT
DEDUCT ALT-1 REMOVE SOFFIT ALONG EXTERIOR WALL TO CONCEAL		S2 - 4" SLIM SQUARE SURFACE MTD. LED DOWNLIGHT
HYDRONIC PIPING.		U1 - 2' SURFACE MTD. UTILITY LIGHT
		V1 - WALL MTD. VANITY LIGHT

- ITEMS ARE INTENDED TO BE EQUALLY SPACED ON CENTER WITHIN A C. DEFINED AREA UNO. CONFIRM LOCATIONS IN FIELD W/ ARCHITECT @ ROUGH-IN.
- REFERENCE LIGHT FIXTURE SCHEDULE IN ELECTRICAL SET D.
- ALIGN MECHANICAL SUPPLY/RETURN GRILLS ON CENTER W/ ADJACENT CEILING LIGHT FIXTURES
- F. LIGHT FIXTURES CENTERED UNO

TRUE	$\bigcap$

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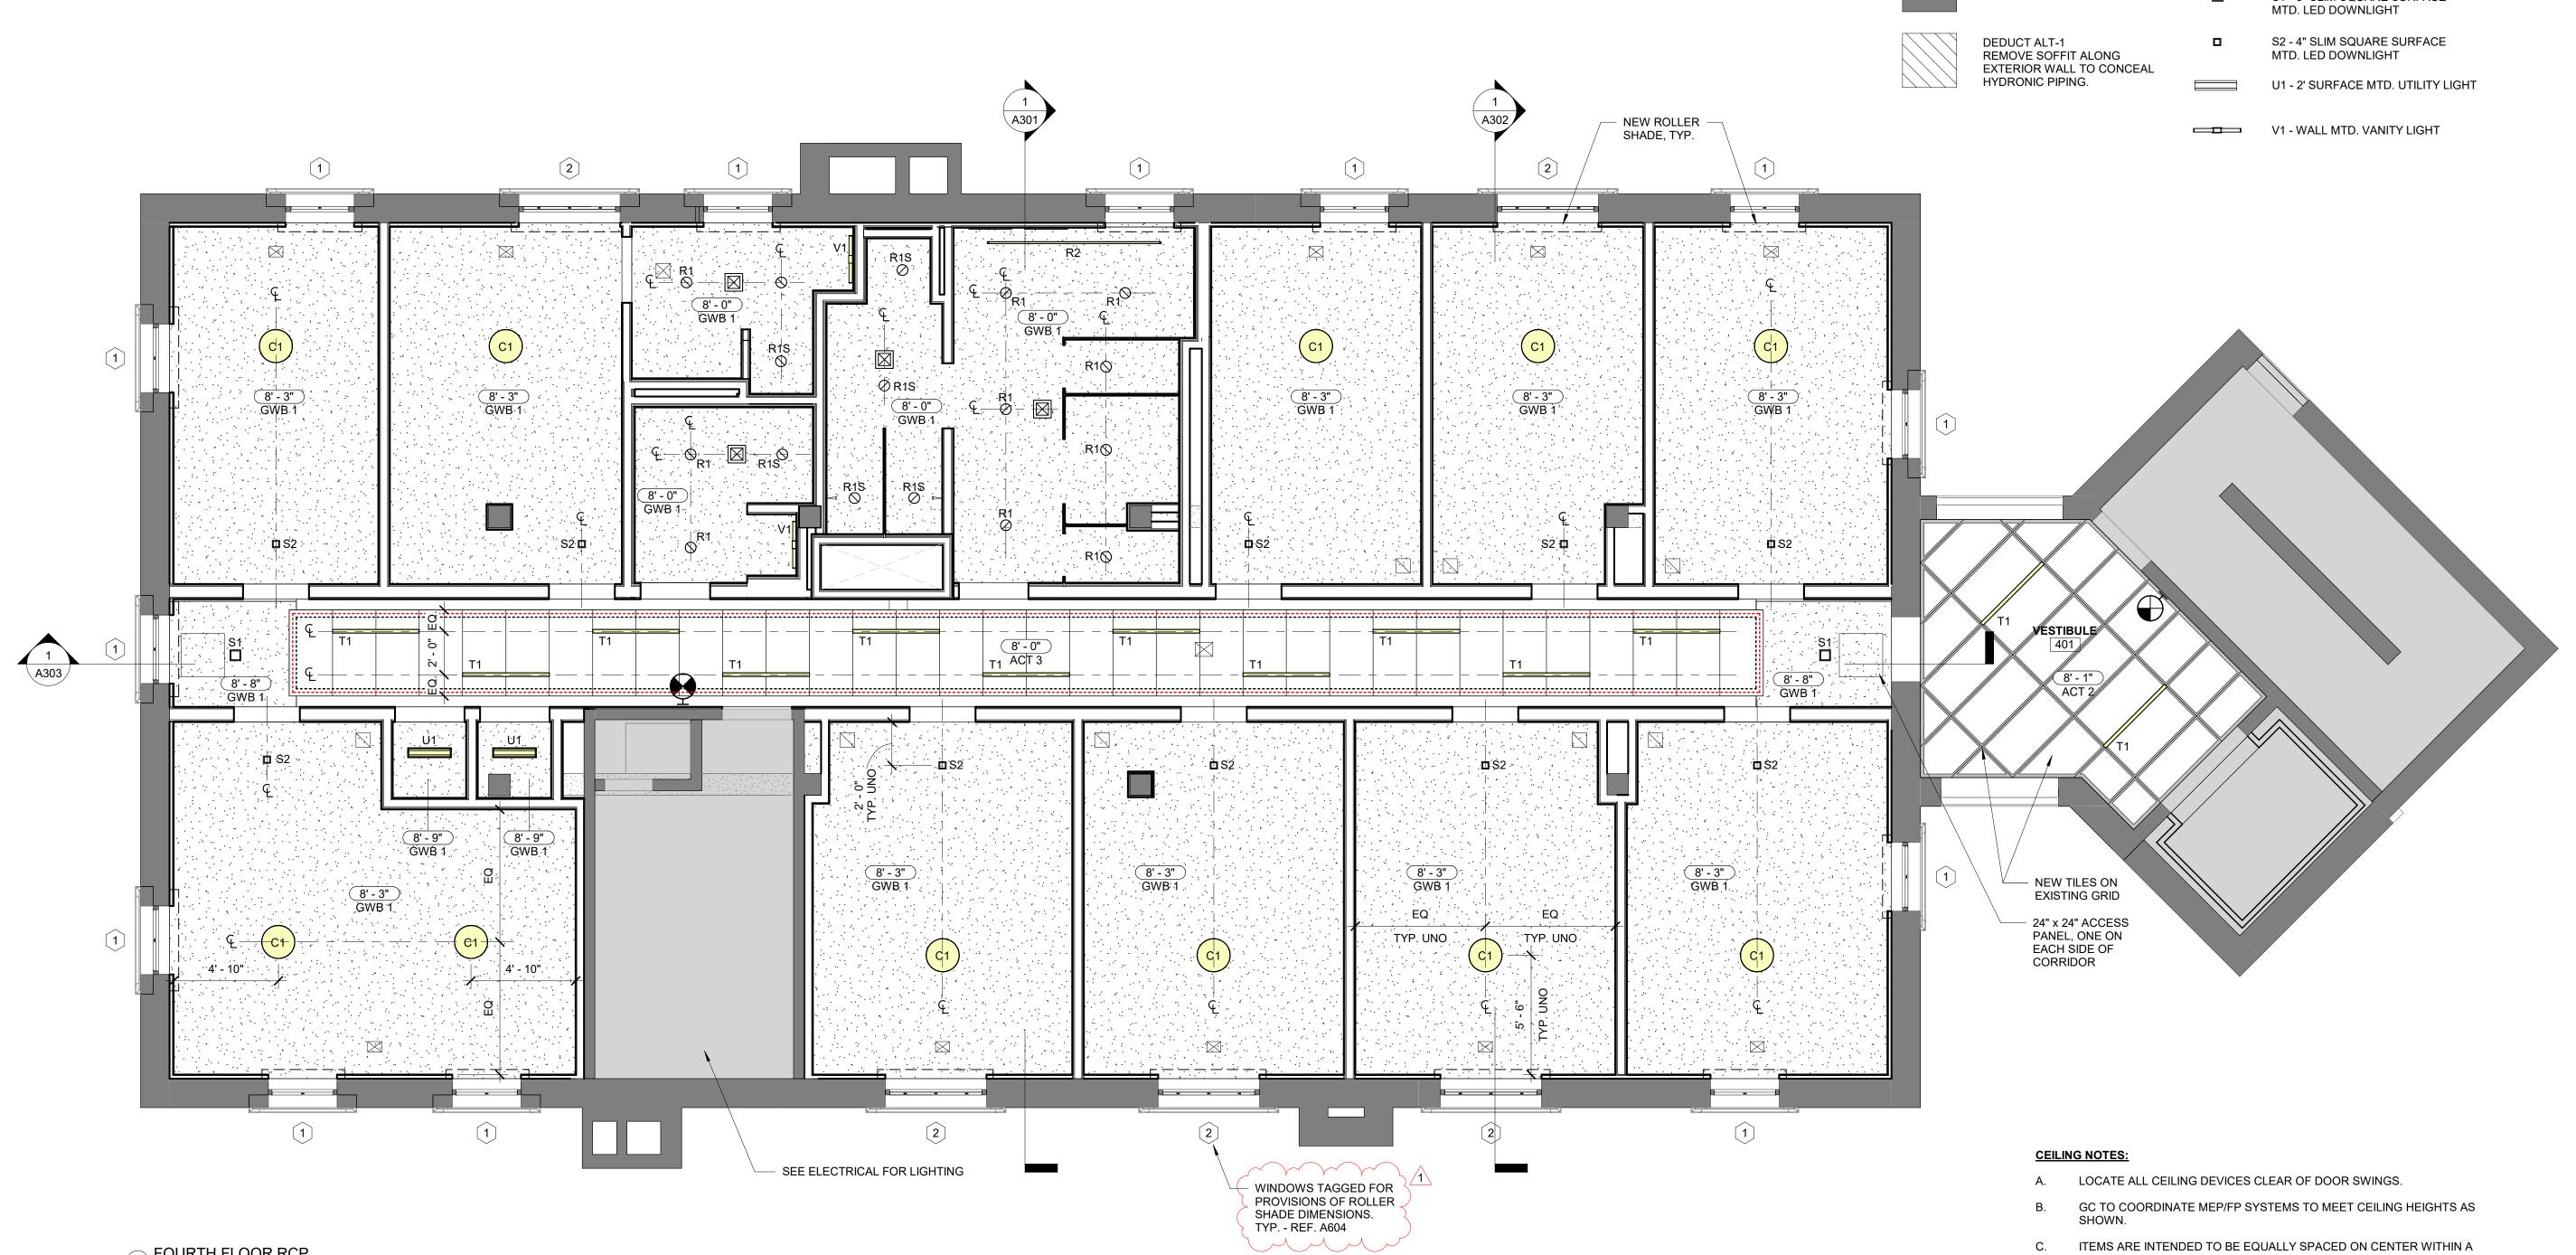
1 ADDENDUM 1

04.30.25

APR 16, 2025 DATE OF ISSUE: 2023-0070 PROJECT NUMBER: STATUS: PERMIT SET

### THIRD FLOOR RCP

A133



1 FOURTH FLOOR RCP 1/4" = 1'-0"

### LIGHTING LEGEND

NEW PTD GWB	$\bigcirc$	C1 - CLG/SURFACE MTD. DOWNLIGHT
NEW ACT:		T1 - 4' T-BAR. MTD TO ACT GRID
ACT 1: 2x2 ACT 2: 2x4 ACT 3: 2x6	$\oslash$	R1 - 6" RECESSED LED DOWNLIGHT
REFINISH EX. GWB. CLG. NEW PT.	$\oslash$	R1S - 6" RECESSED LED DOWNLIGHT, SHOWER RATED
		R2 - RECESSED LED STRIP DOWNLIGHT
EXISTING TO REMAIN		S1 - 6" SLIM SQUARE SURFACE MTD. LED DOWNLIGHT
DEDUCT ALT-1 REMOVE SOFFIT ALONG		S2 - 4" SLIM SQUARE SURFACE MTD. LED DOWNLIGHT
EXTERIOR WALL TO CONCEAL HYDRONIC PIPING.		U1 - 2' SURFACE MTD. UTILITY LIGHT



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- ITEMS ARE INTENDED TO BE EQUALLY SPACED ON CENTER WITHIN A DEFINED AREA UNO. CONFIRM LOCATIONS IN FIELD W/ ARCHITECT @ ROUGH-IN.
- D. REFERENCE LIGHT FIXTURE SCHEDULE IN ELECTRICAL SET
- ALIGN MECHANICAL SUPPLY/RETURN GRILLS ON CENTER W/ ADJACENT CEILING LIGHT FIXTURES
- F. LIGHT FIXTURES CENTERED UNO



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$\triangle$	REVISIONS
1	ADDENDUM 1

04.30.25

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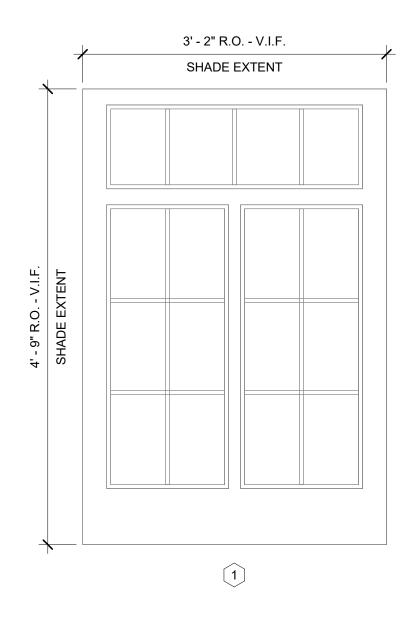
## FOURTH FLOOR RCP


A134


	WINDOW S	CHEDULE	
Window		Siz	e (W x H)
Туре	Description	Width	Height
1	3-2 x 4-9	3' - 2"	4' - 9"
2	4-8 x 4-9	4' - 8"	4' - 9"
3	1-2 x 3-8	1' - 2"	3' - 8"
4	1-8 x 4-4	1' - 8"	4' - 4"
5	1-7 x 4-5	1' - 7"	4' - 5"


EXISTING WINDOW NOTES:


WINDOWS PORTRAYED ARE EXISTING. THERE ARE NO NEW WINDOWS IN PROJECT.
 WINDOW SCHEDULE AND WINDOW ELEVATIONS ARE FOR REFERENCE ONLY.
 G.C. TO VERIFY ALL EXISTING WINDOW WIDTH'S & HEIGHT'S IN FIELD.
 TAGGED EXISTING WINDOWS ON FLOORS 2, 3, & 4 TO RECIEVE NEW ROLLER SHADES.



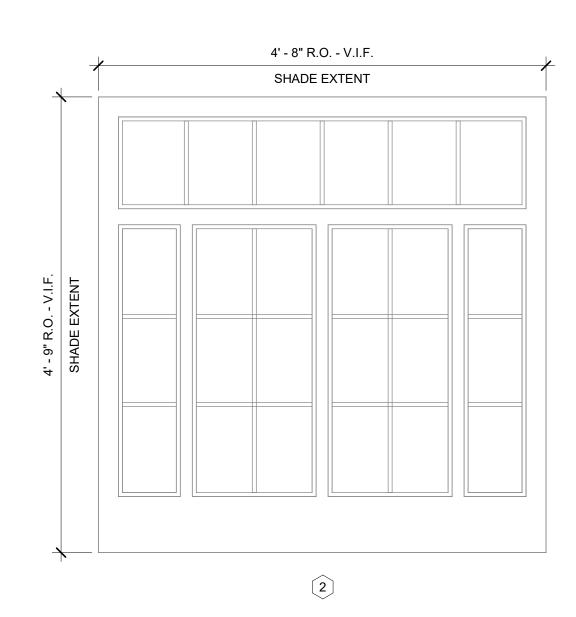


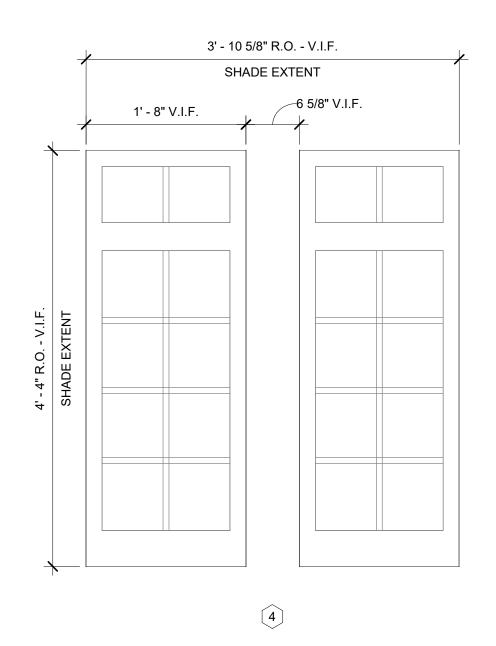

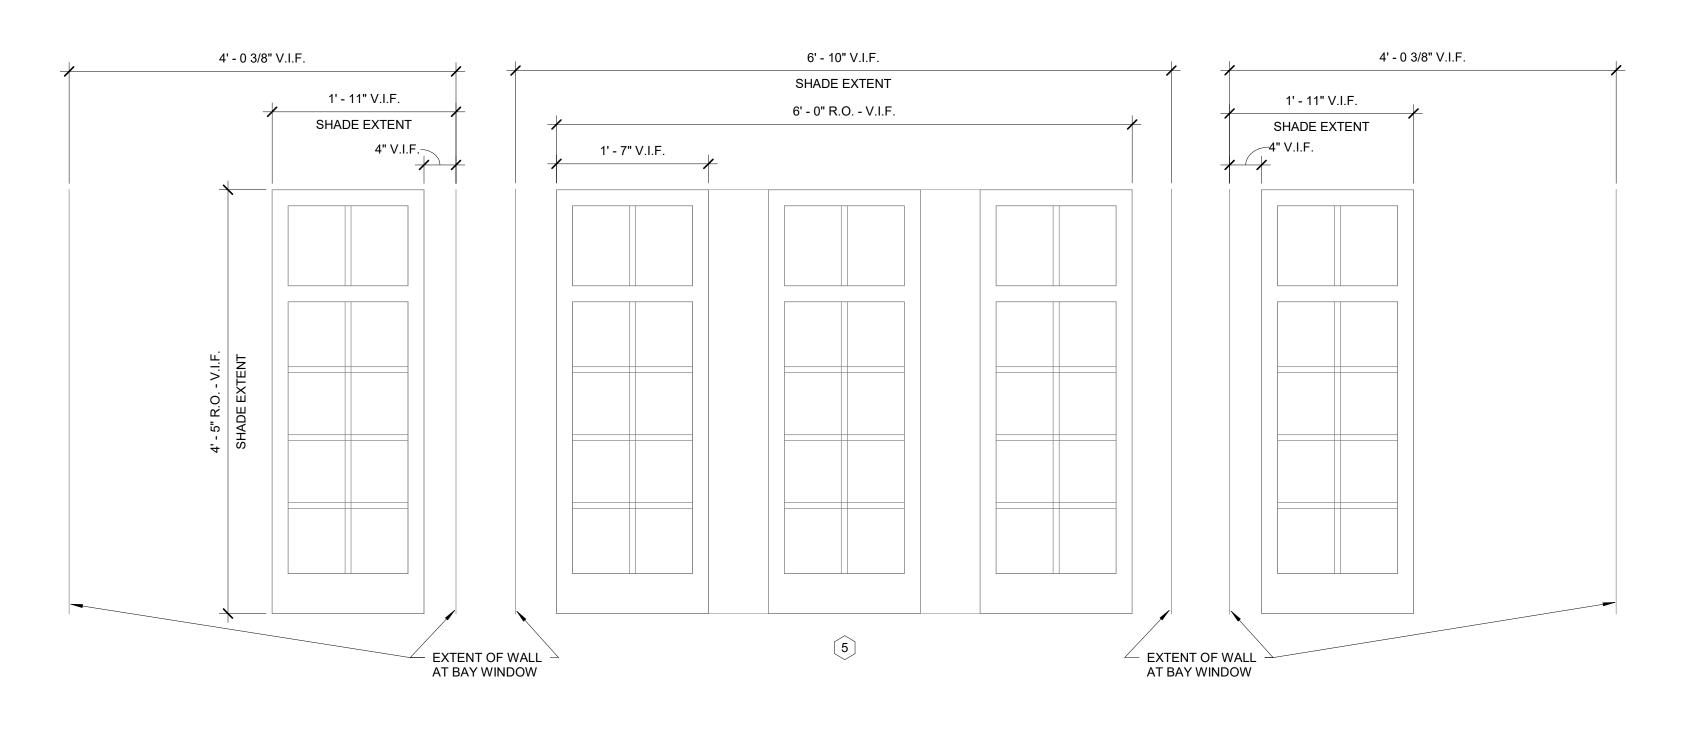

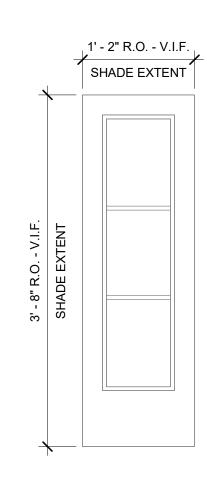

3

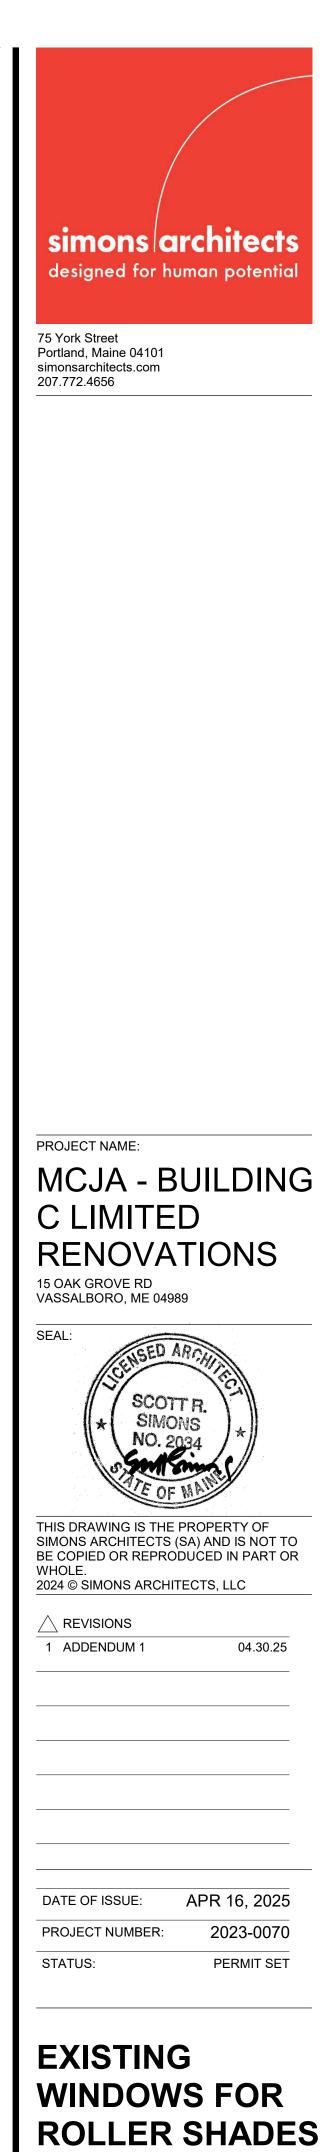

A604

