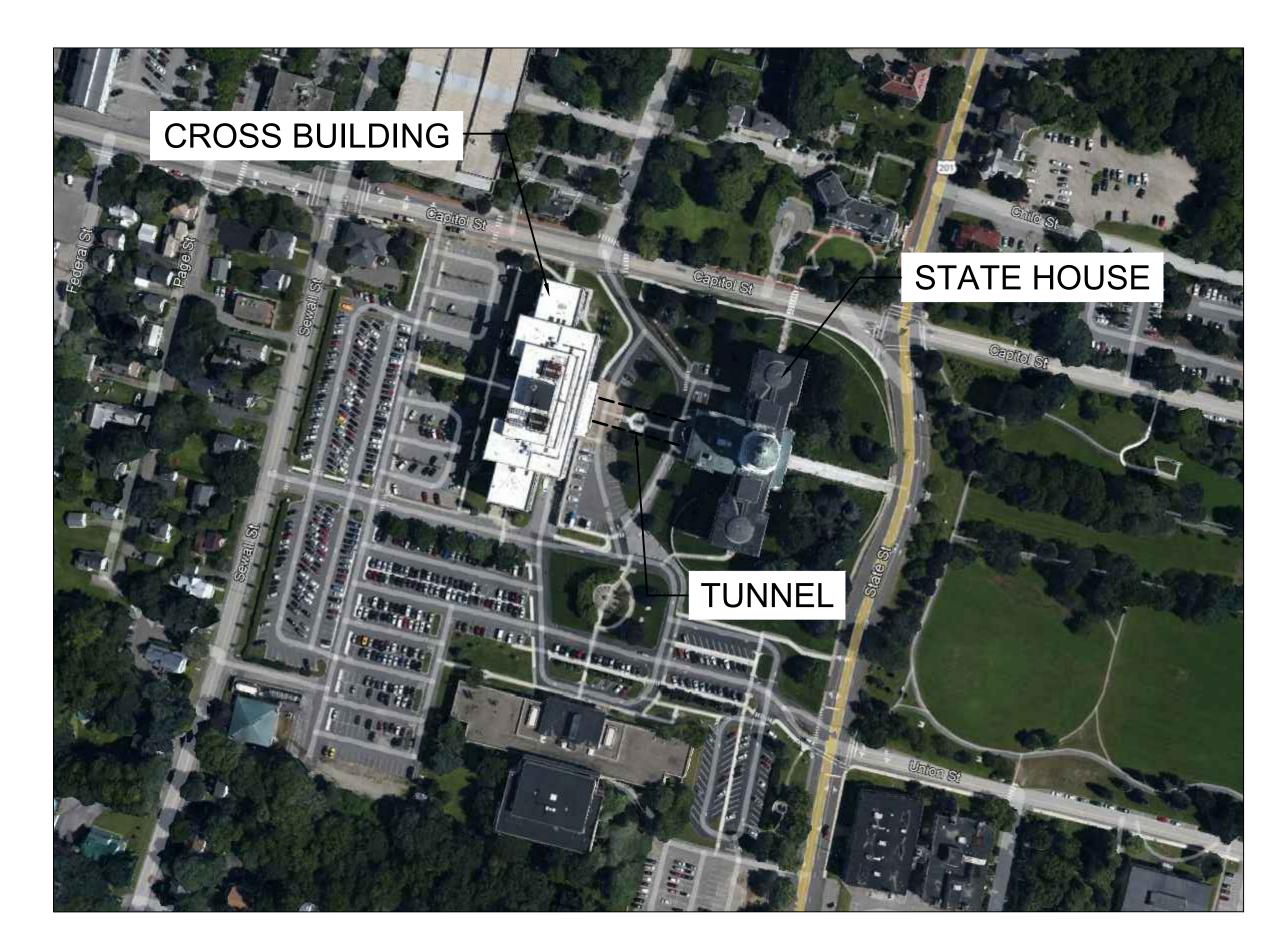
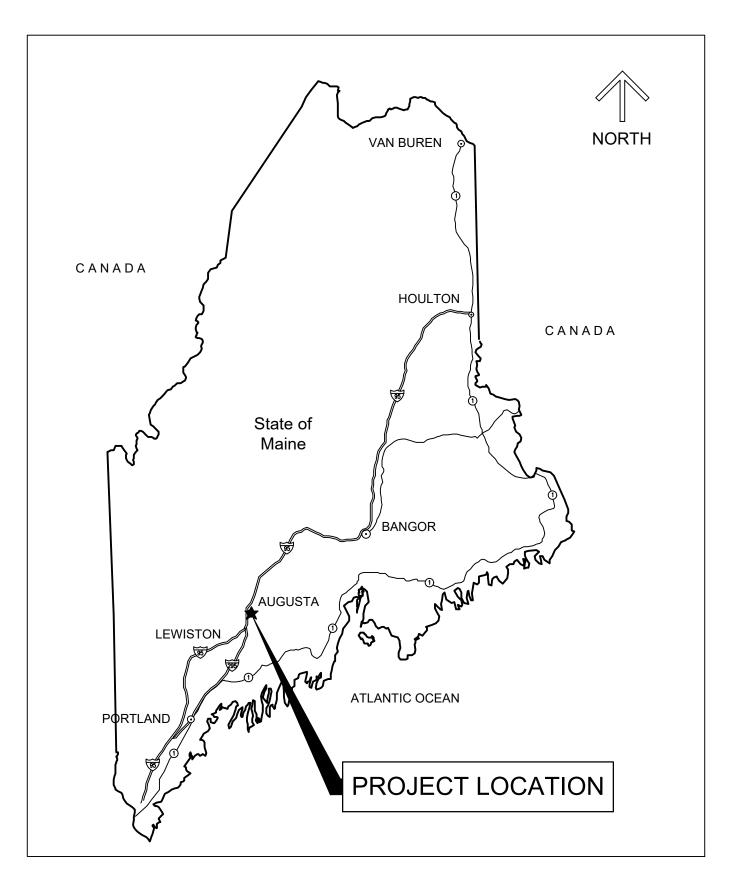
MAINE STATE HOUSE SPRINKLER LEAK CORRECTION

STATE OF MAINE BUREAU OF GENERAL SERVICES AUGUSTA, MAINE



AREA MAP



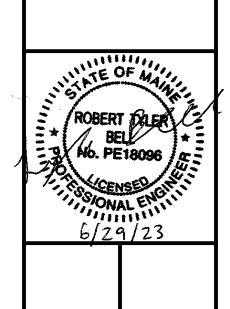
VICINITY MAP

DRAWING INDEX		
SHEET ID	SHEET TITLE	
GENERAL		
G-001	COVER SHEET	
STRUCTURAL		
S-101	LOWER LEVEL SUPPORT FRAMING PLAN, SECTIONS & DETAILS	
ARCHITECTURAL		
AD101	REFLECTED CEILING DEMOLITION PLAN	
A-101	REFLECTED CEILING PLAN	
A-102	PHOTOGRAPHS	
FIRE PROTECTION		
F-001	FIRE PROTECTION LEGEND, ABBREVIATIONS AND GENERAL NOTES	
FD101	FIRE PROTECTION DEMOLITION PLAN	
FP101	FIRE PROTECTION FLOOR PLAN	



STATE OF MAINE
BUREAU OF GENERAL SERVICES
111 SEWALL STREET, 4TH FLOOR
AUGUSTA, MAINE 04333-0077
(207) 624-7314





ISSUED FOR BID
JUNE 29, 2023
MAINE STATE HOUSE SPRINKLE
LEAK CORRECTION

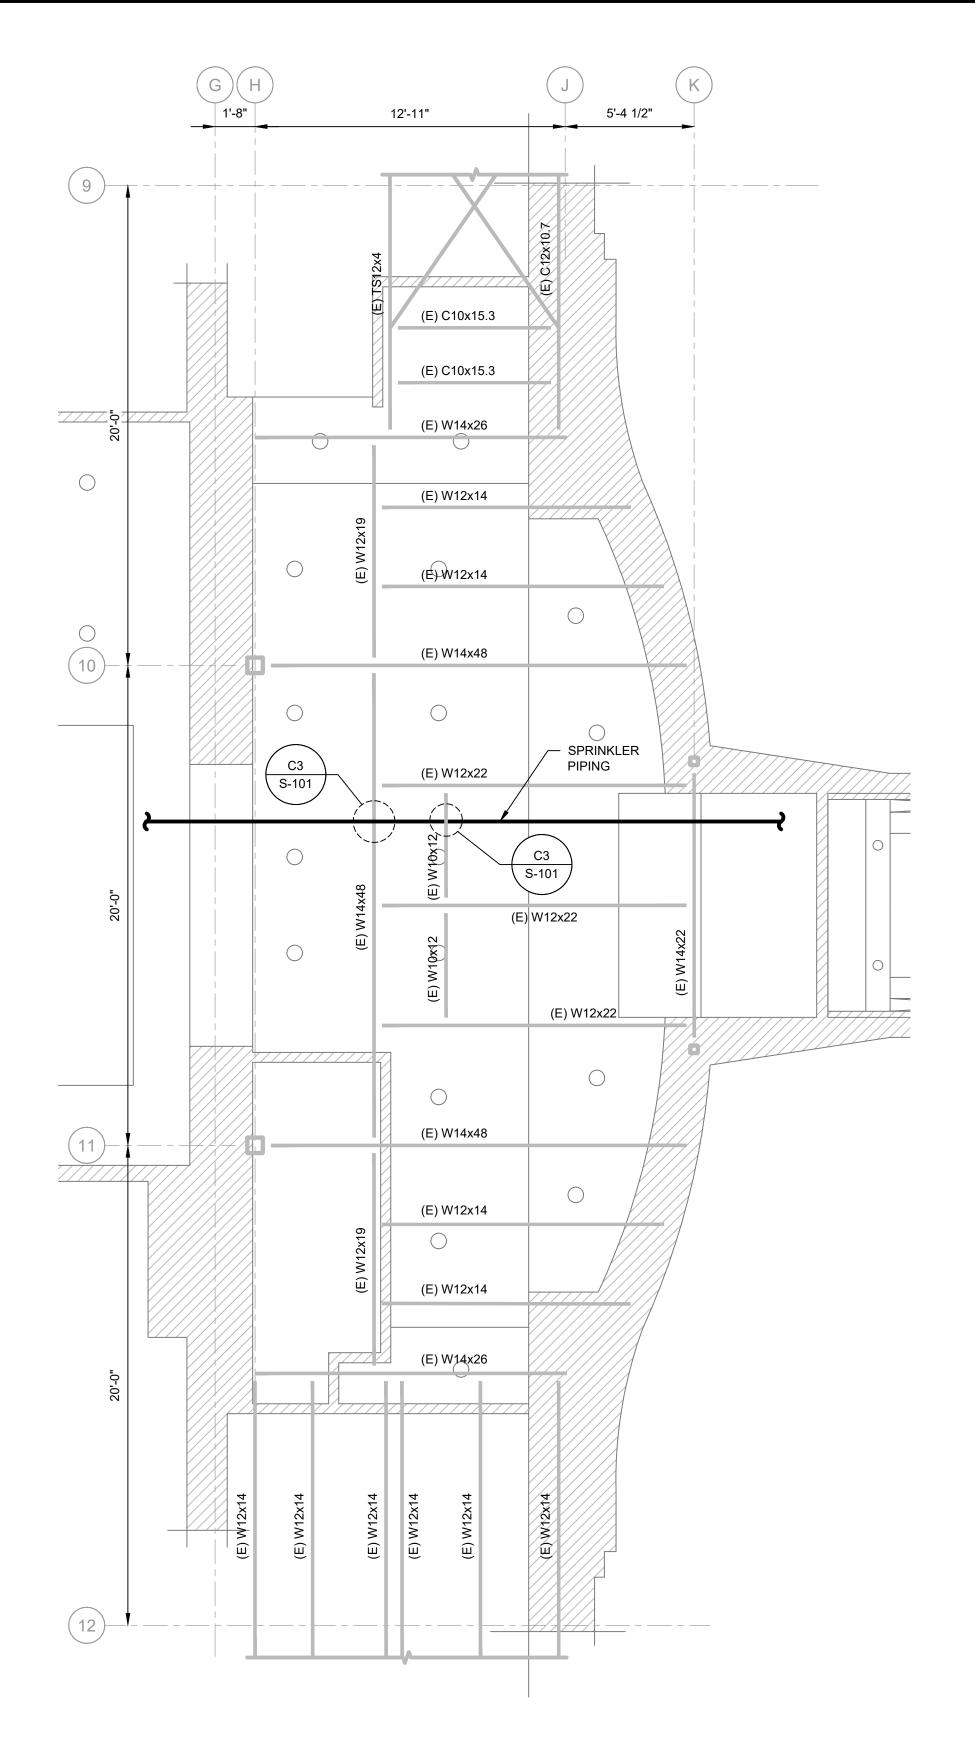
PROJECT:
ISSUED FOR BID

06-29-2023

ROJECT NO: 3529230
ROJECT MANAGER:
/E OF RECORD:
ESIGNED BY: S
RAWN BY: S

COVER SHEET

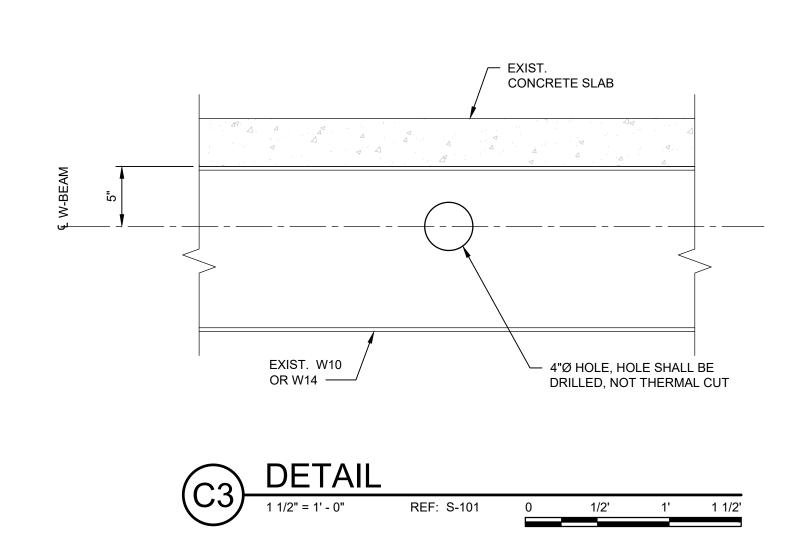
G-001



C1 LOWER LEVEL FLOOR SUPPORT FRAMING PLAN

1/4" = 1' - 0" REF: S-101

0 2' 4' 8'



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(207) 624-7314



JEFFREY R. WALKER NO. 11028

ISSUED FOR BID
JUNE 29, 2023

THE MAINE STATE HOUSE SPRINKLER

PROJECT NO: 352923
PROJECT MANAGER:
VE OF RECORD:
PESIGNED BY:

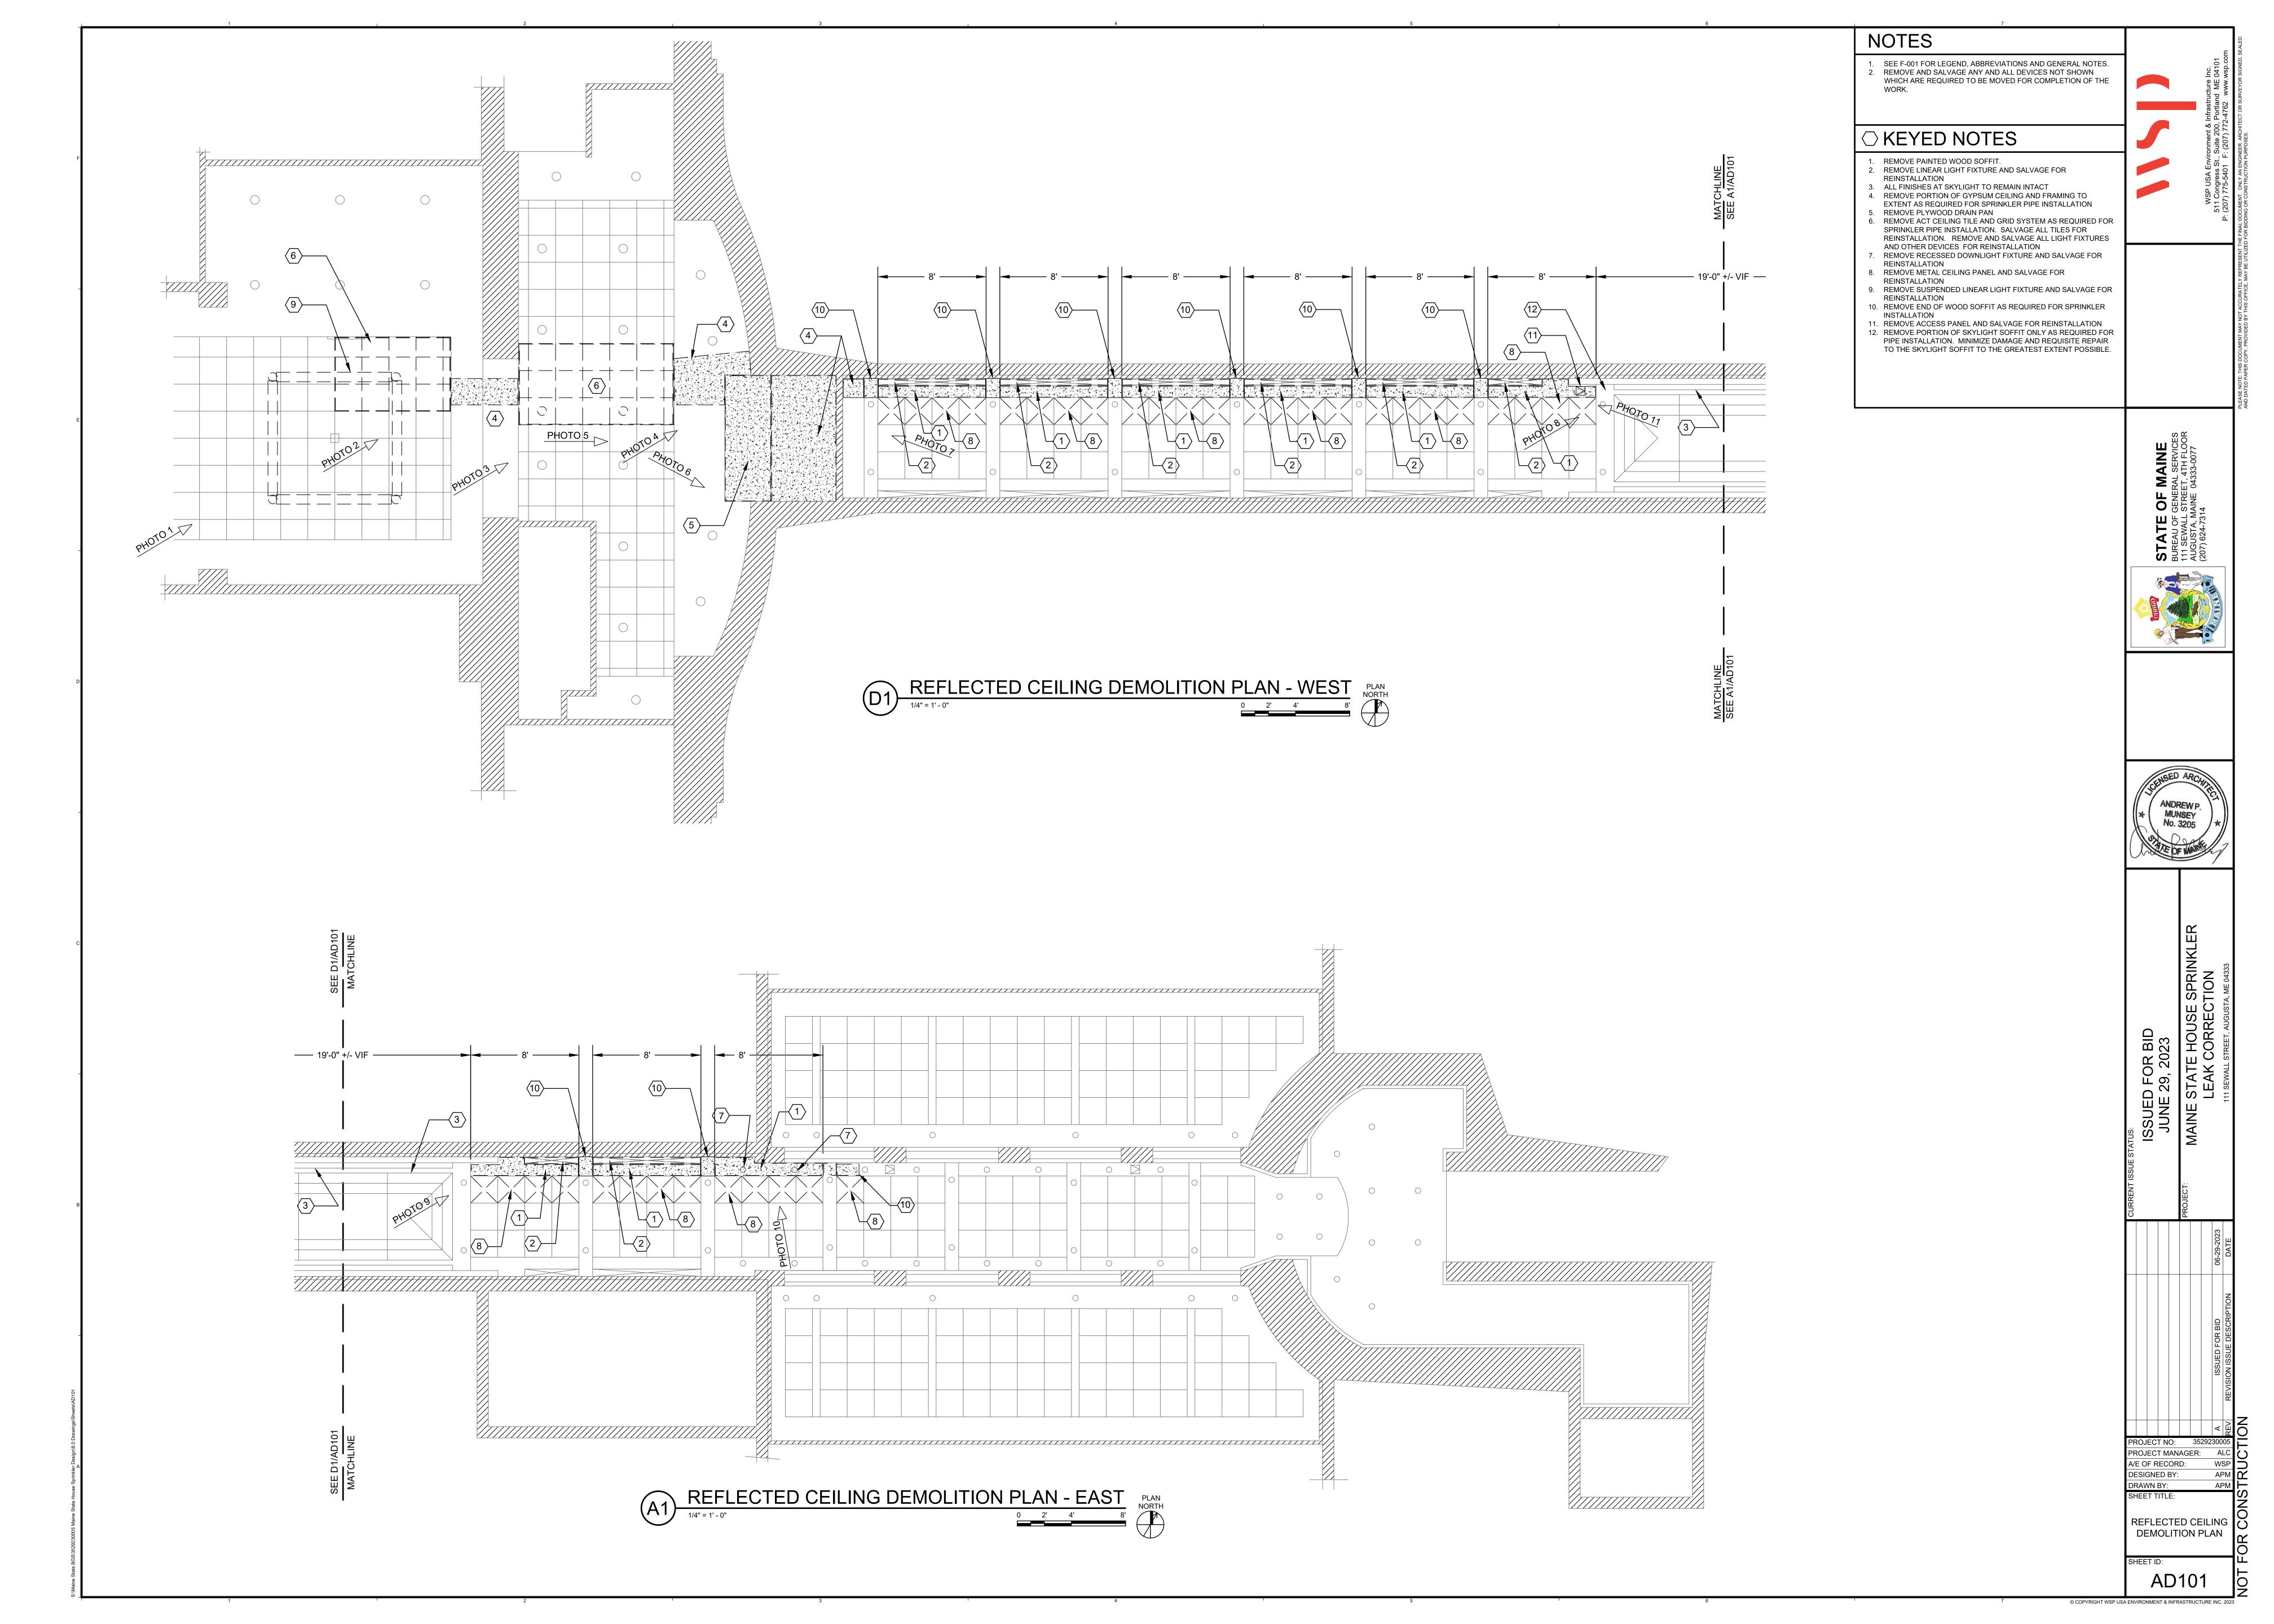
PROJECT NO: 3529230005
PROJECT MANAGER: ALC
A/E OF RECORD: JRW
DESIGNED BY: JRW
DRAWN BY: DGP
SHEET TITLE:

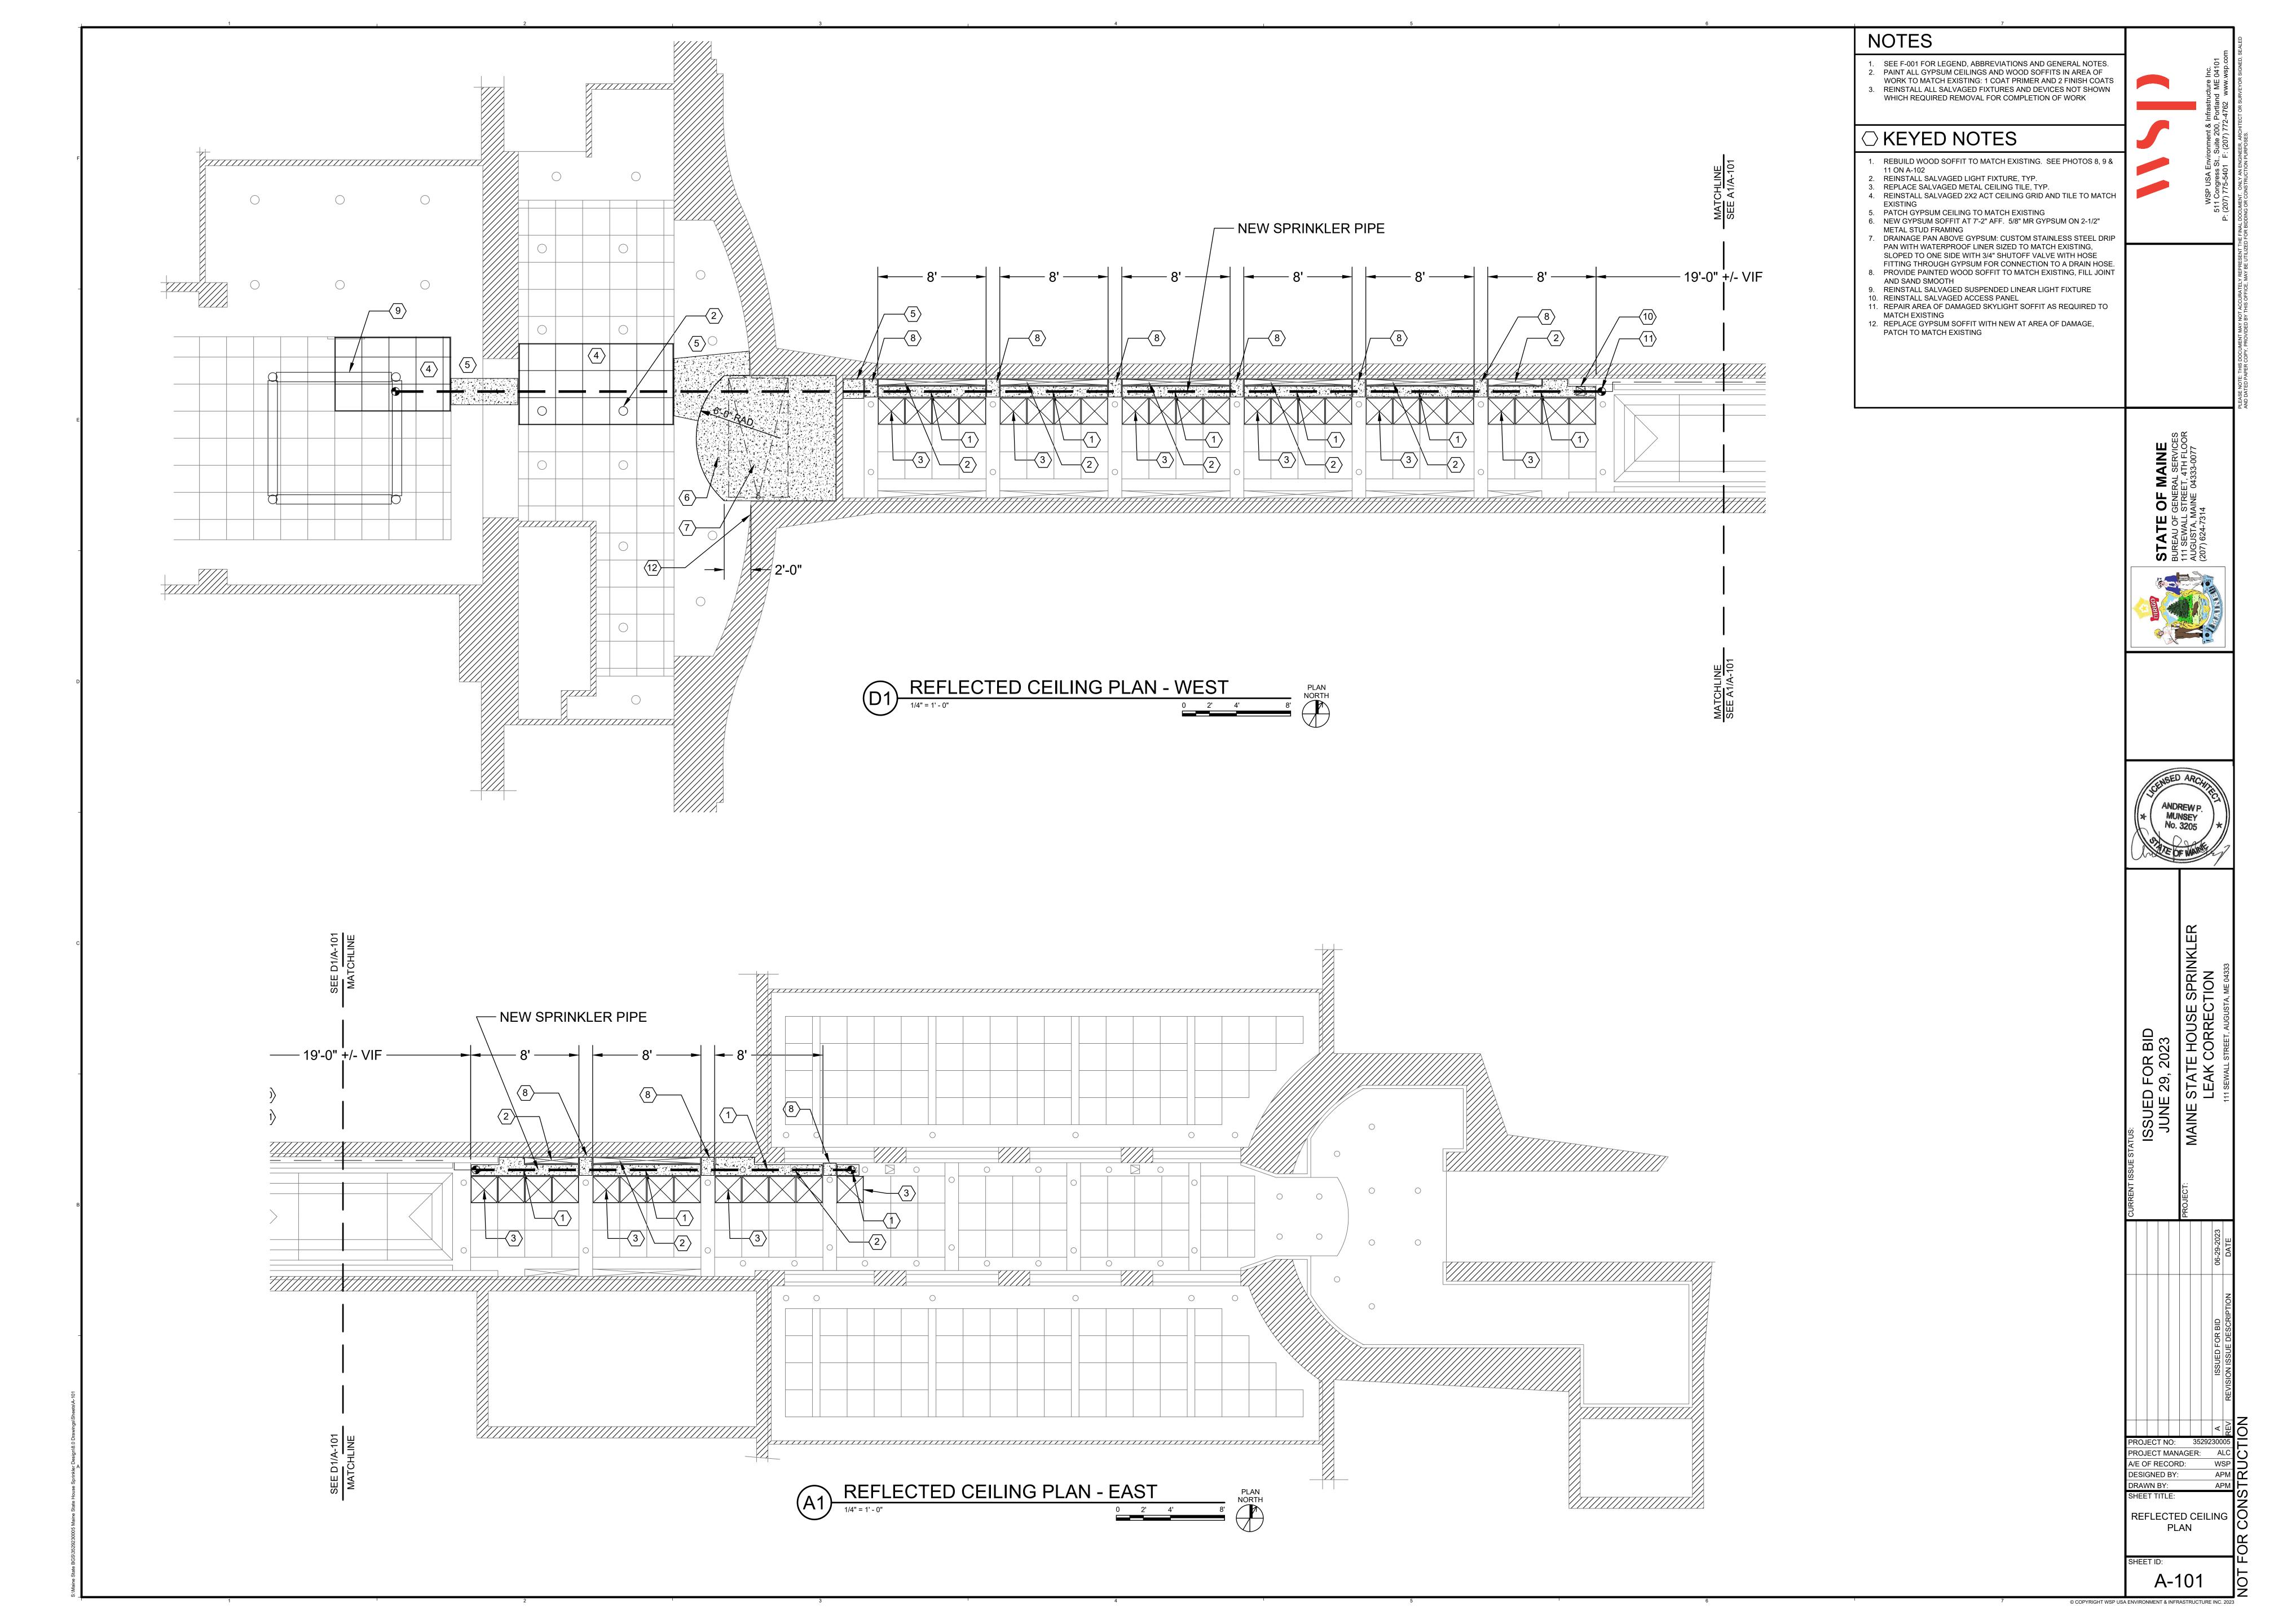
LOWER LEVEL
SUPPORT FRAMING
PLAN, SECTIONS &
DETAILS

SHEET ID:

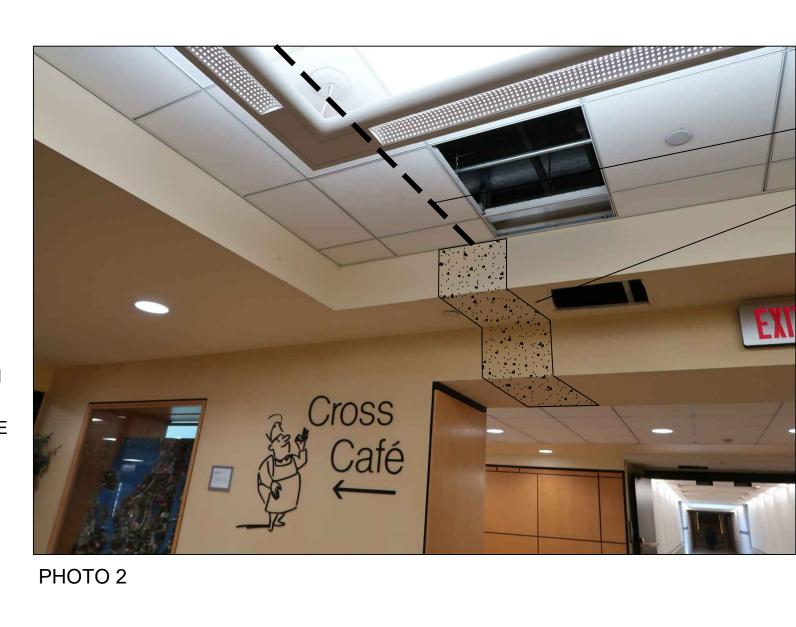
S-101

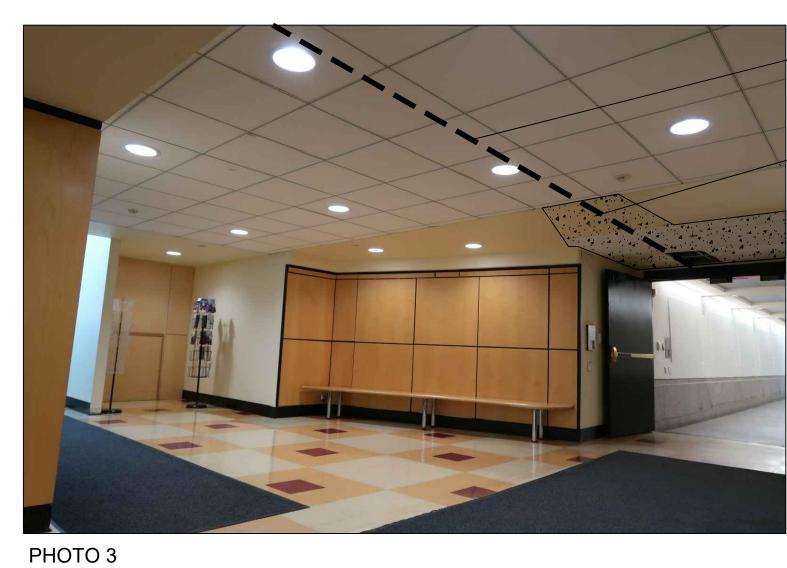
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GYPSUM CEILING TO BE REMOVED AND REPLACED

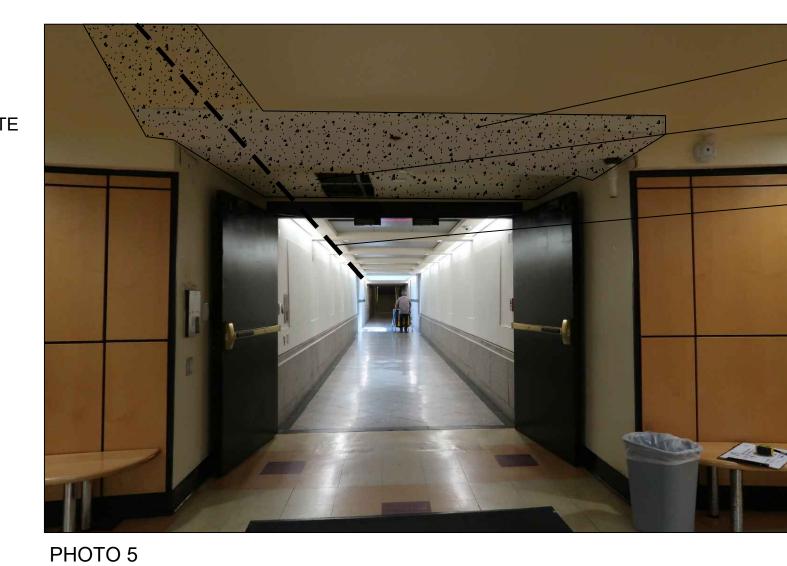


PHOTO 6

DRAIN PAN TO BE REMOVED EXISTING DRAIN TO BE REMOVED. SEE A-101 FOR NEW WORK -REPLACE GYPSUM SOFFIT WITH NEW AT AREA OF DAMAGE, PATCH TO MATCH **EXISTING**

EXISTING PLYWOOD

NEW SPRINKLER PIPE ROUTE

PHOTO 8

REMOVE WOOD SOFFIT AND REPLACE WITH NEW TO MATCH EXISTING AFTER PIPE INSTALLATION -CONNECT TO EXISTING SPRINKLER LINE REMOVE AND SALVAGE ACCESS PANEL FOR REINSTALLATION

-NEW SPRINKLER PIPE ROUTE

EXISTING PLYWOOD

-NEW SPRINKLER PIPE ROUTE

DRAIN PAN TO BE

-GYPSUM SOFFIT TO

BE REMOVED AND

REMOVED

REPLACED

✓GYPSUM SOFFIT TO

BE REMOVED AND

REPLACED



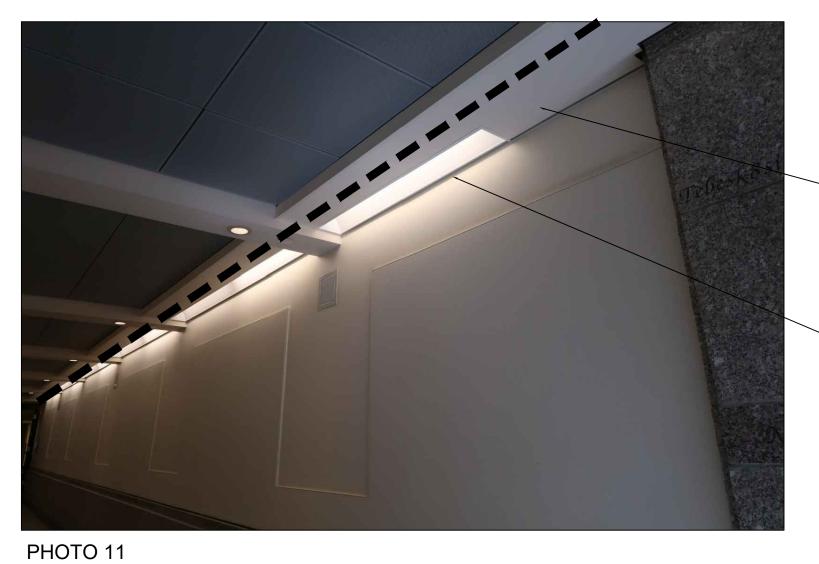
REMOVE WOOD SOFFIT AND REPLACE WITH NEW TO MATCH EXISTING AFTER PIPE INSTALLATION LIGHT FIXTURES TO BE REMOVED FOR PIPE INSTALLATION AND REINSTALLED

CUT WOOD SOFFIT FOR PIPE INSTALLATION, REPLACE WITH WOOD TO MATCH, PATCH JOINT AND SAND SMOOTH

-NEW SPRINKLER PIPE ROUTE

-REMOVE AND SALVAGE LIGHT FIXTURES FOR REINSTALLATION AFTER SPRINKLER PIPE WORK NEW SPRINKLER PIPE ROUTE

REMOVE WOOD SOFFIT AND REPLACE WITH NEW TO MATCH EXISITNG AFTER PIPE INSTALLATION



REMOVE WOOD SOFFIT AND REPLACE WITH NEW TO MATCH EXISITNG AFTER PIPE INSTALLATION

~REMOVE AND SALVAGE LIGHT FIXTURES FOR REINSTALLATION AFTER SPRINKLER PIPE WORK

A/E OF RECORD: DESIGNED BY: RAWN BY:

MUNSEY No. 3205

PHOTO 10

PHOTOGRAPHS

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ABBREVIATIONS FACTORY MUTUAL GLOBAL ABOVE FINISHED FLOOR ABOVE FINISHED GRADE FMCP FIRE ALARM MASS NOTIFICATION CONTROL PANEL AUTHORITY HAVING JURISDICTION FS SPRINKLER SYSTEM FLOW SWITCH BELOW FINISHED GRADE FURNISHED WITH EQUIPMENT BLDG GREATER AUGUSTA UTILITY DISTRICT BUILDING CLG GALLONS PER MINUTE CEILING GPM CONNECT TO EXISTING HYDRANT CTE DEMOLISHED (TO BE REMOVED) MAINE WATER COMPANY NORMALLY CLOSED NATIONAL FIRE PROTECTION ASSOCIATION DEPARTMENT OF PUBLIC WORKS NFPA EXISTING TO REMAIN NOT IN CONTRACT ELEVATION NORMALLY OPEN **EQUIPMENT** NOT TO SCALE **EXIST EXISTING** OUTSIDE SCREW AND YOKE VALVE OS&Y FIRE ALARM ANNUNCIATOR POUNDS PER SQUARE INCH PSI FACP FIRE ALARM CONTROL PANEL PVC POLYVINYL CHLORIDE **FAMNS** FIRE ALARM MASS NOTIFICATION SYSTEM QUICK RESPONSE FURNISHED BY OTHERS SQUARE FEET FDC FIRE DEPARTMENT CONNECTION VALVE WITH TAMPER SWITCH FLR FLOOR TYP TYPICAL FINISHED FLOOR UNDERWRITERS LABORATORIES GENERAL SYMBOLS DETAIL NUMBER KEYED NOTE - DRAWING NUMBER (WHERE DETAIL IS DRAWN) DEMOLITION KEYED NOTE REVISION NOTE — EQUIPMENT ABBREVIATION (REFER TO ABBREVIATIONS LIST) EQUIPMENT SEQUENCE NUMBER GPM (GALLONS PER MINUTE) (REFER TO SCHEDULES) LIMIT OF DEMOLITION CONNECT TO EXISTING NON SPRINKLERED SPACE LINETYPES PIPING AND/OR SPRINKLERS TO BE PROVIDED

SYMBOL	<u>ABBREVIATION</u>	DESCRIPTION
UP/DOWN	UP/DN	PIERCES FLOOR
RISE/DROP		RISE/DROP WITHIN STORY HEIGHT
		PIPE RISE
		PIPE TEE FROM BOTTOM
		PIPE TEE FROM TOP
_		PIPE ELBOW OFFSET
		PIPE END CAP
<u></u>		PIPE BREAK
—		DIRECTION OF FLOW
		PIPE SLOPE DIRECTION
——⊚——		DRY PIPE SPRINKLER RISER - AUTO ACTUATED
<u> </u>		WET PIPE SPRINKLER RISER - AUTO ACTUATED
— M		METER
<u> </u>		CHECK VALVE
		ALARM CHECK VALVE
		BUTTERFLY VALVE
— ↓ —		WALL POST INDICATOR VALVE
\		POST INDICATOR VALVE
	O.S.& Y.	OUTSIDE SCREW AND YOKE VALVE
NC NC	N.C. O.S.& Y.	OUTSIDE SCREW AND YOKE (NORMALLY CLOSED)
TS	TS	OS&Y VALVE WITH TAMPER SWITCH
		DOUBLE CHECK BACKFLOW PREVENTION ASSEME
		RPZ BACKFLOW PREVENTION ASSEMBLY
		RPZ DETECTOR ASSEMBLY
		STORZ FIRE DEPARTMENT CONNECTION
~		SIAMESE FIRE DEPARTMENT CONNECTION
- *		BACKFLOW PREVENTER FLOW TEST CONNECTION (SYMBOLIC ONLY. REFER TO SHEET FPXXX FOR REQUIRED NUMBER OF HOSE CONNECTIONS)
lacktriangle		PENDENT SPRINKLER
\bigcirc		CONCEALED PENDENT SPRINKLER
\bigcirc		DRY PENDENT SPRINKLER
		UPRIGHT SPRINKLER
\boxtimes		SPRINKLER WITH GUARD
\triangleright		SIDEWALL SPRINKLER
		EXTENDED COVERAGE SPRINKLER
D		STANDARD DRY SIDEWALL SPRINKLER
		LOW DOINT DRAIN

LOW POINT DRAIN

GENERAL NOTES

CODES AND STANDARDS.

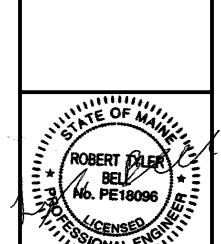
- 1. ALL GENERAL NOTES, SYMBOL LIST AND DETAILS SHALL BE CONSIDERED AS APPLICABLE TO ALL FIRE PROTECTION DRAWINGS FOR THIS PROJECT. SYMBOLS AND ABBREVIATIONS SHOWN ON THIS SHEET ARE FOR REFERENCE ONLY AND DOES NOT INDICATE THEIR INCORPORATION IN THE DESIGN.
- 2. INSTALLATION OF SPRINKLER SYSTEMS SHALL COMPLY WITH PROJECT SPECIFICATIONS, NFPA 13 (2016 ED) AS ADOPTED BY THE MAINE STATE RULES OF THE STATE FIRE MARSHAL CHAPTER 4 AND ALL APPLICABLE
- 3. WATER SUPPLY: REFER TO SPECIFICATION SECTION 21 13 13.
- 4. INSTALLING CONTRACTOR SHALL OBTAIN ALL REQUIRED PERMITS AND LICENSES.
- 5. SHOP DRAWINGS SUBJECT TO REVIEW, AND APPROVAL BY OWNER'S REPRESENTATIVE PRIOR TO CONTRACTOR'S SUBMISSION TO THE STATE FIRE MARSHAL.
- 6. SPRINKLER CONTRACTOR SHALL BE RESPONSIBLE FOR THE FINAL PIPING LAYOUT AND CALCULATIONS FOR THE FIRE SPRINKLER SYSTEMS.
- 7. CUTTING OF STRUCTURAL AND/OR ARCHITECTURAL MEMBERS NOT OTHERWISE SHOWN ON THE DRAWINGS, SHALL BE DONE ONLY WITH THE WRITTEN APPROVAL OF THE ARCHITECT OR STRUCTURAL ENGINEER.
- 8. REFER TO STRUCTURAL DRAWINGS FOR REQUIRED PENETRATIONS OF SPECIFIC STRUCTURAL MEMBERS.
- 9. FINAL INSTALLATION SUBJECT TO APPROVAL BY THE OWNER'S
- REPRESENTATIVE AND STATE FIRE MARSHAL. 10. PROVIDE SPARE SPRINKLERS IN ACCORDANCE WITH NFPA 13.
- 11. METHOD OF HANGING AND SUPPORTING EQUIPMENT, PIPES, HEADERS, AND BRANCH LINES SHALL BE IN ACCORDANCE WITH NFPA 13. HANGERS SHALL
- BE OF A TYPE APPROVED FOR USE WITH THE PIPE INVOLVED. 12. SPRINKLER PIPING DOES NOT REQUIRE BRACING FOR SEISMIC PROTECTION.
- REPLACED WITH NEW SPRINKLERS IN-KIND.

13. AUTOMATIC SPRINKLER REMOVED FOR DEMOLITION WORK SHALL BE

- 14. AUTOMATIC SPRINKLER TEMPERATURE RATINGS OF FUSIBLE ELEMENTS SHALL BE IN ACCORDANCE WITH NFPA 13.
- 15. ALL VALVES AND EQUIPMENT FOR FIRE SERVICE SHALL BE NEW AND LISTED BY THE UNDERWRITER'S LABORATORIES, INC, AND/OR FACTORY MUTUAL.
- 16. FIRE PROTECTION SYSTEM PRODUCTS AND INSTALLATION SHALL COMPLY WITH TECHNICAL SPECIFICATION 211313.
- 17. PROVIDE A PERMANENTLY ATTACHED HYDRAULIC NAME PLATE STATING THE REQUIRED DESIGN CRITERIA FOR EACH HYDRAULICALLY DESIGNED SYSTEM IN ACCORDANCE WITH NFPA 13.
- N 18. ONLY NEW MATERIALS SHALL BE USED IN THE INSTALLATION OF THESE
- 19. ALL FIRE SPRINKLERS MOUNTED IN CEILINGS SHALL BE LOCATED A MINIMUM OF 4 INCHES AWAY FROM WALLS, CEILING HEIGHT CHANGES, OR OTHER VERTICAL INTERSECTING SURFACES.
- 20. ALL BRACING SHALL BE ATTACHED TO THE BUILDINGS STRUCTURAL FRAME IN ACCORDANCE WITH NFPA 13.
- 21. INSTALL EQUIPMENT IN ACCORDANCE WITH THE MANUFACTURER'S
- INSTRUCTIONS.
- 22. THE DRAWINGS DEPICT THE PROPOSED SPRINKLER SYSTEM MODIFICATIONS RELATIVE TO ANTICIPATED DEMOLITION. RECOMMENDED PIPE PENETRATION LOCATIONS, AND SIZES FOR NEW PIPES. DEPENDING ON SITE CONDITIONS AT SPECIFIC LOCATIONS, CONTRACTOR MAY ELECT AN ALTERNATE DEMOLITION APPROACH, PIPING SIZE AND PIPING ROUTE AND SUBMIT WITH SHOP DRAWINGS AND HYDRAULIC CALCULATIONS FOR APPROVAL.

GENERAL DEMOLITION NOTES

- 1. DEMOLITION SHALL BE COORDINATED BY THE CONTRACTOR TO MAINTAIN THE INTEGRITY OF THE BUILDING.
- 2. COORDINATE DEMOLITION OF FIRE SPRINKLER SYSTEMS WITH THAT OF OTHER TRADES.
- 3. CONTRACTOR SHALL REPLACE ANY ITEM OR EQUIPMENT DAMAGED DURING CONTRACTOR'S DEMOLITION.
- 4. REMOVE ASSOCIATED PIPING, CONTROLS, HANGERS, AND SUPPORTS WITH ITEMS OR EQUIPMENT BEING DEMOLISHED UNLESS NOTED OTHERWISE.
- 5. PROVIDE TEMPORARY VALVES AND/OR CAPS AS NEEDED FOR FUTURE
- 6. ANY ITEMS OR EQUIPMENT THAT ARE REMOVED TO FACILITATE THE DEMOLITION OR INSTALLATION OF NEW EQUIPMENT SHALL BE REINSTALLED BACK TO ITS PRE-DEMOLITION CONDITION.
- 7. PATCH OPENINGS IN ROOFS, CEILINGS, CEILING TILES, AND WALLS MADE DURING DEMOLITION AND CONSTRUCTION AND MATCH EXISTING.

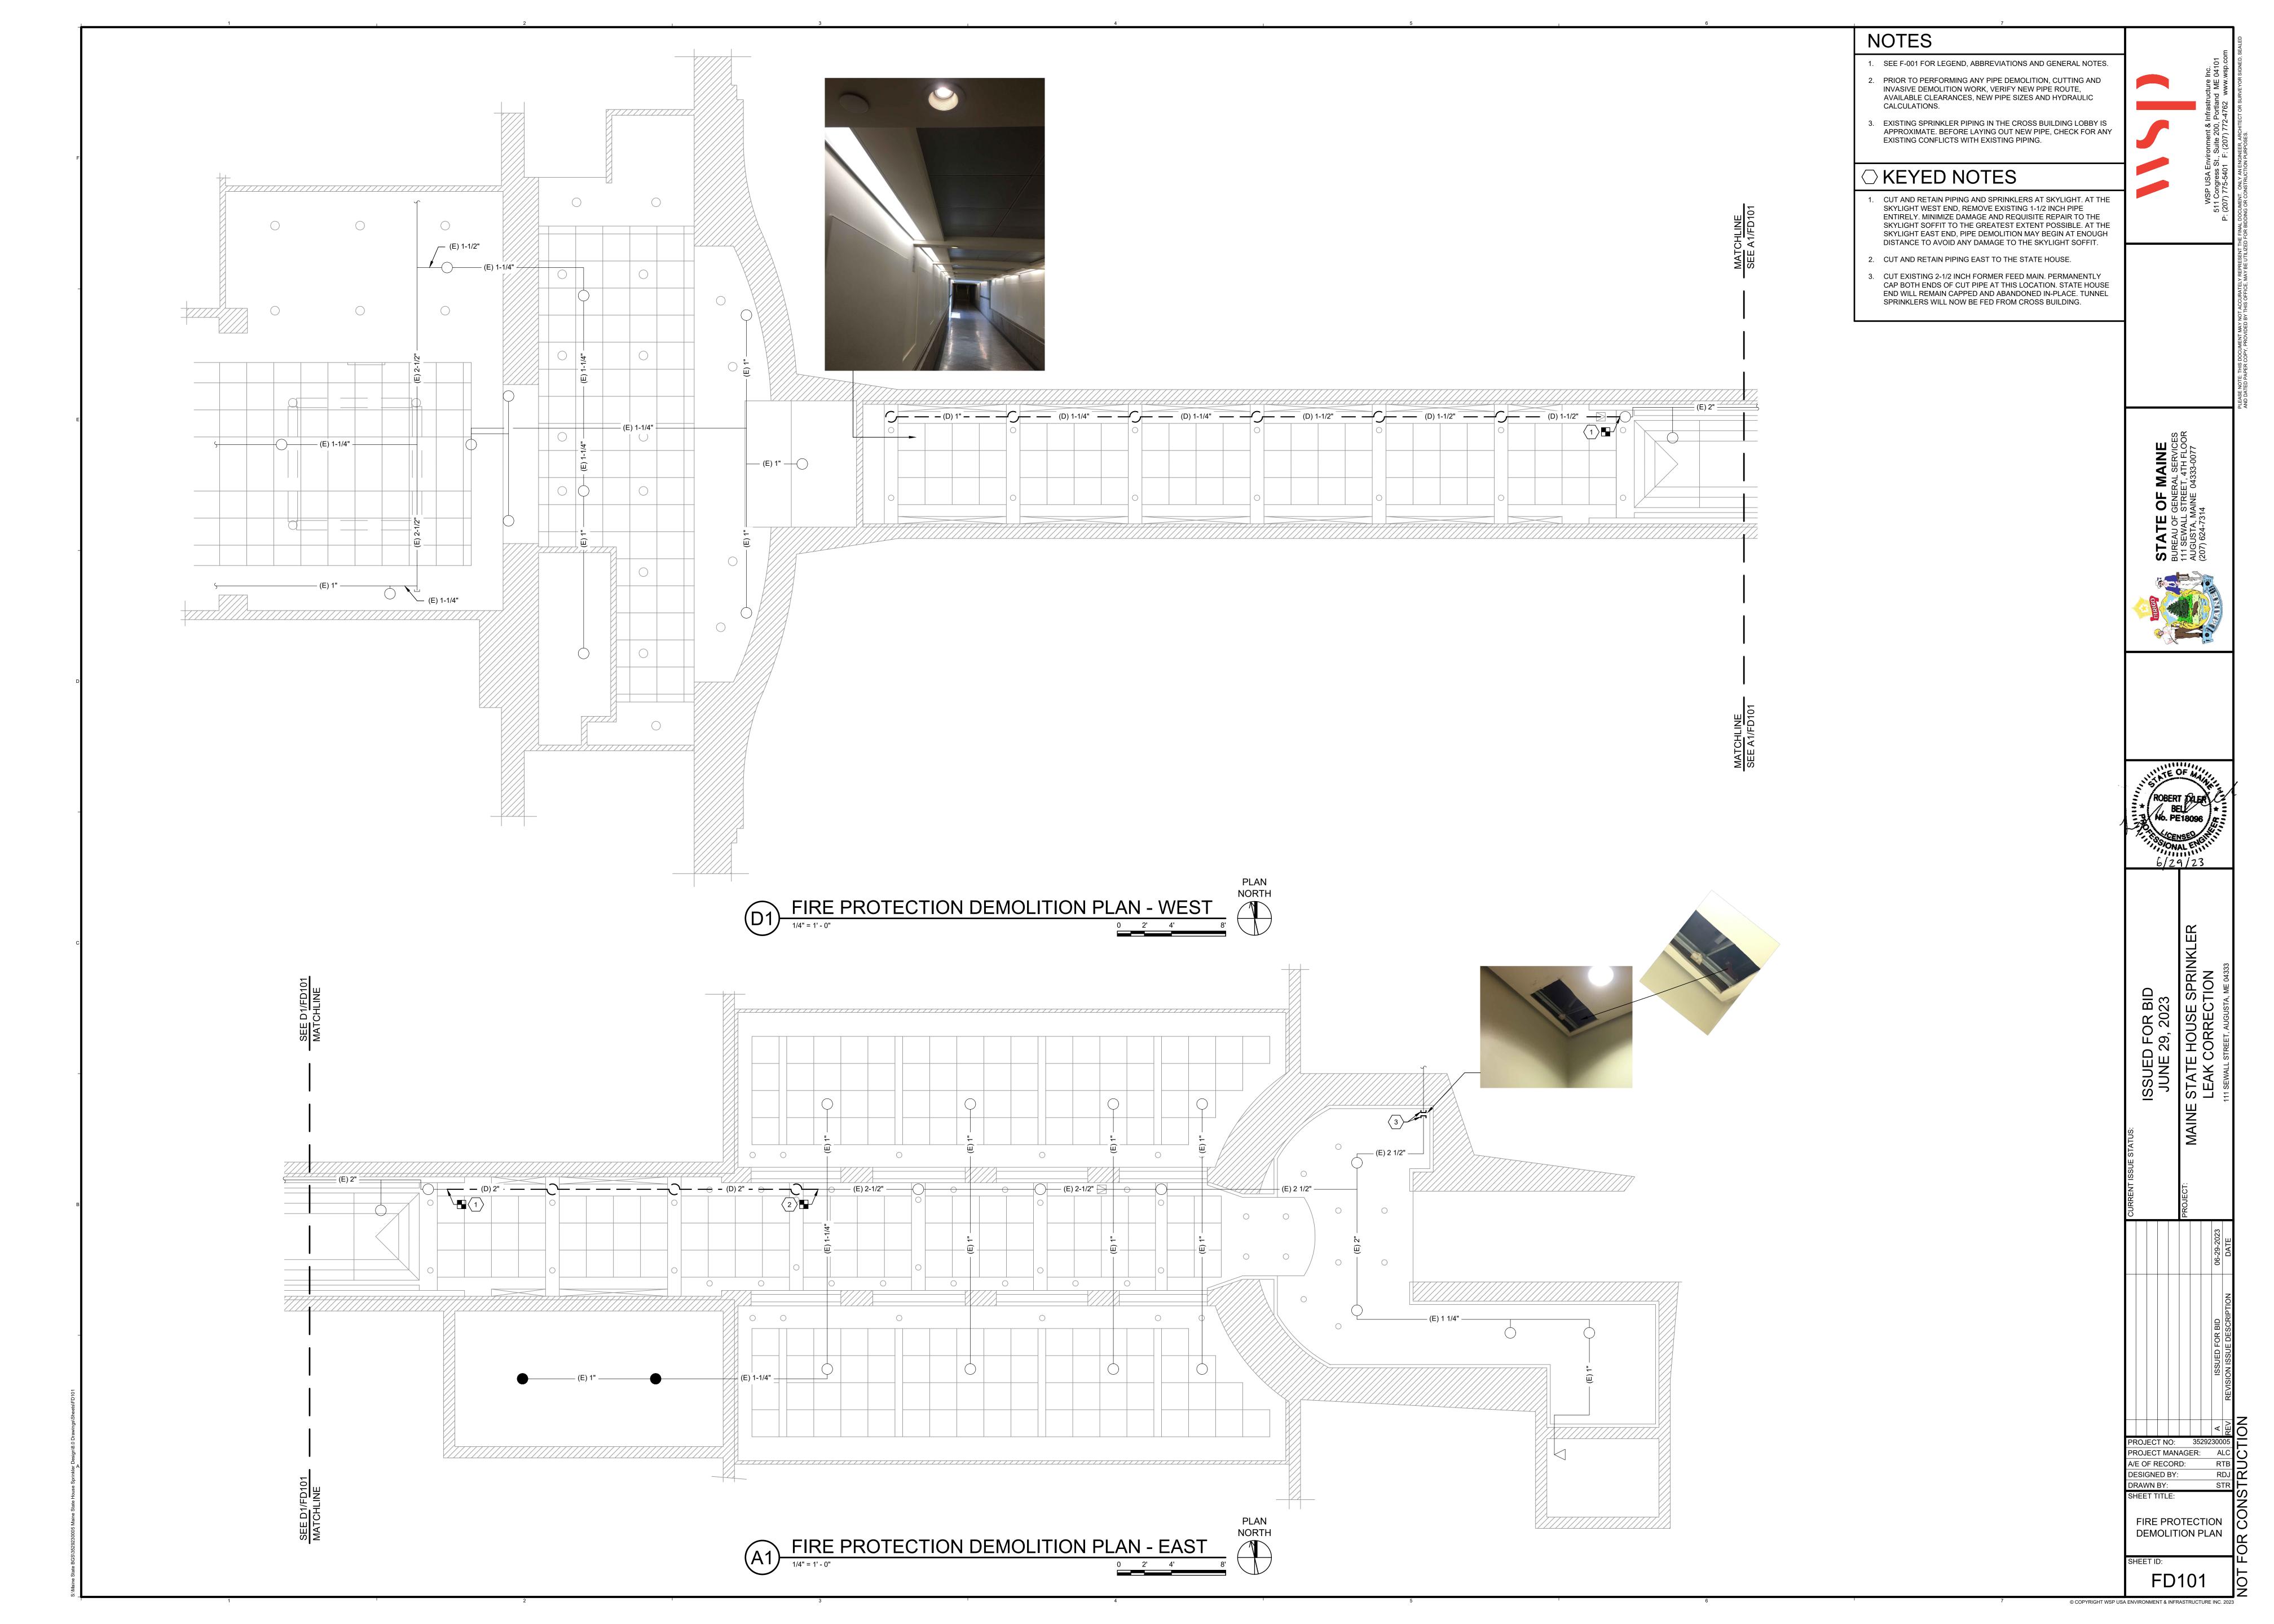


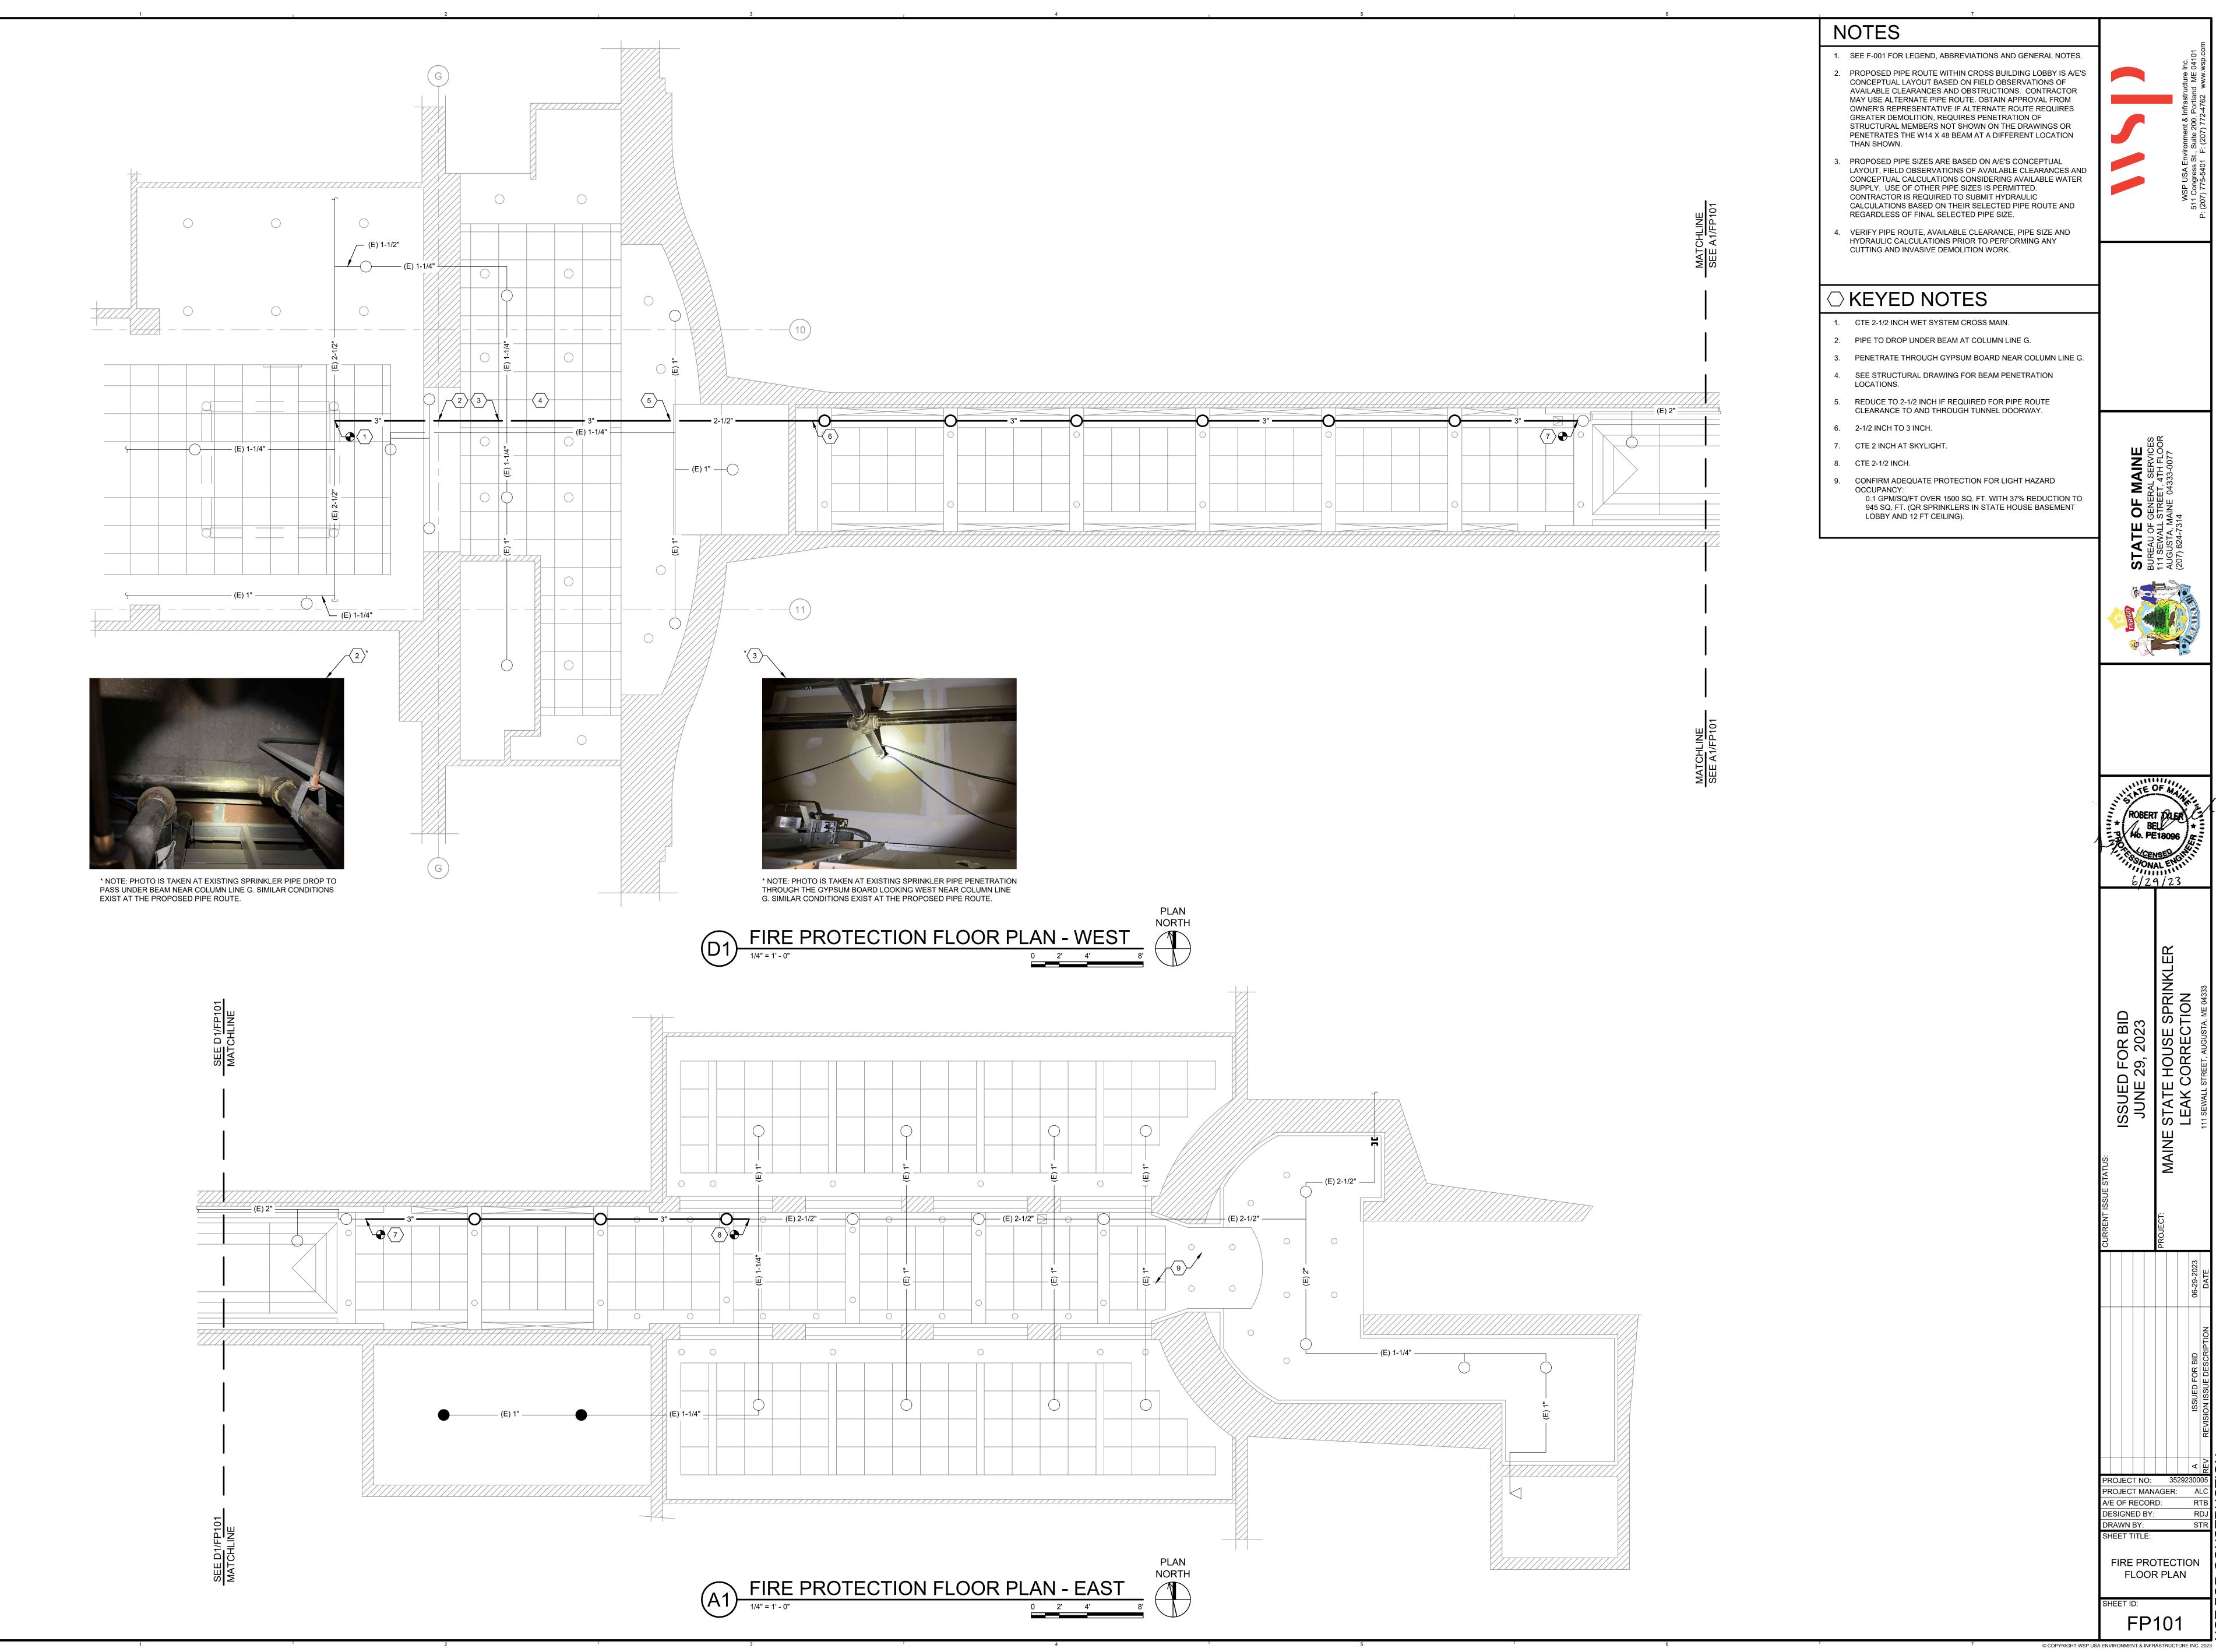
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LEGEND, ABBREVIATIONS AND GENERAL NOTES

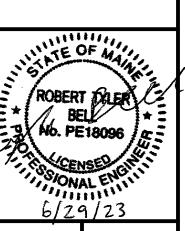
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FIRE PROTECTION FLOOR PLAN