Addendum Number 04



To: Prospective Bidders

Project: 10030.001 MeANG Building B493 Re-Roof September 16, 2021

From:

WBRC ARCHITECTS ENGINEERS
44 Central Street
Bangor, ME 04401-5116
(207) 947-4511

www.wbrcae.com

This Addendum forms a part of the Contract Documents and modifies the original Bidding Documents dated August 13, 2021, as noted below. Acknowledge receipt of the Addendum in the space provided on the Bid Form. Failure to do so may subject the Bidder to disqualification.

This Addendum consists of the following:

- Clarifications
- Specification Changes
 Drawing Changes

CLARIFICATIONS:

- 1. See attached sign-in sheet completed at the non-mandatory pre-bid meeting on September 14, 2021.
- 2. Question: The scale appears to be off on the roof plan. Can you verify and possibly provide me the most current set of drawings? There are very few dimensions on the roof plan.

Answer: . The entire "Issued for Bid" drawing set is being reissued. See Drawing Changes in this Addendum.

3. Question: You have noted, perimeter flashing on the canopy is to remain. This will get destroyed during the existing roof assembly removal process, as it is part of the existing roof assembly and will not be easily cleaned and/or salvaged.

Answer: The design intent is to protect and retain existing fascia. See revised note on detail A8/AE501, included in reissued drawing set.

4. Question: For clarification, you are requesting asphalt primer be installed over concrete deck, and the first layer of ISO to be installed in hot asphalt. Correct?

Answer: No. The design intent is to use bead-applied, low-rise, one-component or multicomponent urethane adhesive for installation over concrete roof deck and between insulation layers as recommended by the roofing manufacturer. See Specification changes for Section 07 53 32, EPDM Roofing in this Addendum.

5. Question: Can 4x8 sheets of ISO be used after the initial layer of (4x4) Insulation is installed in the Asphalt provided it meets the manufacturers 30 year specifications?

Answer: Yes.

6. Can you elaborate on the specification for the (2) permanent tie-off anchors, if more than described under part 3, Project Execution, 3.2.10?

Answer: There are no tie-off anchors required for this project.

7. Also, I do not see the anchor locations identified on the roof plan. At the Ladder tie-off location is described. If just 3/8" eyebolt lags into the perimeter wood blocking, do you have a detail on securement and flashing expectations?

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Answer: There are no ladder tie-off anchors required.

8. With regards to sheet metal, we generally deal with aluminum starting at .032 thickness and steel starting at 24 ga. We also work with copper, 16 and 20 oz., freedom grey, galvalume, lead coated copper and stainless. Your spec. of Aluminum-Zinc Alloy-coated steel has been difficult to acquire for pricing. The thickness also ranges between .022 and .034. Would an alternative be considered in one thickness?

Answer: Alternatives will be considered one month prior to start of construction. Successful bidder may submit substitution request for product equivalent to .034 Aluminum-Zinc Alloy-coated steel in strength, durability, and finish.

SPECIFICATION CHANGES:

9. Section 01 10 00, Summary, Par. 1.5.A, Revise Project Schedule as follows:

1.	First bid advertisement	09/04/21
2.	Second bid advertisement	09/11/21
3.	Pre-bid job walk (non-mandatory), 9:00 am, at project site	09/14/21
4.	Final date for bidding questions, 2:00 pm	09/16/21
5.	Open bids (virtual online meeting), 2:00 pm	09/21/21
6.	Begin construction	06/13/22
7.	End construction Phase 1 (interior piping warehouse)	07/22/22
8.	Begin construction Phase 2 (interior piping offices)	07/25/22
9.	End construction (Phase 1 and Phase 2)	08/19/22
10.	Punch list generated	08/26/22
11.	Substantial Completion	09/09/22
12.	Final Completion	09/30/22

10. Section 07 53 32, EPDM Roofing, DELETE Paragraphs 2.5.B.2, 3.4.C.1.f.1), 3.4.C.1.f.2), and 3.4.C.1.f.4).

DRAWINGS CHANGES:

11. REPLACE "ISSUED FOR BID DRAWINGS" with the attached. The entire "Issued for Bid" drawing set is being reissued due to a printing error in original "Issued for Bid" drawings. Reissued drawings are indicated with "Addendum 04 - 09.16.2021" in the title block. No changes to the content of drawings have been made with the exception of:

Sheets AE102, AE103, AE501, revisions shown clouded.

END OF ADDENDUM



PRE-BID MEETING SIGN-IN SHEET

Project: MeANG Building B493 Re-Roof

WBRC Project Number: 10030.001

Meeting Date: Tuesday, September 14, 2021, 9:00 am

Meeting Location: Project Site

ATTENDEE	Company Name	Telephone	Email
MARK SMITH	Rog-Systems OF MAINI	207-557-0710	MSMITH @TECTHAMERICA. Com
BRAD HAASE	•		BHAASE @ HAHWEE BROSCO COM
Glew bonikus	101665	207 907-073	7 GLC Tompkins. Leus. A.E.M.
STEVE PEDETLEN	WBRC	207 947 4511	steve. prodersen e wbrcae.com
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Meang Building B493 RE-ROOF

MAINE AIR NATIONAL GUARD, BUILDING B493 101 GLEN AVE., BANGOR ANGB BANGOR MAINE 04401



BANGOR, MAINE
(207) 947-4511
PORTLAND, MAINE
(207) 828-4511
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(941) 556-0757
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INDEX

GENERAL DRAWING
GI001 COVER SHEET
GI002 SYMBOLS AND ABBREVIATIONS

PHOTOS

CU101 UTILITY PLAN

ARCHITECTURAL DRAWINGS
AE101 FIRST FLOOR PLAN
AE102 REFLECTED CEILING PLAN


ROOF PLAN DETAILS

PLUMBING DRAWINGS


CIVIL DRAWINGS

001 PLUMBING LEGEND
101 FIRST FLOOR PLUMBING PLAN

ROOF PLUMBING PLAN

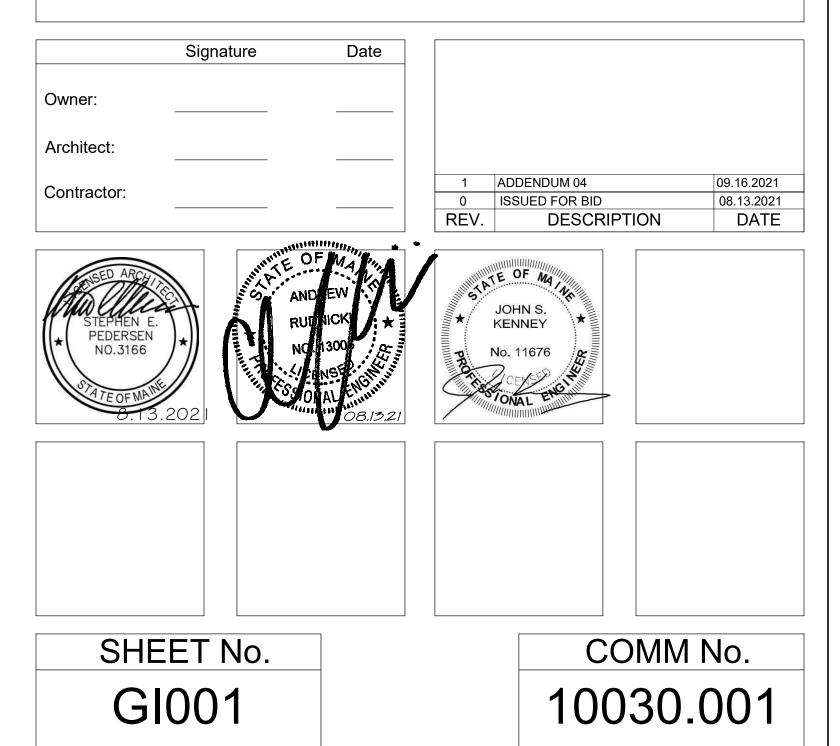



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SYMBOLS

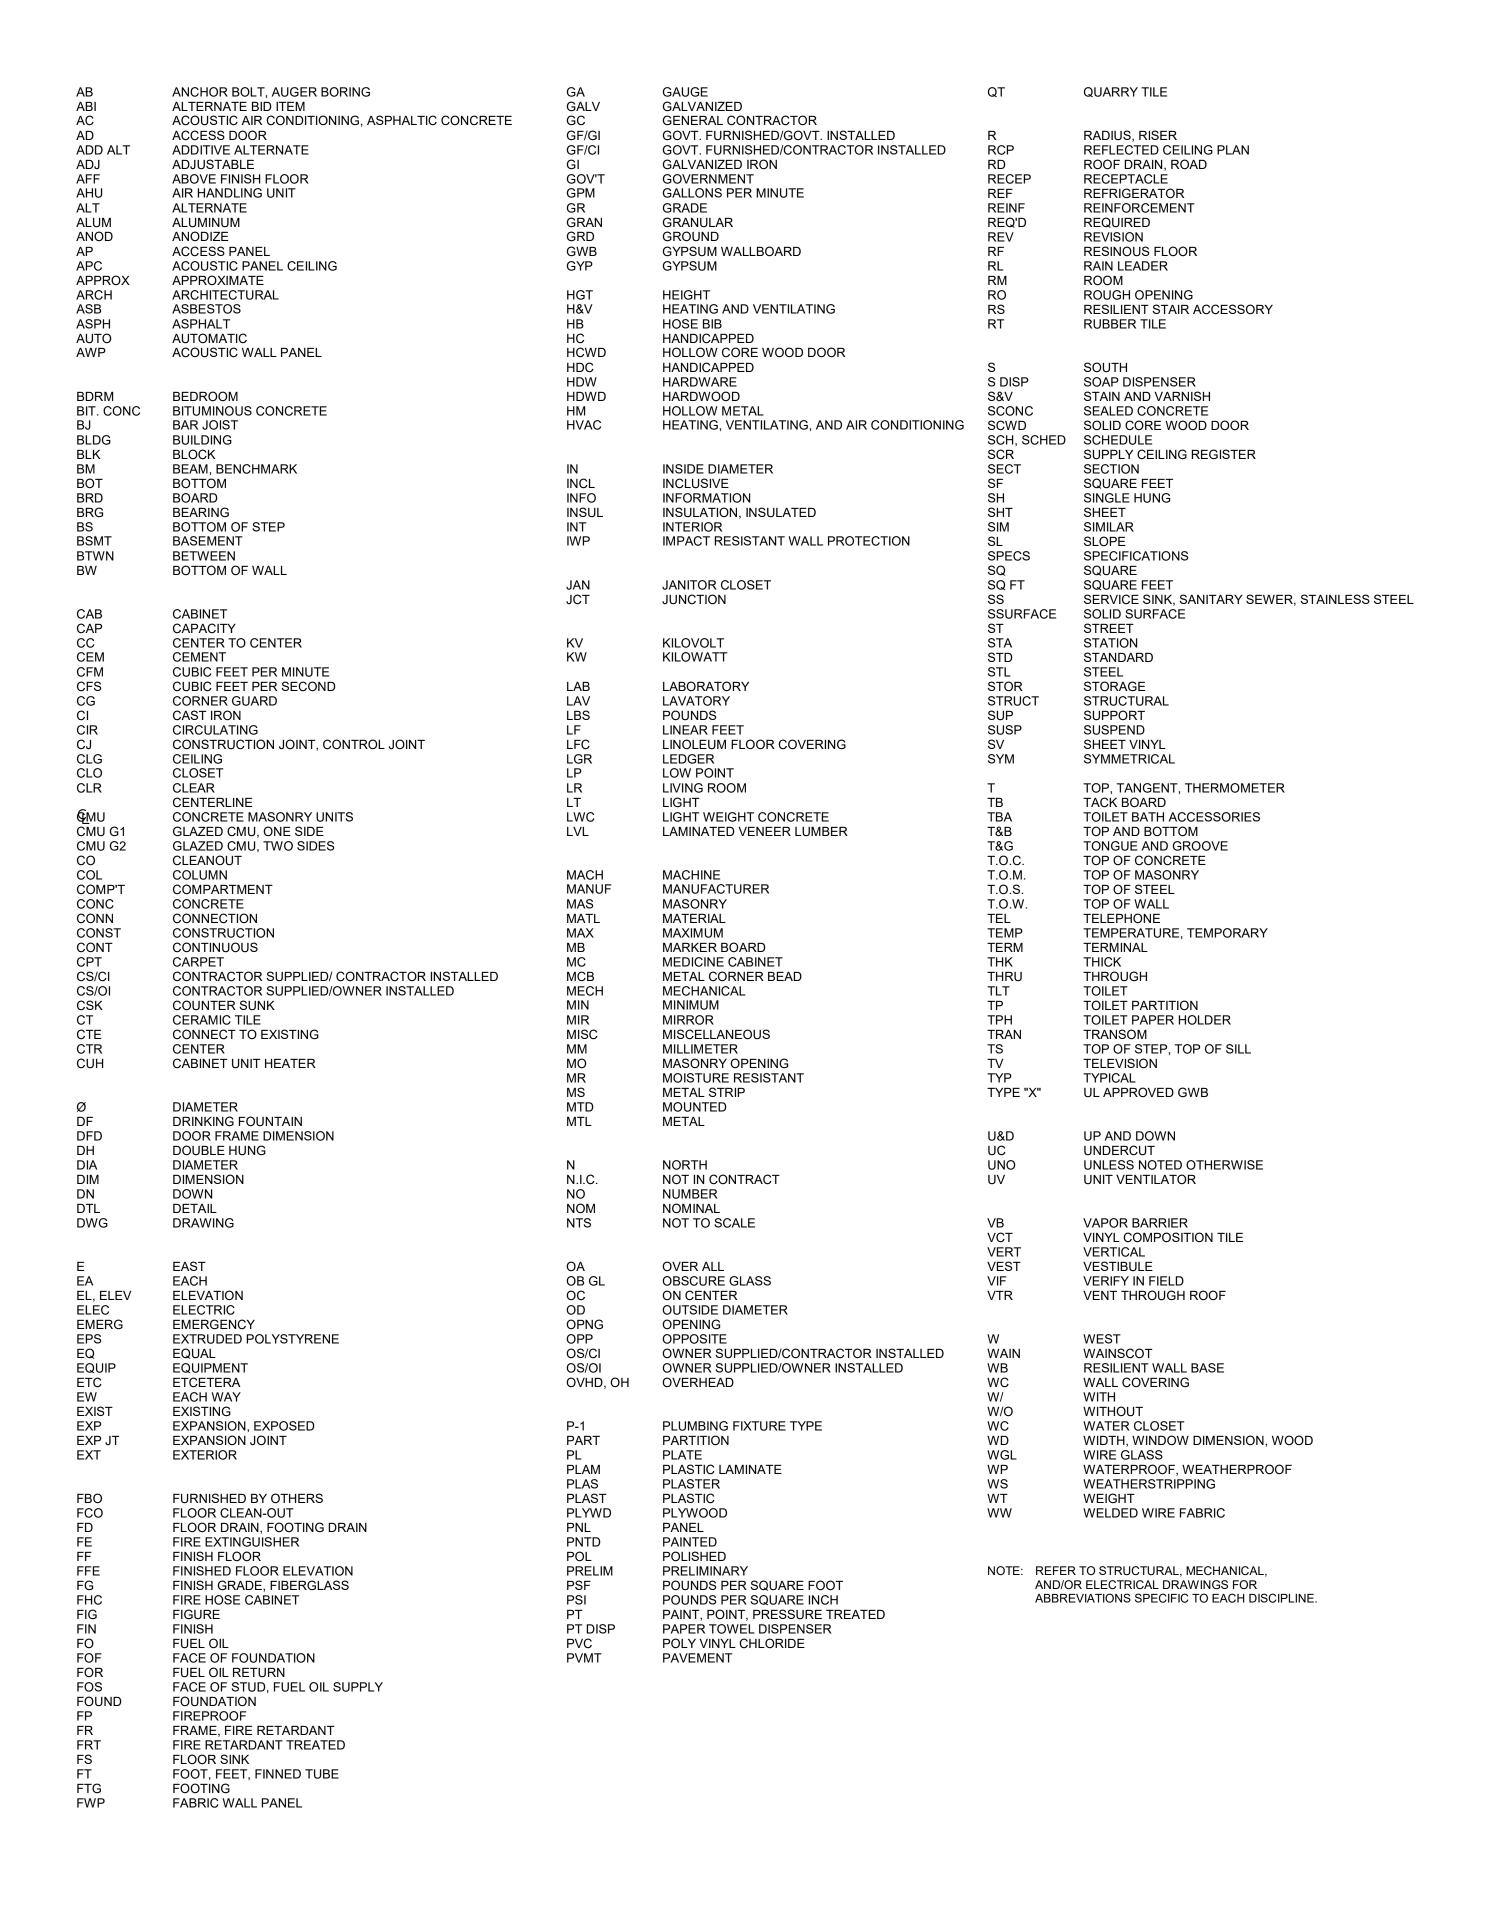HATCH PATTERNS



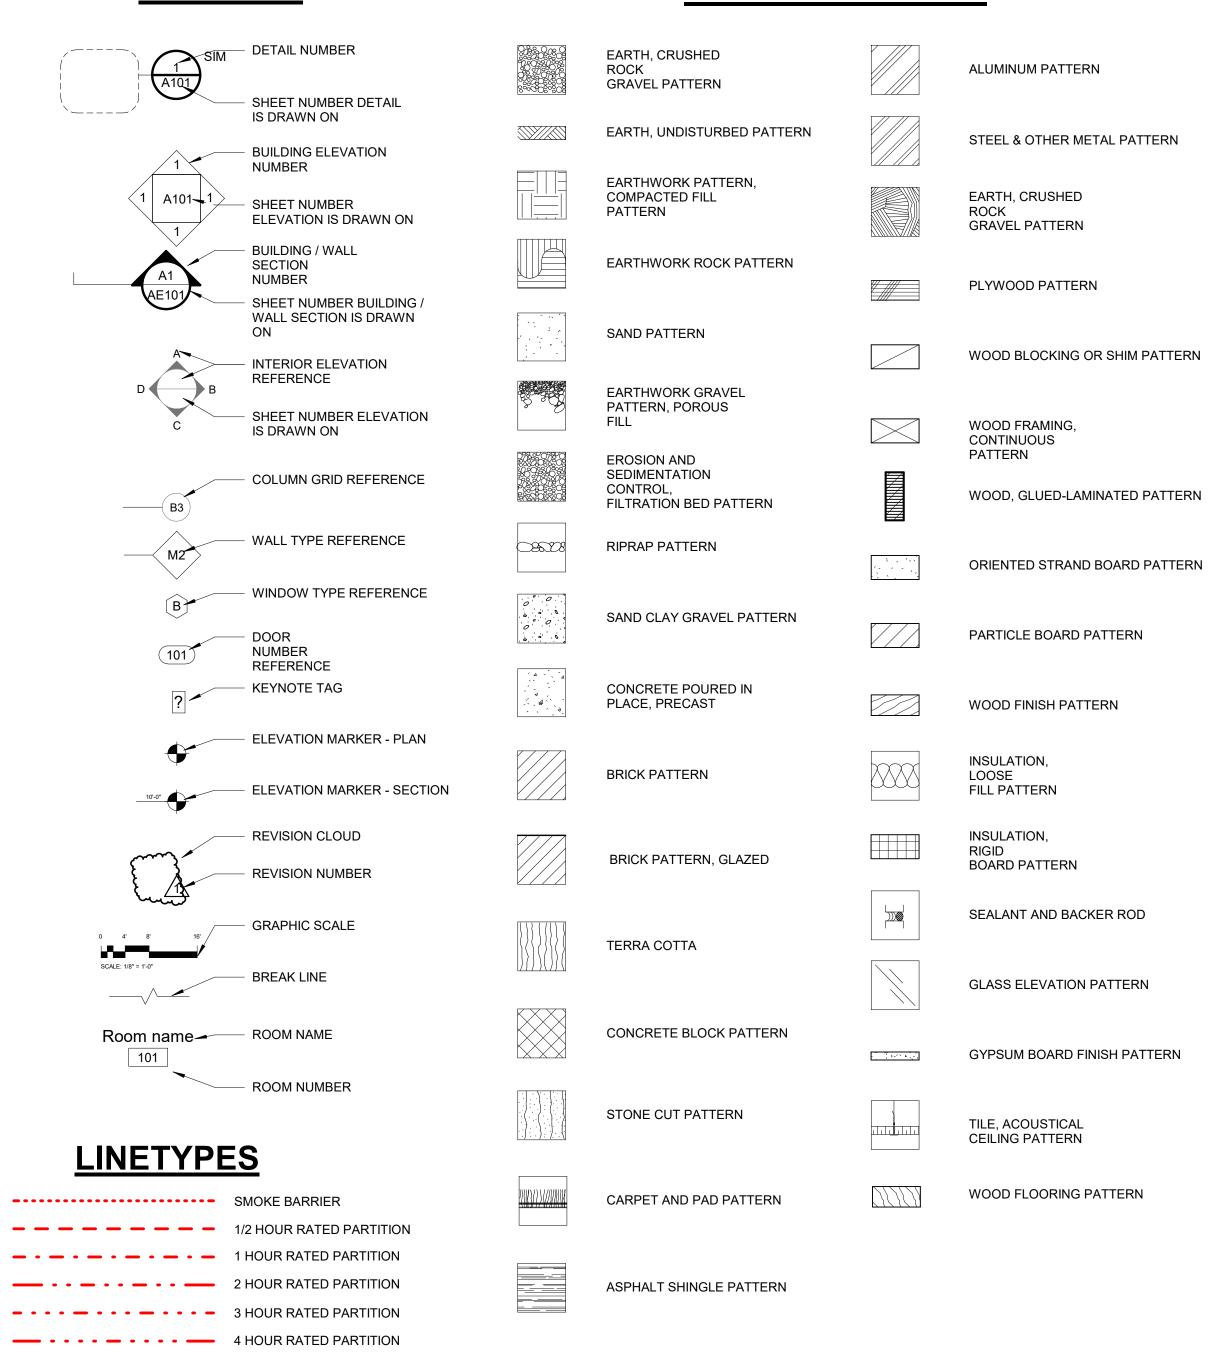

0 ISSUED FOR BID 08.13.2021 DESCRIPTION DATE WWW.WBRCAE.COM BANGOR, MAINE 207-947-4511 PORTLAND, MAINE 207-828-4511 SARASOTA, FLORIDA 941-556-075

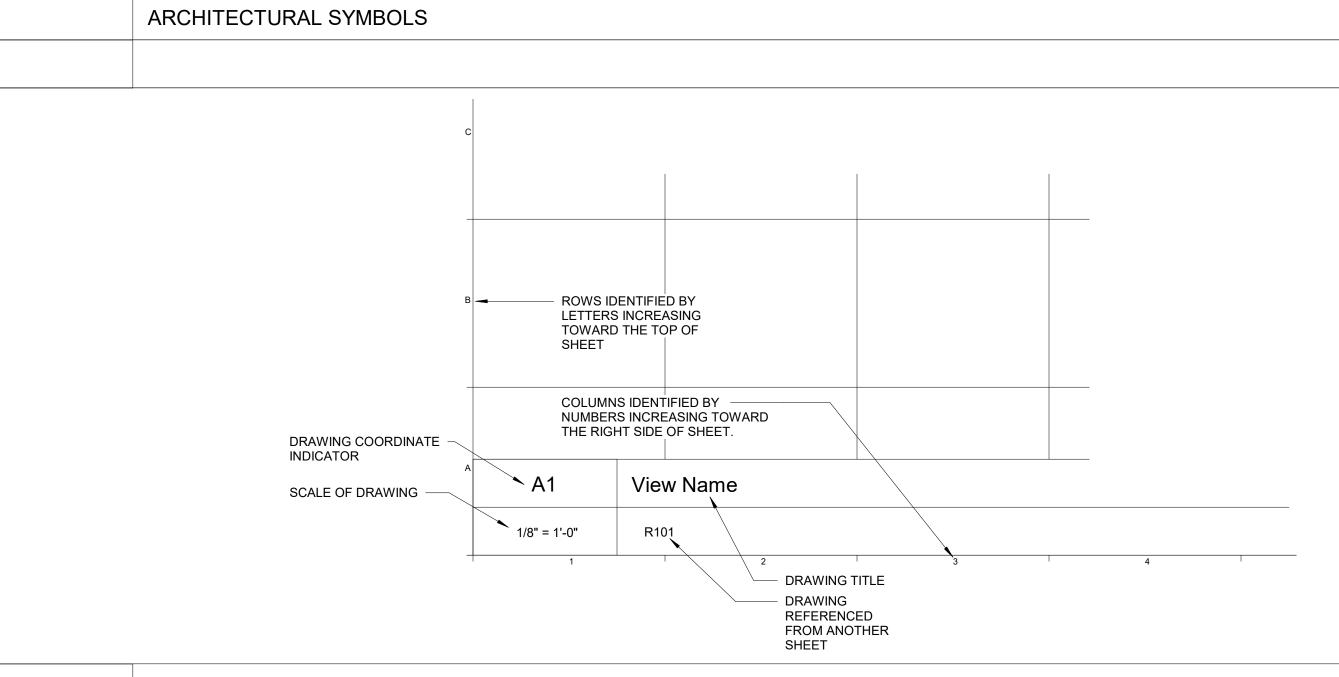1 ADDENDUM 04

MeANG BUILDING B493 RE-ROOF

> SYMBOLS AND **ABBREVIATIONS**

SHEET TITLE: WBRC CAD FILE: MeANG B493 ROOF.RVT 10030.001 GRAPHIC SCALE: PROJECT No.

As indicated PROJECT MANAGER: DRAWN BY

CHECKED BY:

RCC

SEP


ARCHITECTURAL ABBREVIATIONS


DRAWING AREA

— • — • — MATCH LINE

GI002


09.16.2021

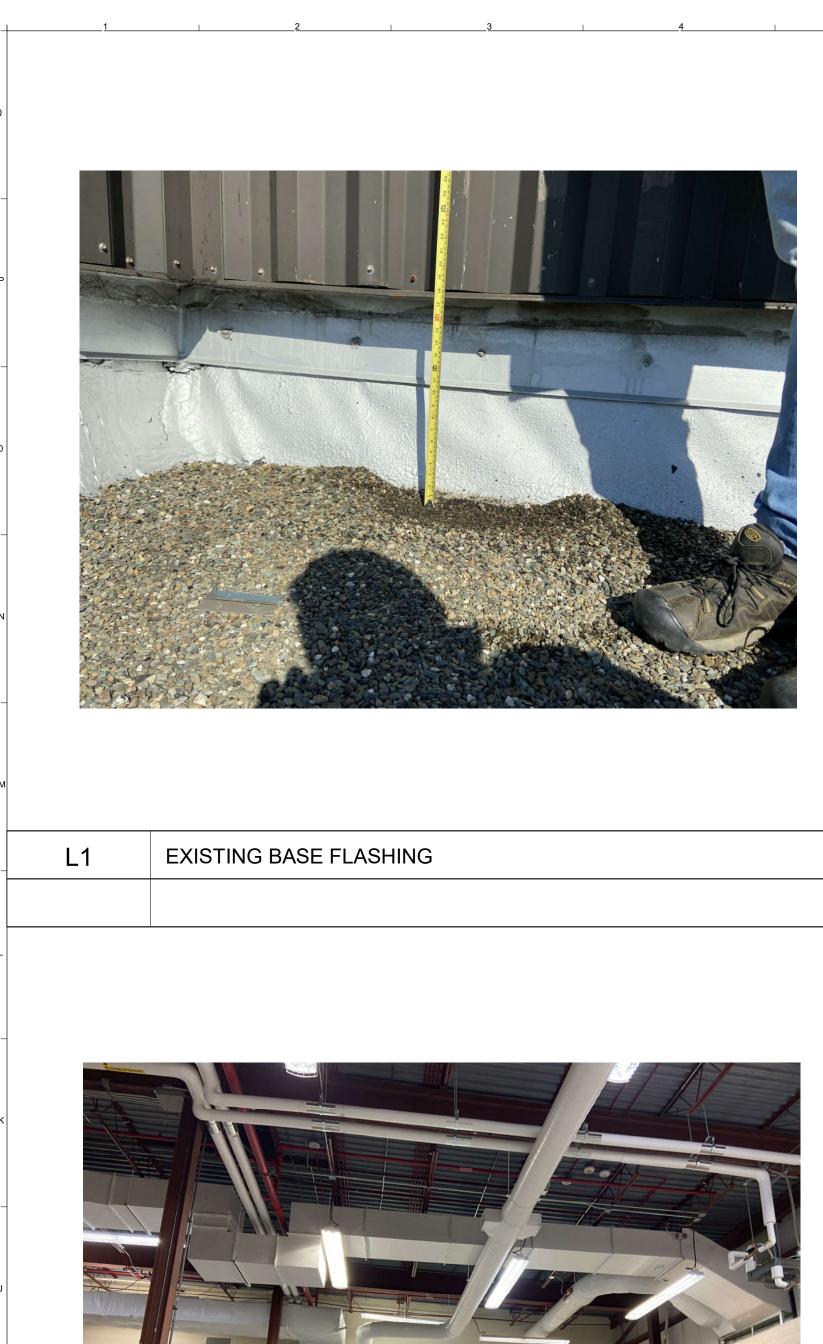


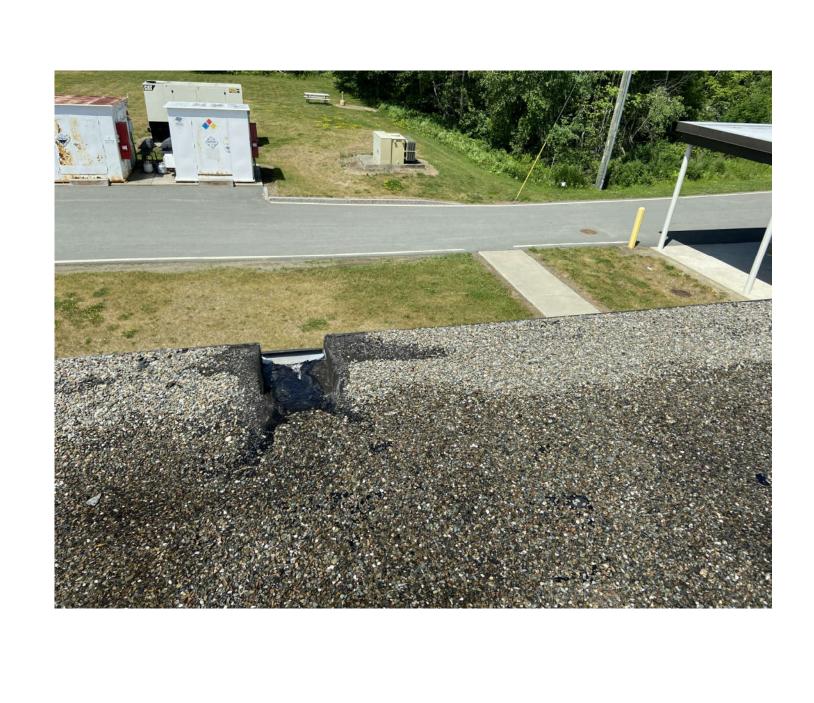



FLASHING TRANSITION

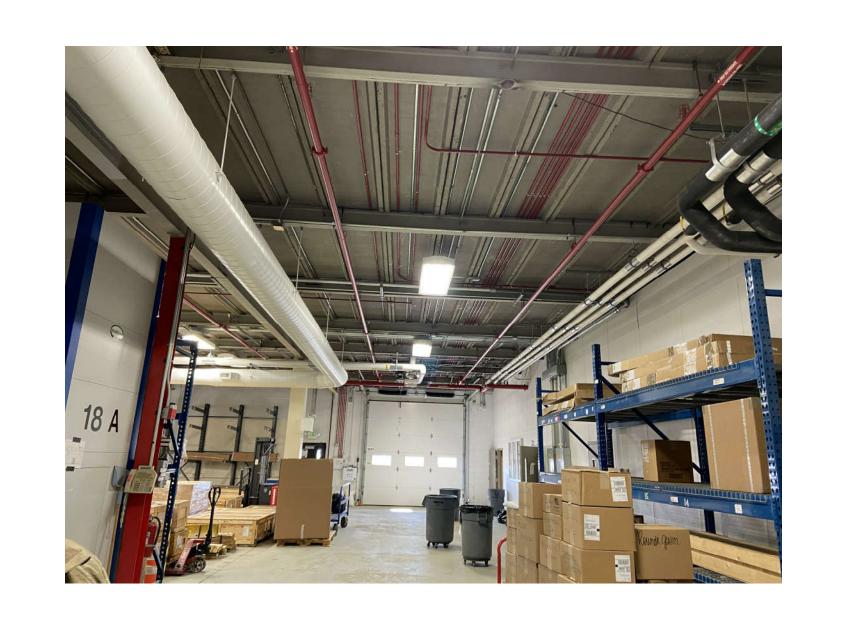

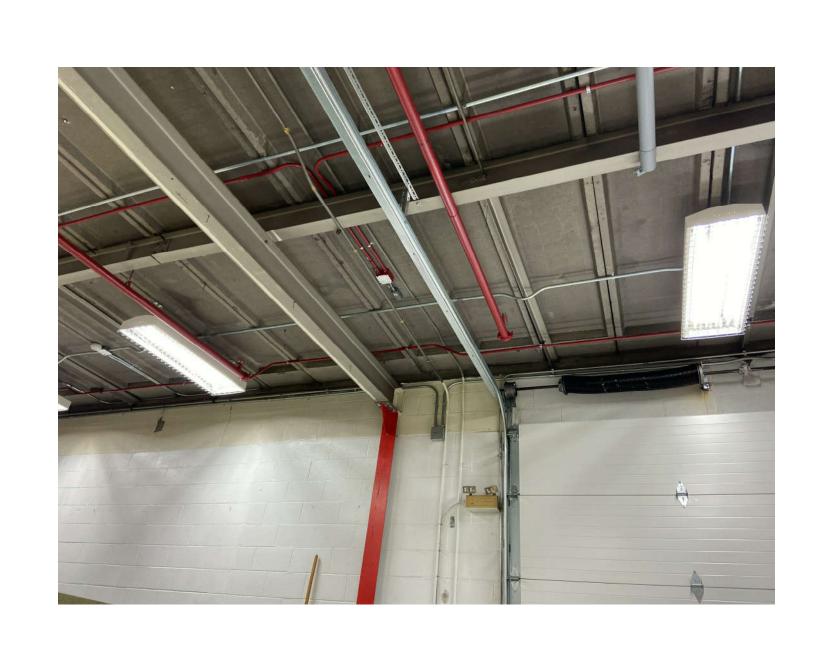





INTERIOR AT DEMISING WALL

INTERIOR DETAIL

EXISTING SCUPPER

LOW CANOPY (BACKGROUND) ENTRY CANOPY N.I.C (FOREGROUND) 1" = 30'-0"

INTERIOR

L14


LOWER CANOPY ROOF









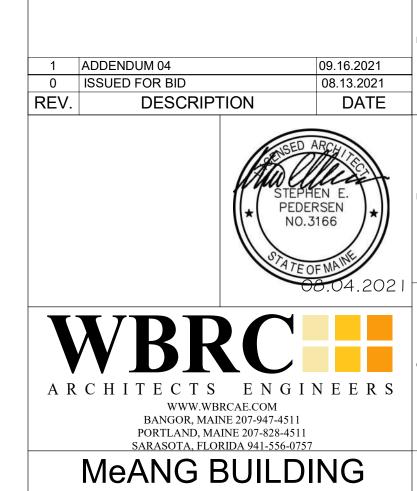

PHOTOS

CHECKED BY:

B493 RE-ROOF

SHEET TITLE: WBRC CAD FILE: MeANG B493 ROOF.RVT 10030.001 GRAPHIC SCALE: PROJECT No. 1" = 30'-0" ROOF PENETRATION MAIN ROOF MAIN ROOF SHOWING PONDING EAST ELEVATION SEP SHEET No. PROJECT MANAGER: GI003 DRAWN BY:


UTILITY NOTES:

1. SITE CONTRACTOR TO FIELD VERIFY ALL EXISTING UTILITIES PRIOR TO BEGINNING ANY PROPOSED WORK.

2. SITE AND EXISTING UTILITIES LAYOUT FROM UTILITY PLAN PROVIDED BY OAK POINT ASSOCIATES, DATED FEBRUARY 19, 2013.

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<i>☆</i>	BUILDING LIGHTING	坐
$\oplus \bigvee^{WV}$	WATER SHUTOFF / GATE VALVE	₩V
T	TRANSFORMER PAD	
D	DUMPSTER	D
MH	MANHOLE	•
SMH	SEWER MANHOLE	•
	CATCH BASIN	•
++++	FIRE HYDRANT	*
-0	SIGN FENCING	
	P.T. GUARD RAIL	
	PAVEMENT	
	SIDEWALK	
G	GAS SERVICE / MAIN	NG
W	WATER SERVICE / MAIN	NW
SD	STORM DRAIN	NSD
	UNDERDRAIN	NUD-
	FOOTING DRAIN	——NFD
SS	CLEANOUT SANITARY SEWER	0 [NSS]
UE	UNDERGROUND ELECTRIC	—
OL	UNDERGROUND SECONDARY	NUS
	UNDERGROUND PRIMARY	NUP NUP
OE	AERIAL ELEC. / PRIMARY	NAP
	COMMUNICATIONS	NCOM
	PROPERTY SETBACK	
	PROPERTY LINE	
	ABUTTING PROPERTY LINE	
^ ^ ^ ^ . . .	TDEE I INE	\

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ARCHITECTS • ENGINEERS
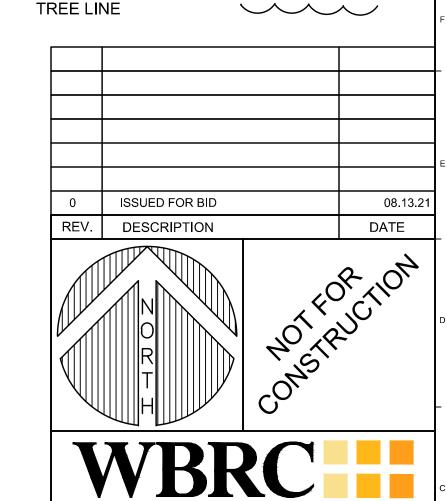
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SARASOTA, FLORIDA 941-373-1583


MeANG B493 ROOF


PROJECT: 101 Glen Ave, Bangor ANGB, Bangor, Maine


UTILITY PLAN


SHEET TITLE:		
WBRC CAD FILE:		10030001-SP101.DW
PROJECT No.	10030.001	GRAPHIC SCALE: 0"
SCALE:	1"=20'	
PROJECT MANAGER:	SEP	SHEET No.
DRAWN BY:	KRB	CU101

02 Projects\10001-10100\10030001 MeANG B493 Roof\2DE5\Dmgs\5ite\10030001-5P101.dmg kris.bears > 1 0 0

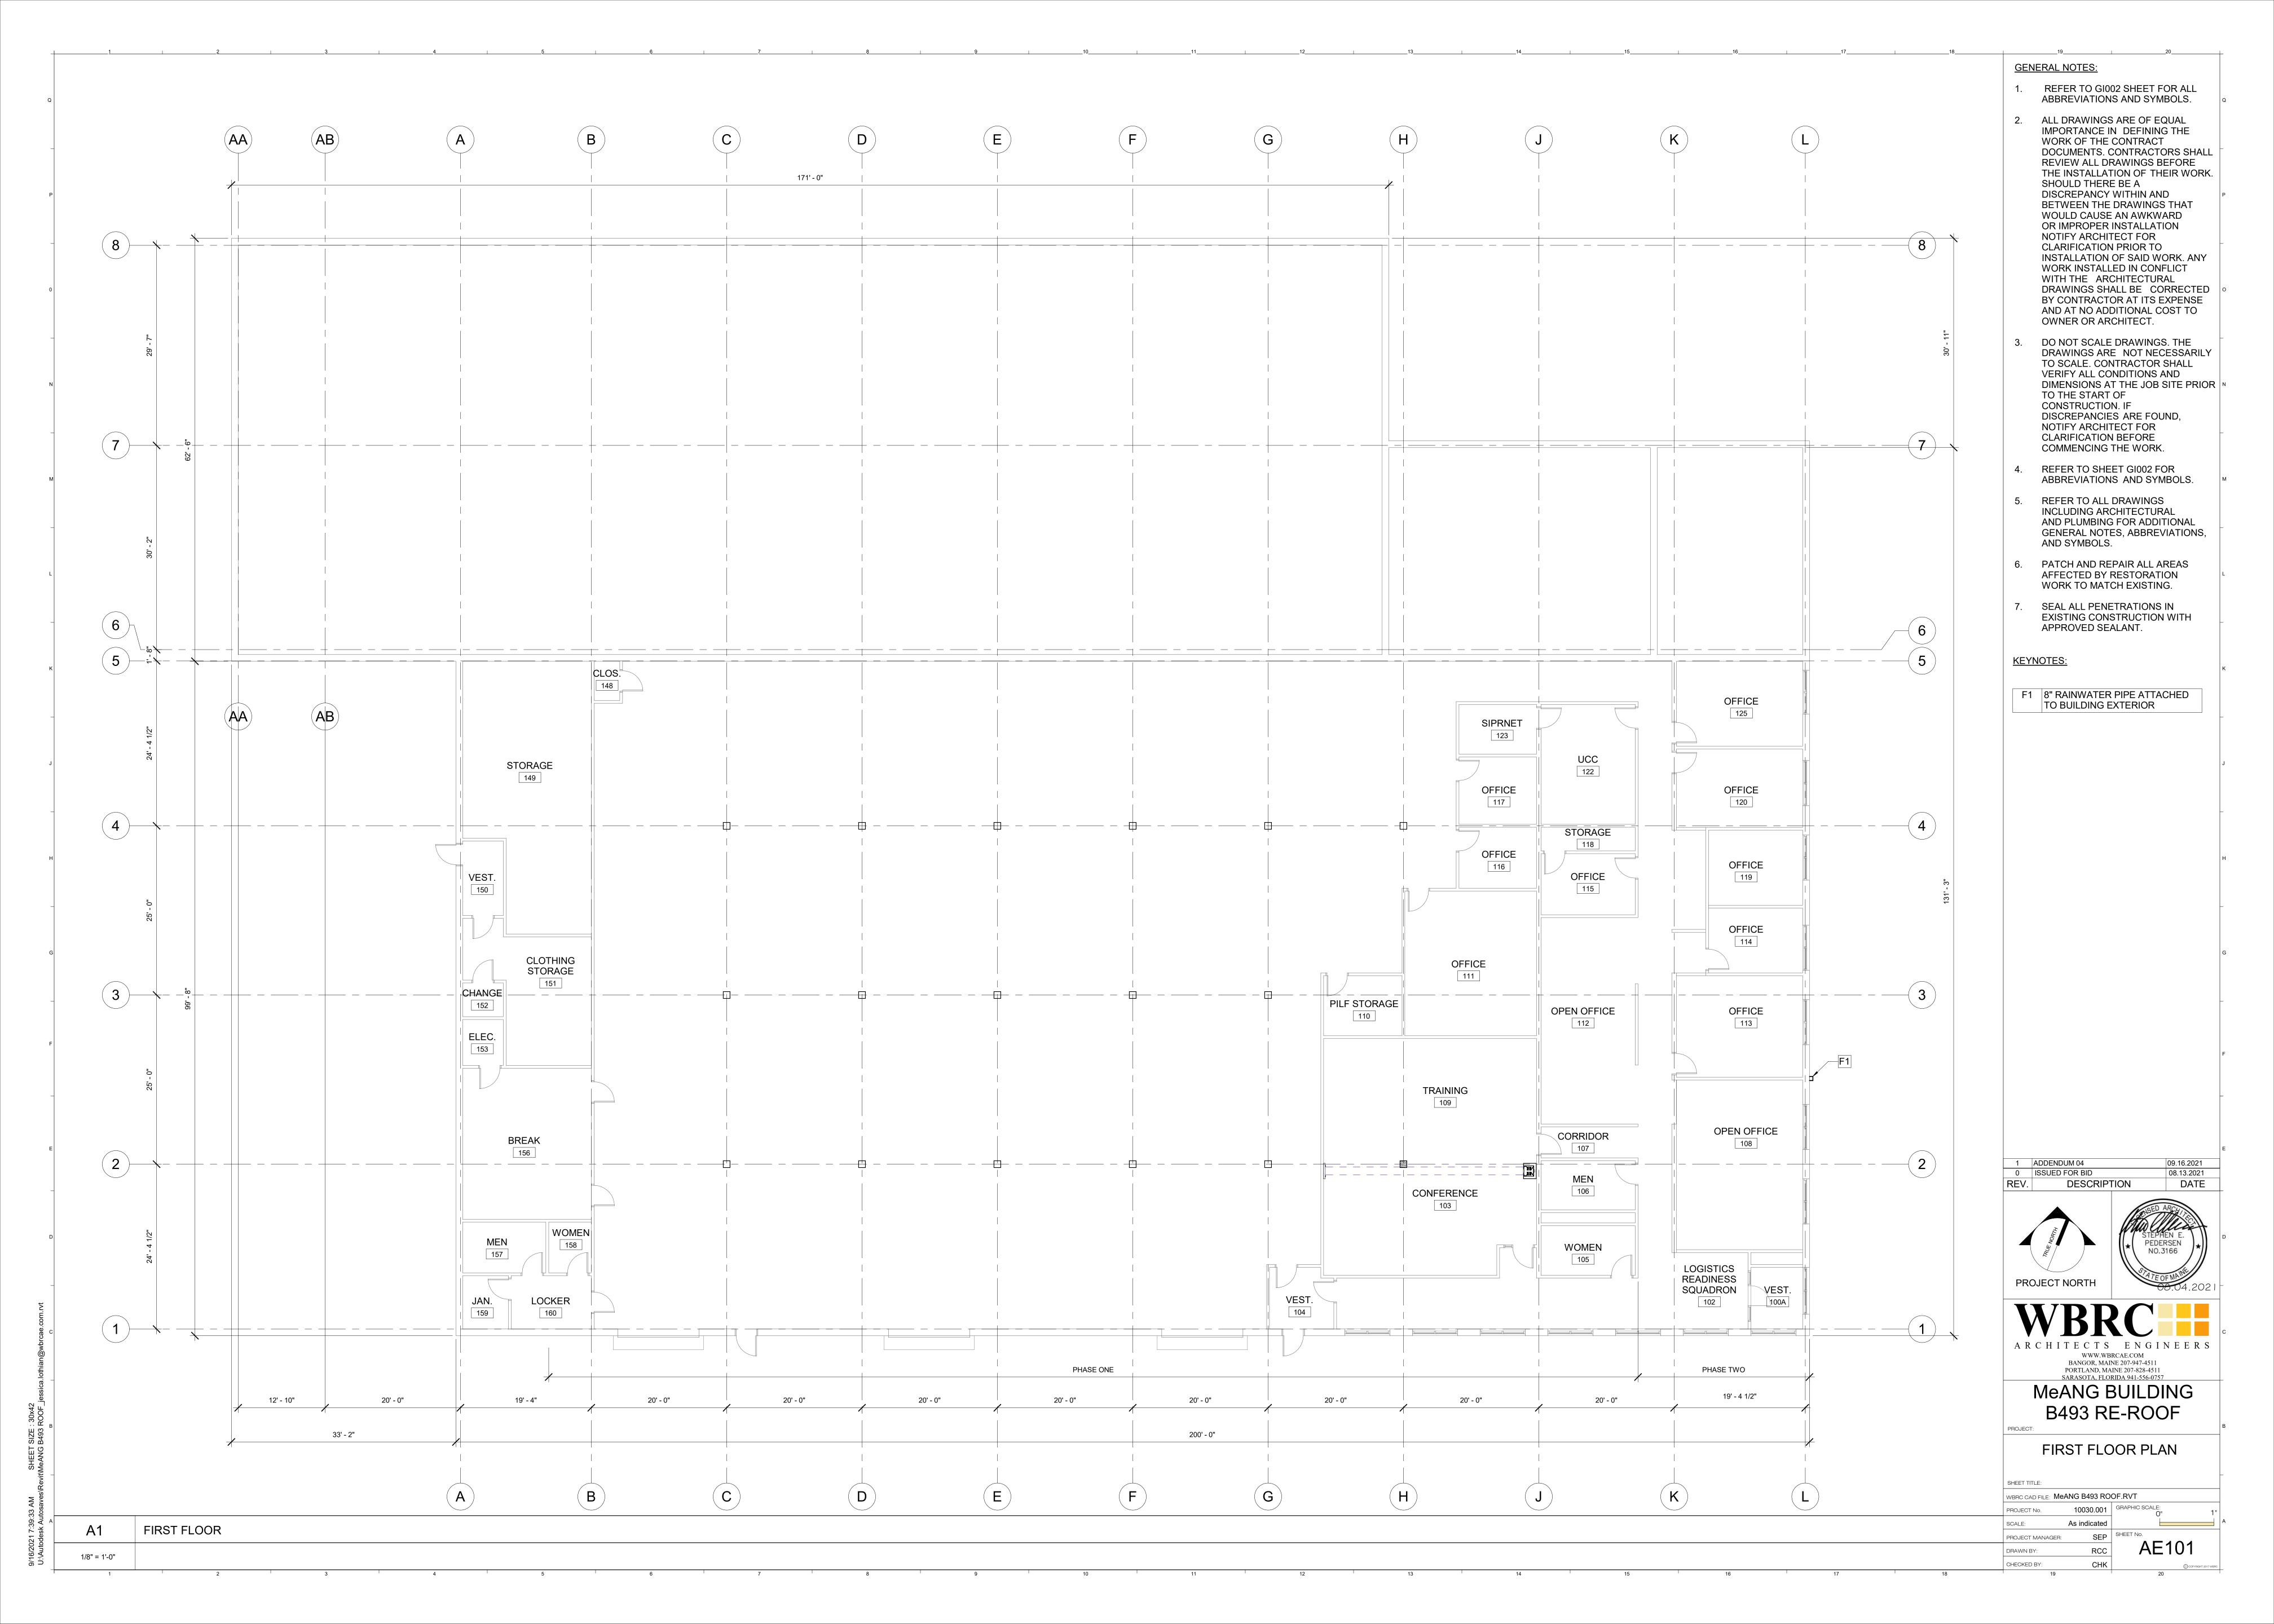

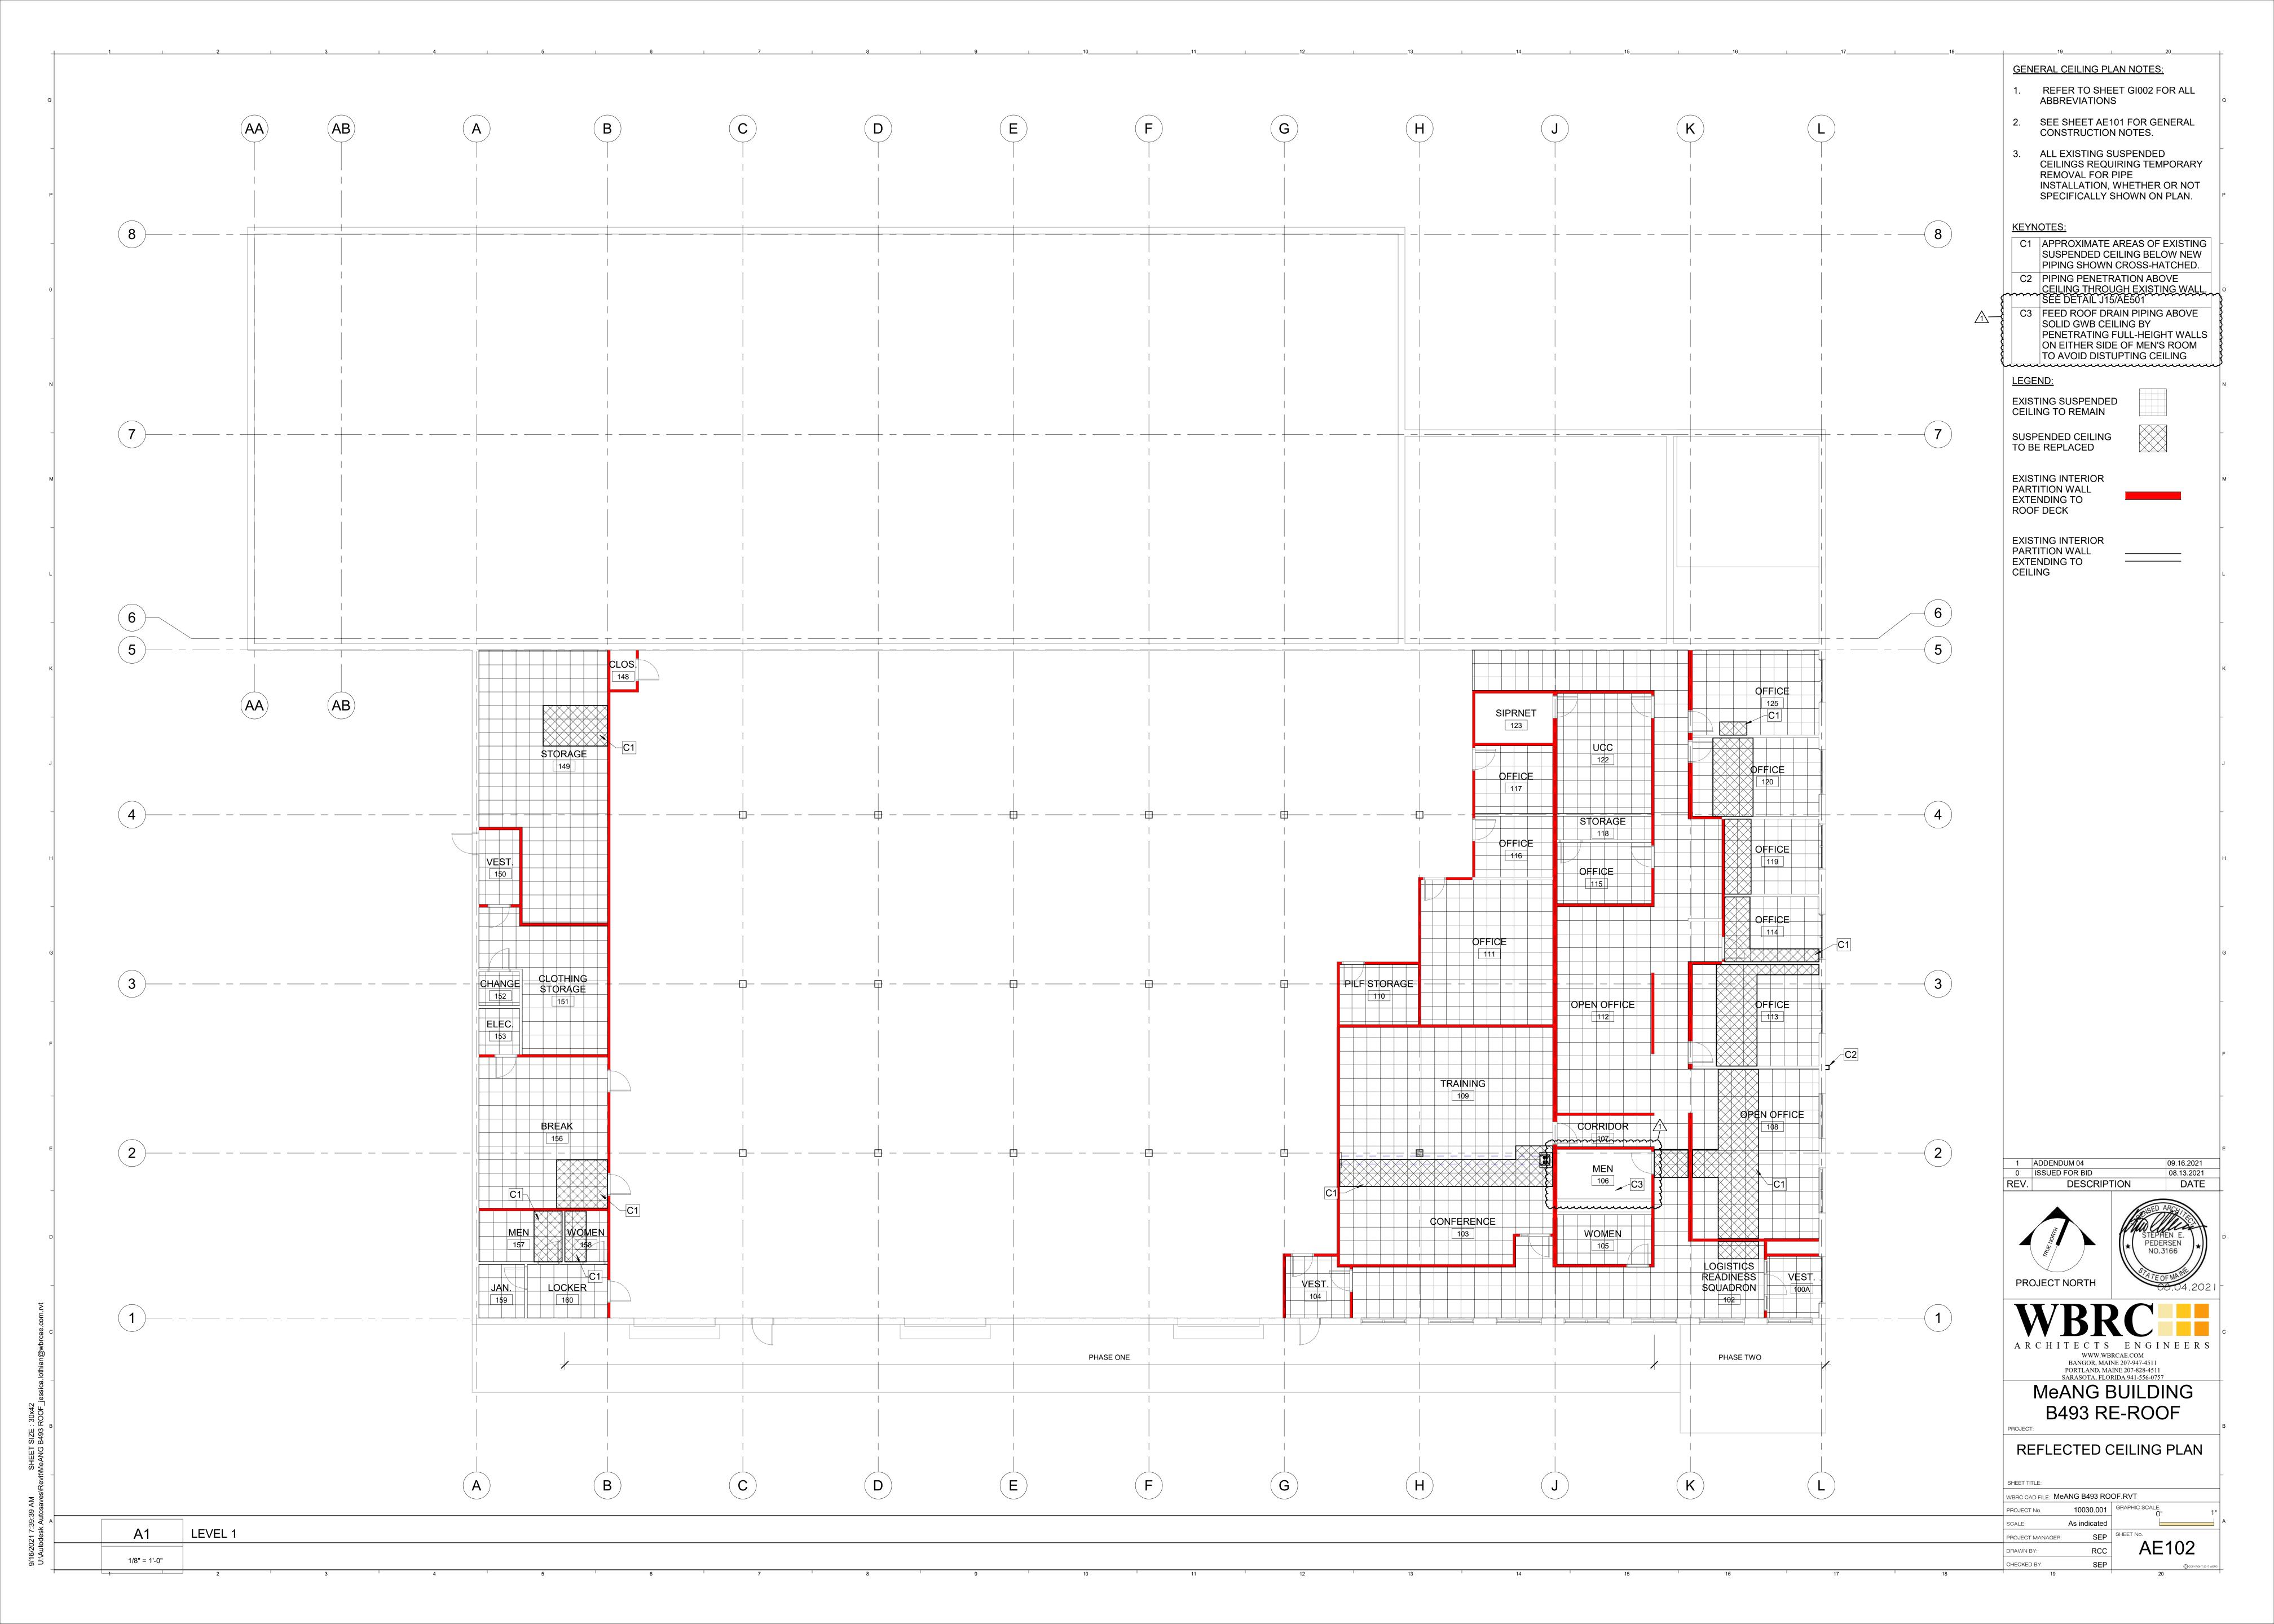


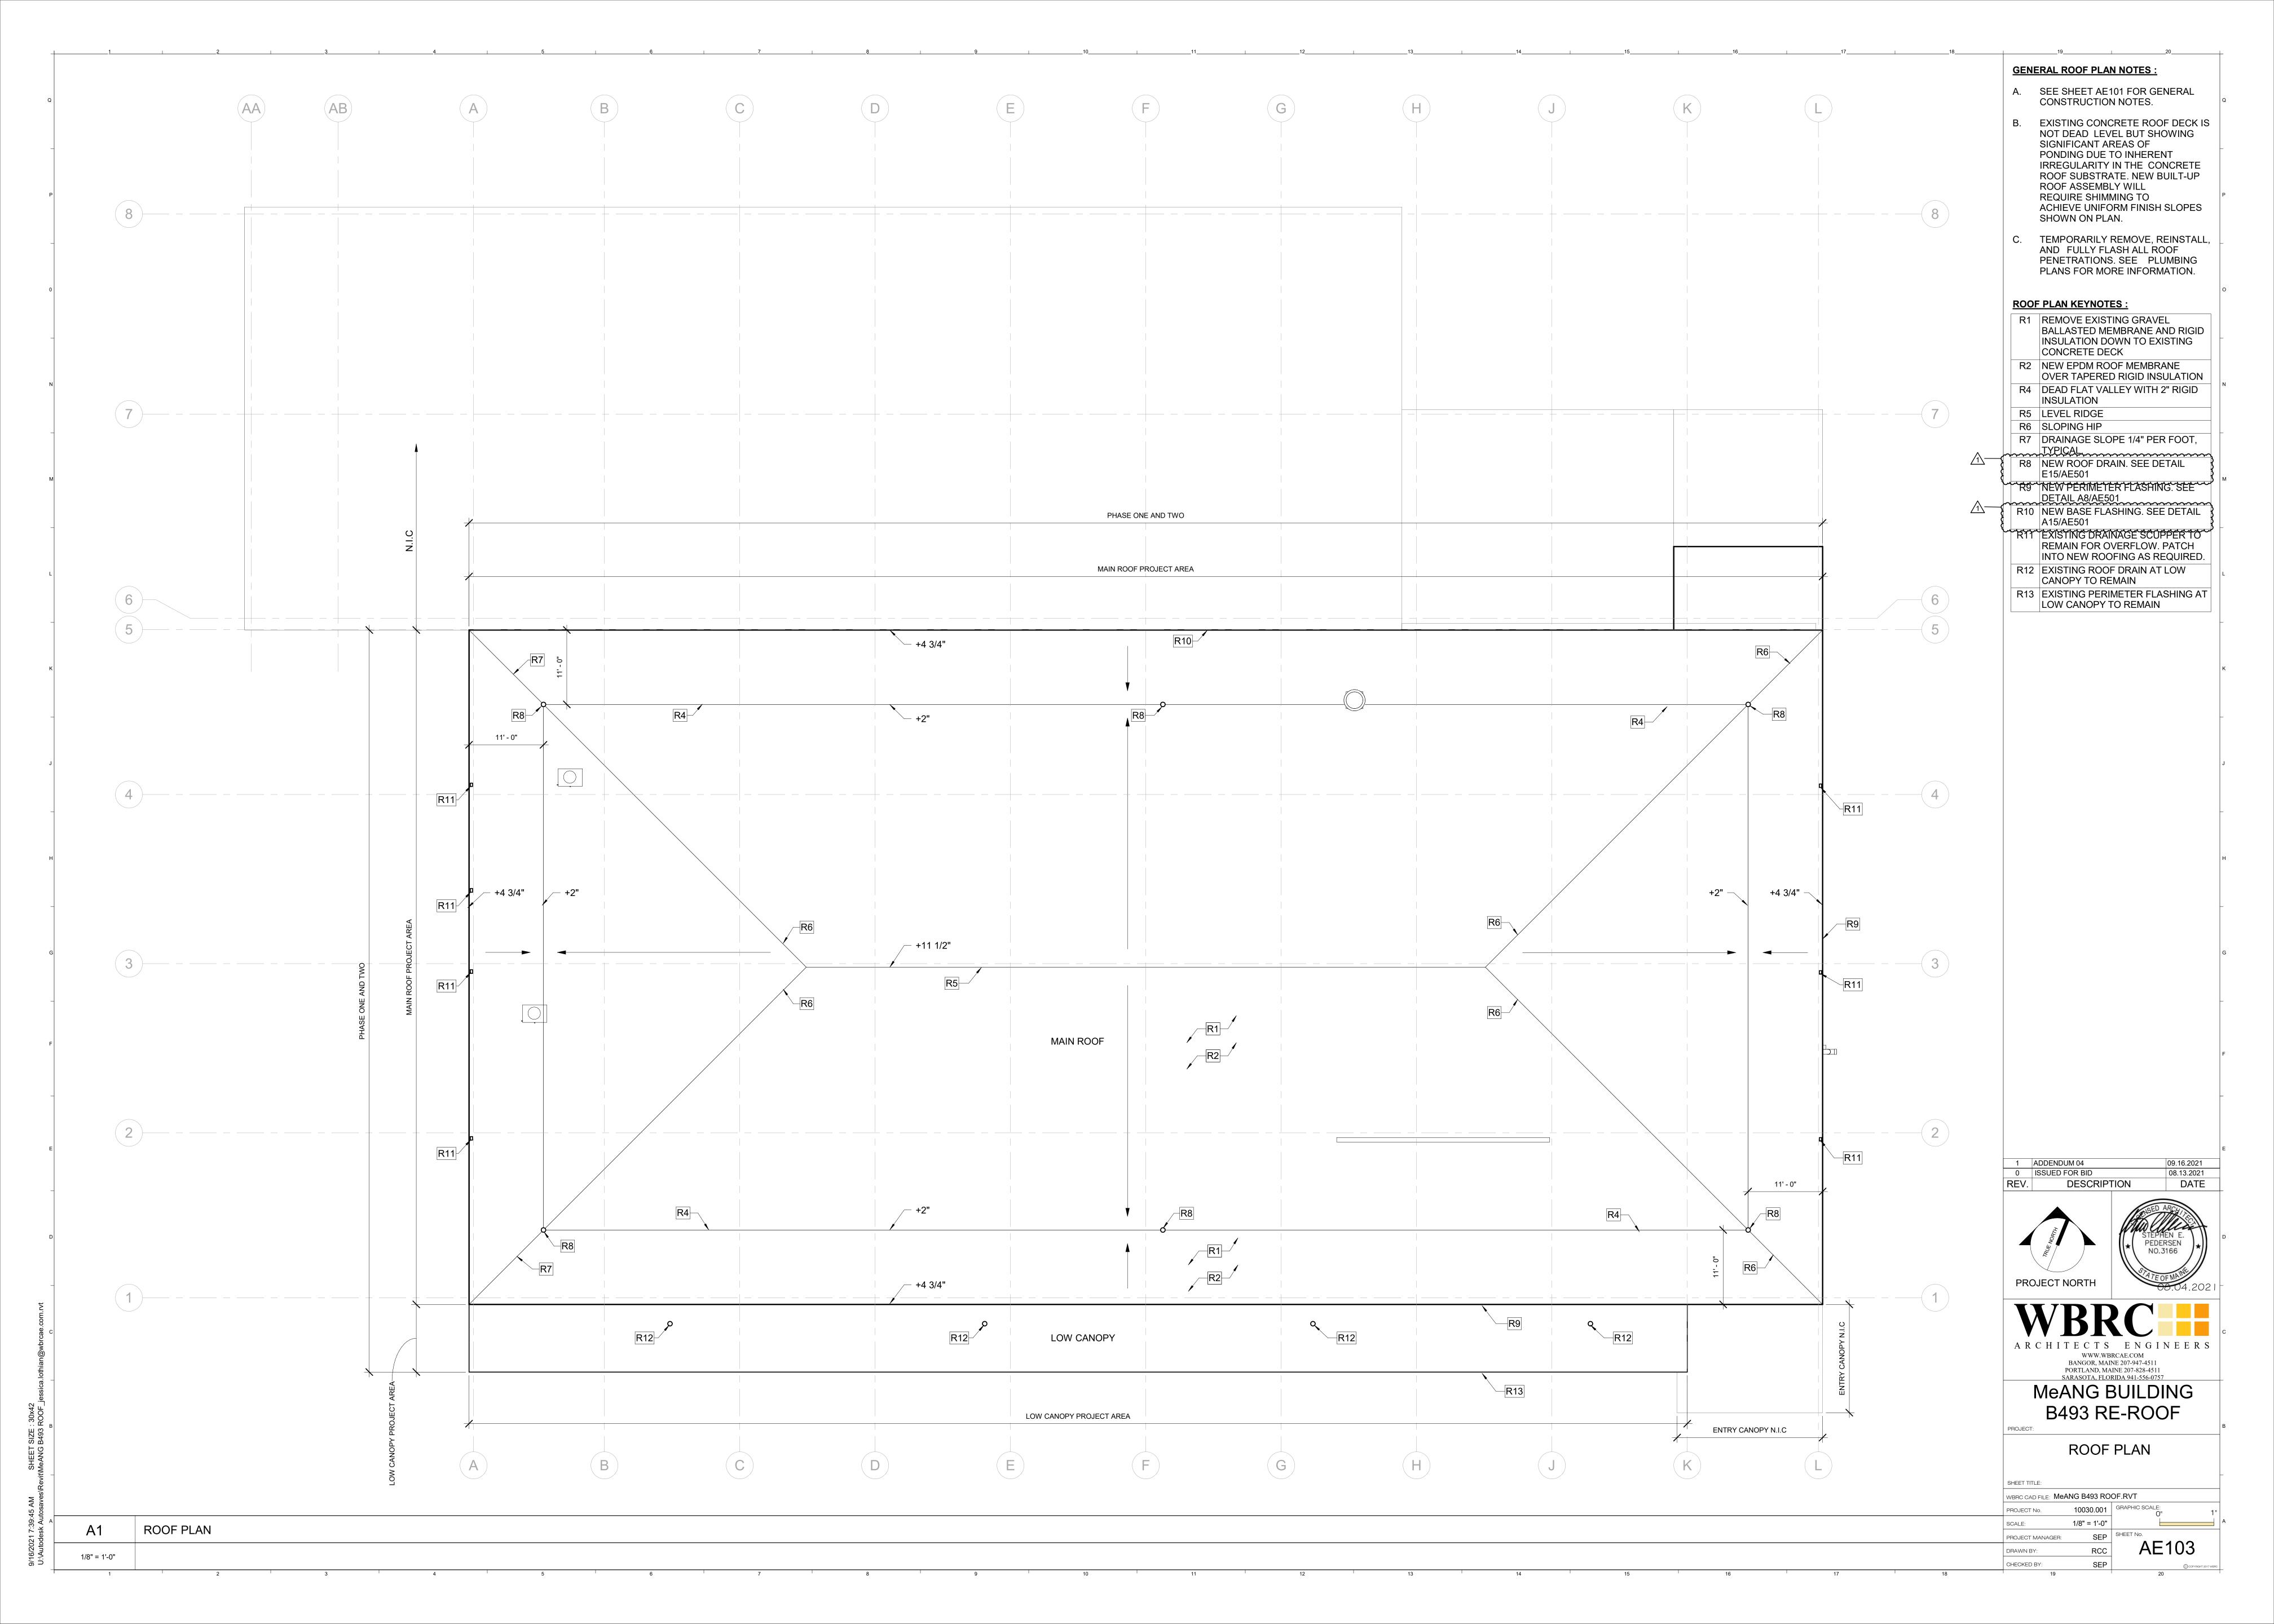

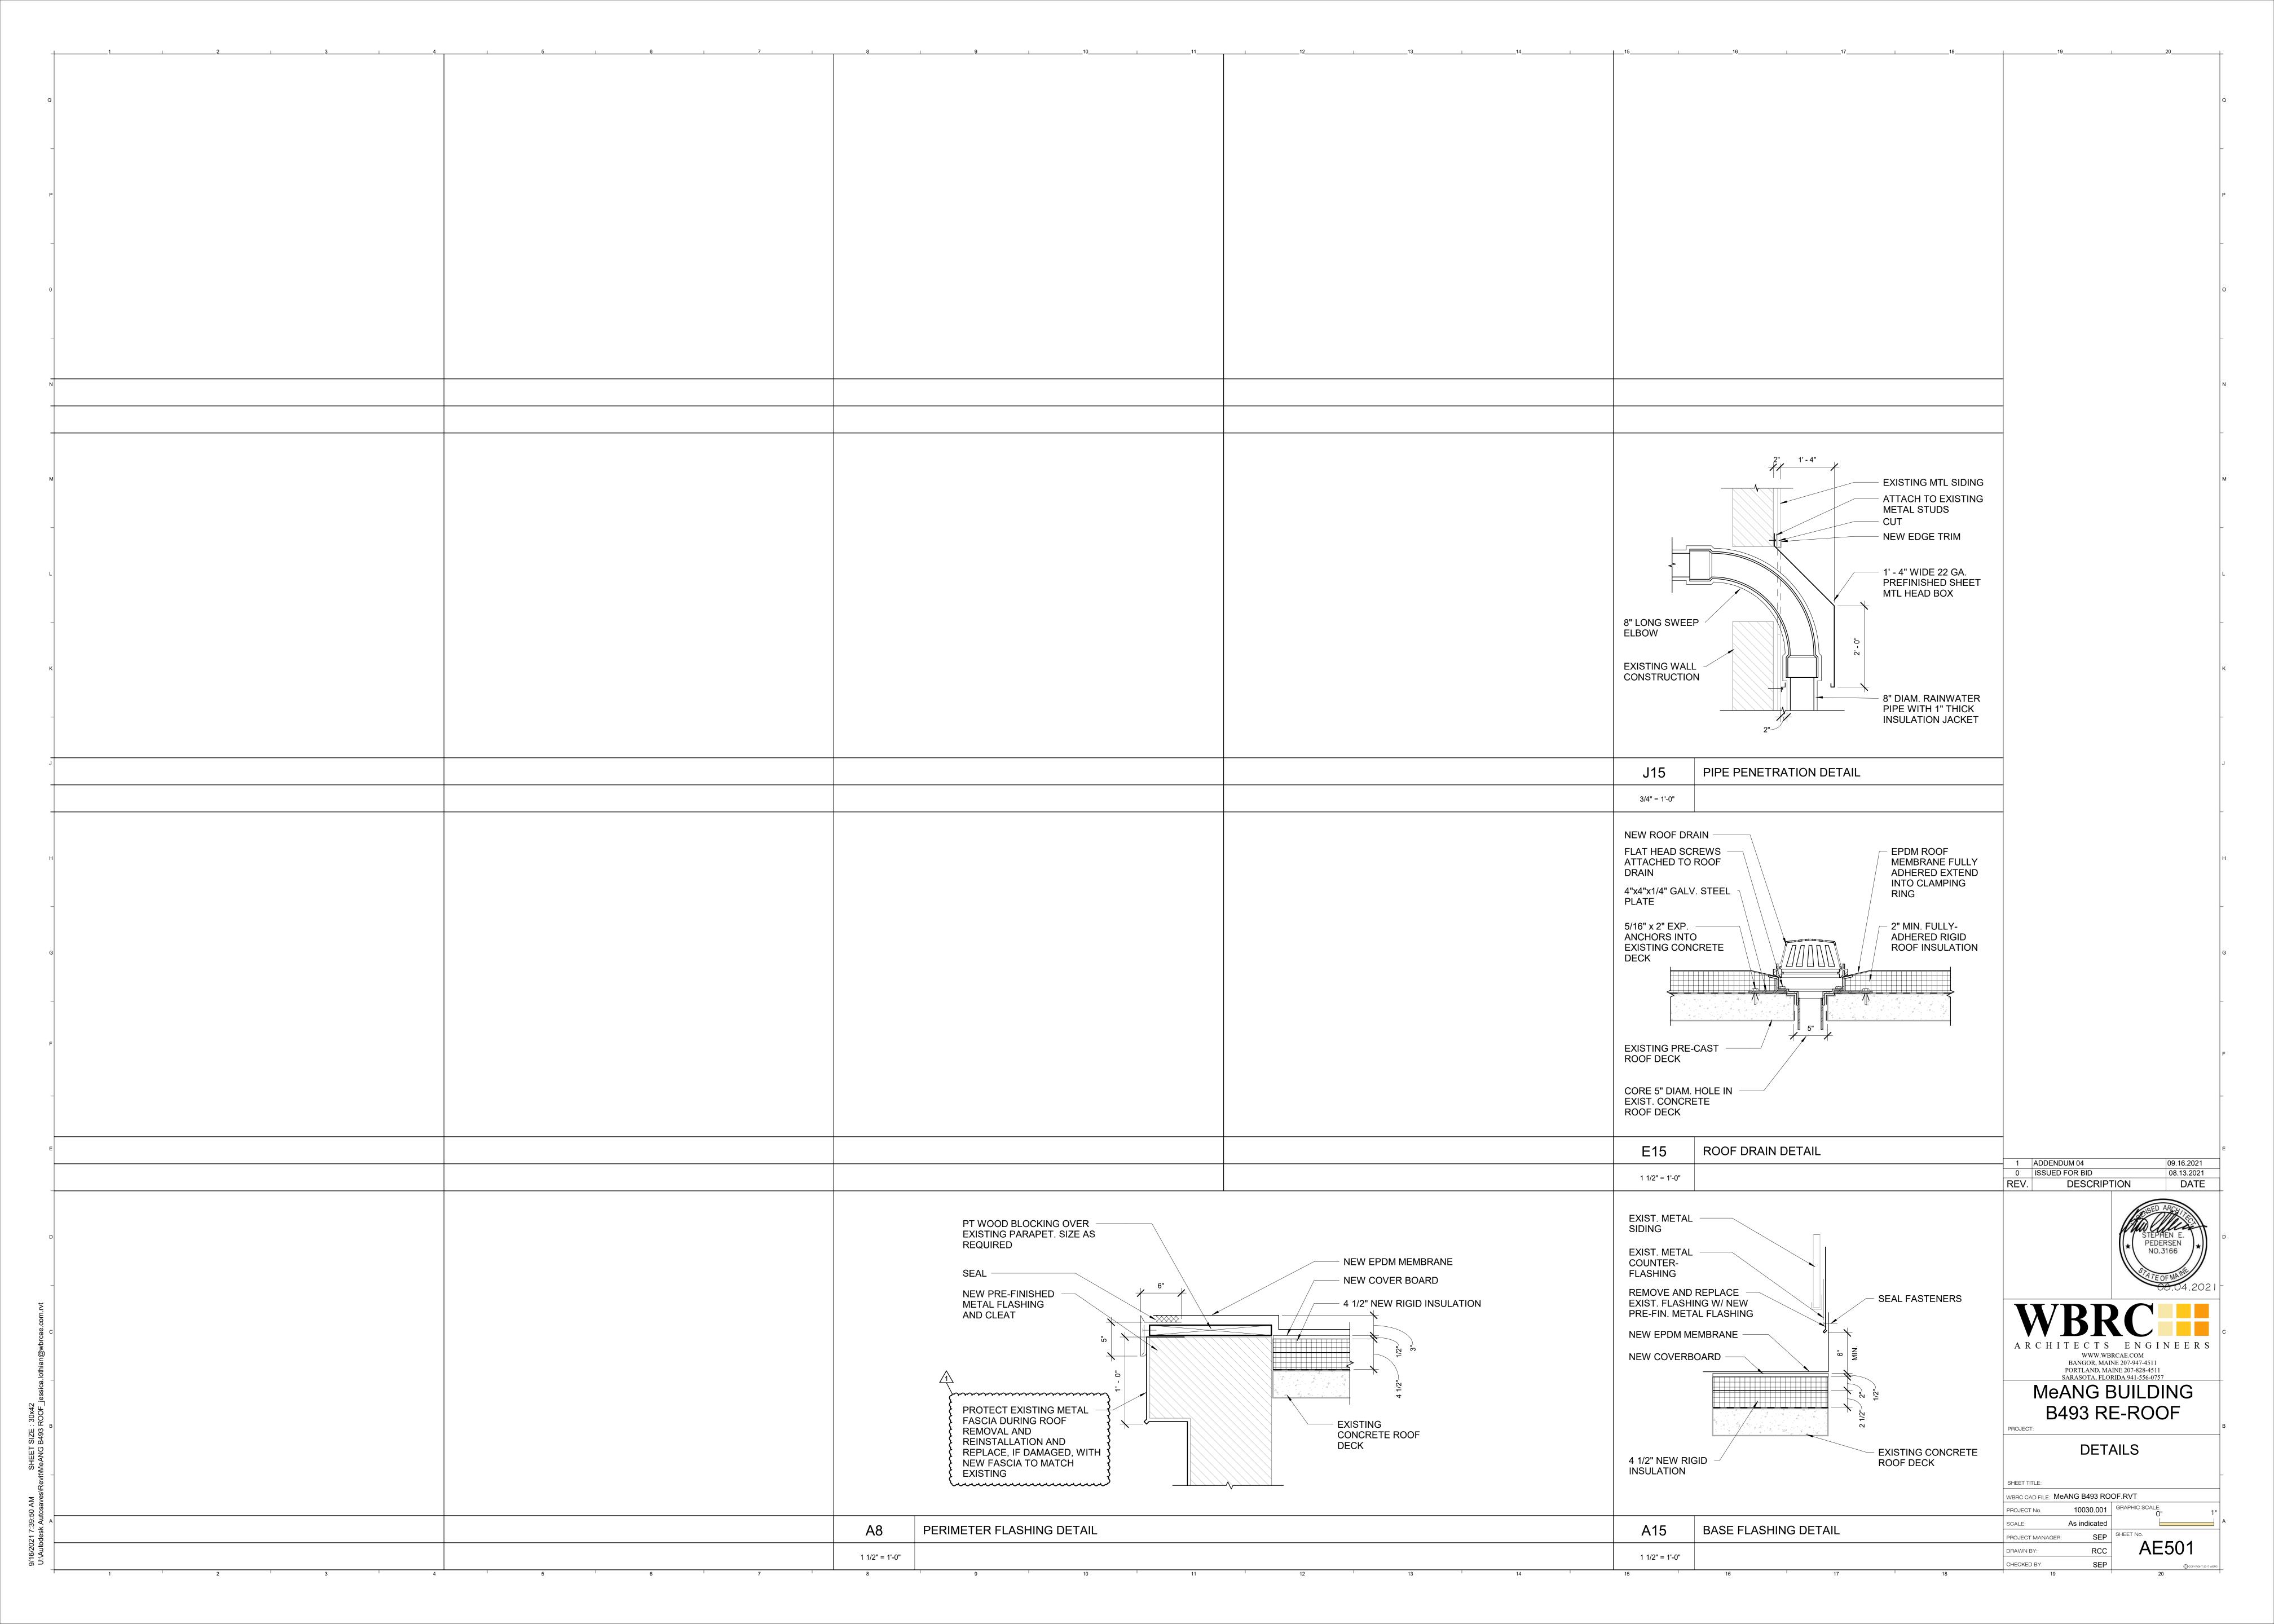

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GPH GALLONS PER HOUR TP TRAP PRIMER TEMPERATURE & PRESSURE RELIEF VALVE TYP. TYPICAL HP HORSE POWER HOT WATER RECIRCULATION HWT HOT WATER TANK WC WATER CLOSET IN INCHES R EXISTING TO BE REMOVED TYP. TRAP PRIMER TEMPERATURE & TEMPERATURE & PRESSURE RELIEF VALVE TYP. TYPICAL UR URINAL WALL BOX WATER CLOSET WH WALL HYDRANT RR EXISTING TO BE REMOVED	FT	FEET	SK	SINK
GPM GALLONS PER MINUTE GWH GAS WATER HEATER TYP. TYPICAL HP HORSE POWER HOT WATER RECIRCULATION HWT HOT WATER TANK WC WATER CLOSET IN INCHES WH WALL HYDRANT R EXISTING TO BE REMOVED T&P PRESSURE RELIEF VALVE TYP. TYPICAL UR URINAL WALL BOX WATER CLOSET WH WALL HYDRANT RR EXISTING TO BE REMOVED	GAL.	GALLONS	SP	SUMP PUMP
GPM GALLONS PER MINUTE GWH GAS WATER HEATER TYP. TYPICAL HP HORSE POWER HOT WATER RECIRCULATION HWT HOT WATER TANK WC WATER CLOSET IN INCHES WH WALL HYDRANT R EXISTING TO BE REMOVED RR EXISTING TO BE RELOCATED	GPH	GALLONS PER HOUR	TP	TRAP PRIMER
HP HORSE POWER UR URINAL HWR HOT WATER RECIRCULATION WB WALL BOX HWT HOT WATER TANK WC WATER CLOSET IN INCHES WH WALL HYDRANT R EXISTING TO BE REMOVED RR EXISTING TO BE RELOCATED	GPM	GALLONS PER MINUTE	T&P	
HWR HOT WATER RECIRCULATION WB WALL BOX HWT HOT WATER TANK WC WATER CLOSET IN INCHES WH WALL HYDRANT R EXISTING TO BE REMOVED RR EXISTING TO BE RELOCATED	GWH	GAS WATER HEATER	TYP.	TYPICAL
HWT HOT WATER TANK WC WATER CLOSET IN INCHES WH WALL HYDRANT R EXISTING TO BE REMOVED RR EXISTING TO BE RELOCATED	HP	HORSE POWER	UR	URINAL
IN INCHES WH WALL HYDRANT R EXISTING TO BE REMOVED RR EXISTING TO BE RELOCATED	HWR	HOT WATER RECIRCULATION	WB	WALL BOX
R EXISTING TO BE REMOVED RR EXISTING TO BE RELOCATED	HWT	HOT WATER TANK	WC	WATER CLOSET
EVICTING DELOCATED	IN	INCHES	WH	WALL HYDRANT
ER EXISTING RELOCATED	R	EXISTING TO BE REMOVED	RR	EXISTING TO BE RELOCATED
	ER	EXISTING RELOCATED		

	Р	LUMBING SYMBOLS & ABBRE	EVIATIONS	
SYMBOL	ABV.	DESCRIPTION	EXISTING TO REMAIN	EXISTING TO BE REMOVED
	– HW	HOT WATER PIPING	EHW-	→× — EHW— × —
—TW—— —	– TW	TEPID HOT WATER PIPING (TEMP IN °F)	ETHW-	—× —ETHW— ×—
	- HWR	HOT WATER RETURN PIPING	EHWR	— × —EHWR— ×—
	- CW	COLD WATER PIPING	ECW-	—× —ECW— ×—
CO2	CO2	CARBON DIOXIDE PIPING	ECO2-	→× — ECO2 — × —
-VAC	- VAC	VACUUM PIPING	EVAC-	— x —EVAC— x —
-CA	- CA	COMPRESSED AIR PIPING	ECA-	—× —ECA— ×—
	- W	SANITARY WASTE PIPING	EW_	—× —EW— ×—
	- w	SANITARY WASTE PIPING BELOW SLAB	EW_	—× —EW— ×—
	- V	VENT PIPING	EV_	-×EV ×
CD	- CD	CONDENSATE PIPING	ECD-	—× —ECD— ×—
G	- G	NATURAL GAS PIPING	EG	—× —EG— ×—
RW-	- RW	RAINWATER PIPING	ERW-	→× —ERW— ×—
— RW— —	- RW	RAINWATER PIPING BELOW SLAB	ERW-	→ —ERW— ×—
	_	PIPE TURNING UP	LIVV	A LIW A
<u> </u>		PIPE TURNING DOWN		
-co4		FLOOR CLEANOUT	EECOA	EECO A
-CO 	_		EFCO -	EFCO —×—
COI	_	WALL OR END OF LINE CLEANOUT EQUIPMENT FIXTURE NUMBER -	ECO	ECO I X
<u>E-1</u> <u>P-5</u>		REFER TO PLUMBING FIXTURE SCHEDULE PLUMBING FIXTURE NUMBER - REFER TO EQUIPMENT FIXTURE SCHEDULE		
O FD		FLOOR DRAIN	□ FD-E	☐ FD-R
RD		ROOF DRAIN	RD-E	⊠ RD-R
		SHUT-OFF VALVE	E	R
		BALANCING VALVE	E	— — R —
		CHECK VALVE	E	R
	B.I.P.	BLACK IRON PIPE		
	2	PLUMBING FIXTURE CONNECTION		
	VTR	VENT THRU ROOF	VTR-E	
	V.I.F.	VERIFY IN FIELD	VIII-L	
<u> </u>	V.I.F.	BACKFLOW PREVENTER		
	-	DOMESTIC WATER HEATER		
<u>DWH</u>		TECHNICAL NOTE, PERTAINS ONLY TO T	<u>DWH-E</u> HE	DWH-R
	TO	SHEET ON WHICH IT APPEARS. TRAP PRIMER		
(TP)	TP	TRAP PRIMER DISTRIBUTION UNIT	(TP) _E	
(DU) WHA	DU		^(DU) E	
	WHA	WATER HAMMER ARRESTOR		
•		NEW TO EXISTING CONNECTION		
	NP	NON-POTABLE		
	RODI	REVERSE OSMOSIS DEIONIZED WATER		
	NPCW	NON-POTABLE COLD WATER		
	NPHW	NON-POTABLE HOT WATER		

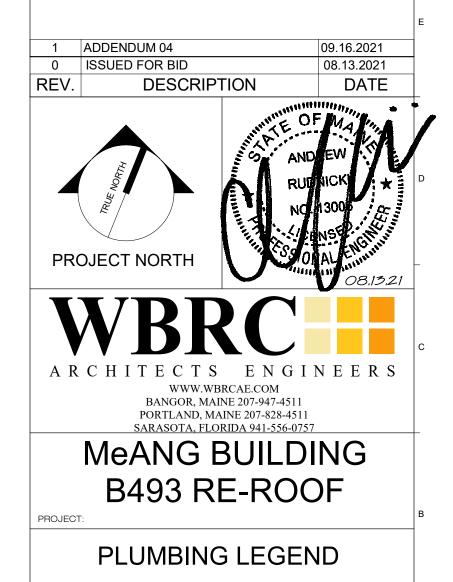

PLUMBING LEGEND

WBRC CAD FILE: MeANG B493 ROOF.RVT

PROJECT No. 10030.001 GRAPHIC SCALE:

O"

SCALE: 1/4" = 1'-0"

PROJECT MANAGER: SEP SHEET No.

DRAWN BY:

CHECKED BY:

SEP SHEET NO.

SRJ PL001

AJR

