

# MAINE CRIMINAL JUSTICE ACADEMY MASONRY RESTORATION CONNECTORS AND ENTRANCES

# **GENERAL NOTES**

### QUALITY CONTROL NOTES

AREAS AND QUANTITIES INDICATED ON THE DRAWINGS ARE APPROXIMATES, FIELD VERIFY ALL DIMENSIONS. MASONRY CONTRACTOR TO CARRY QUANTITIES AND SQUARE FOOTAGES SUFFICIENT TO COMPLETE THE INDICATED TASK

BASIS OF DESIGN

THIS PROJECT IS DEEMED TO BE TREATED AS AN HISTORIC STRUCTURE. ITS PLANNED TREATMENT, AS IT RELAT O THE REPAIR, RESTORATION, AND REBUILD, WILL IN SO FAR AS PRACTICAL AND APPROVED BY THE A/E OF REC, PRESERVE, REINCORPORATE ORIGINAL BUILDING ELEMENTS, PROVIDE NEW ELEMENTS, AND ASSEMBLIES, THAT WILL MAINTAIN THE BUILDING'S ORIGINAL CHARACTER, MATERIALITY, DIMENSION, COLOR AND OVERALL

#### GENERAL NOTES

. CONTRACTOR TO VERIFY ALL DIMENSIONS, RELATIVE DATUMS, QUANTITIES, SIZES AND CONTEXT OF DESIGN TO FIELD CONDITIONS. NOTIFY A/E OF ANY CONFLICTS

2. SCOPE OF WORK - DESIGN OF DETAILING BASED ON LIMITED ACCESS / INFORMATION PROVIDED - CONTRACTOR TO EXPOSE WORK AREA - NOTIFY ARCHITECT OF EXPANDED ACCESS FOR REVIEW AND REVISION OF DETAILS.

3. ELEVATIONS PRESENT CONDITIONS AS "VISIBLE IN PLANE" IN SELECT LOCATIONS, TRANSITIONS OCCUR BETWEEN VARYING MATERIALS AT ANGLES NOT CLEAR TO VIEW - REFER TO PHOTOS AND OR SITE VISIT - ALSO REFER QUESTIONS TO A/E OF RECORD.

4. A/E OF RECORD TO APPROVE REMOVAL OF ALL STRUCTURAL PRIOR TO DEMOLITION. CONTRACTOR TO NOTIFY A/E OF RECORD WHEN WORK AREA IS EXPOSED FOR REVIEW.

5. CONTRACTOR TO USE CARE AND CONTROL DURING SELECT DEMOLITION OF THE WORK AREA LIMITING IMPACT TO ADJACENT SURFACES, SUBSTRATES, ANCHORING / CONNECTIONS RELATED TO CUTTING /PATCHING/MATCHING TO EXISTING AND REATTACHMENTS, IN SO FAR AS PRACTICAL.

. ALL DEMOLISHED AREA SURFACES TO REMAIN PREPARE SUBSTRATE TO BE CLEAN / CLEAR/PLUMB/LEVEL/FLAT, ETC. IN SO FAR AS PRACTICAL, AND FREE OF ANY OBSTRUCTIONS, AND INSPECTED BY A/E PRIOR TO RECEIVING NEW WORK.

EXISTING CONDITIONS TO RECEIVE NEW WORK TO BE INSTALLED IN ACCORDANCE WITH MANUFACTURERS REQUIREMENTS FOR NEW WORK FOR PROPER SUBSTRATE ATTACHMENT.

8. CONTRACTOR TO PROTECT ALL EXISTING MATERIALS REMOVED FOR PLANNED REINSTALLATION, WITH SAFE STORAGE AGAINST THEFT/VANDALISM/ UNDUE WEATHERING/ ACCIDENTAL DROP /COLLISION ETC.

I. ALL REPAIR WORK WILL BE COMPLETED IN ACCORDANCE WITH CURRENT PRACTICES IN THE CONSTRUCTION INDUSTRY, ALL NATIONAL, STATE, LOCAL BUILDING CODES INCLUDING, BUT NOT LIMITED TO, THE MAINE STATE BUILDING CODES, THE LATEST EDITIONS OF ICC CODES / IBC/IEBC, NFPA 101, ANSI ,OSHA AND OTHER SAFETY REGULATIONS.

2. EXISTING BUILDING COMPONENTS WHICH ARE AFFECTED BY NEW WORK AND DEMOLITION, OR WHICH MAY BE DAMAGED BY THE CONTRACTOR OR ANY SUBCONTRACTORS SHALL BE REPLACED OR RESTORED TO ORIGINAL CONDITION AND FINISH BY METHODS DESCRIBED IN THIS CONTRACT OR AS APPROVED BY LEMESSURIER.

3. CONTRACTOR SHALL VERIFY EXISTING MEP CONDITIONS. VERIFY IF MEP COMPONENTS ASSEMBLIES, ECT WILL BE AFFECTED IN WORK AREA - NOTIFY A/E OF RECORD PRIOR TO COMMENCING WORK.

4. CONTRACTOR IS RESPONSIBLE FOR ANY SHORING AND SUPPORTING ENGINEERING AND DESIGN FOR AREAS DESIGNATED "REBUILD". CONTRACTOR MUST SUBMIT SHORING PLAN S PREPARED BY DESIGN PROFESSIONALS, 15 DAYS , PRIOR TO COMMENCING WITH WORK.

5. USE NECESSARY MEANS TO PROTECT ALL EXPOSED BUILDING AREAS FROM DAMAGE CAUSED BY WEATHER EVENTS OR OTHER ENVIRONMENTAL SITUATIONS DURING THE CONSTRUCTION PROCESS UNTIL THE REPAIR WORK IS DEEMED WEATHER-TIGHT.

# PROJECT SPECIFICATIONS

#### PRODUCTS

CONTRACTOR AND OR SUB-CONTRACTORS MUST SUBMIT MSDS SHEETS AND SHOP DRAWINGS FOR ALL MATERIAI USED FOR CONSTRUCTION WORK FOR APPROVAL PRIOR TO THE START OF WORK. ALL PRODUCT SUBMITTALS MUST HAVE A COVER SHEET INDICATING THAT IT IS A

SUBMITTAL AND ALL THE PERTINENT DATA NEEDED TO BE EVALUATED. ISIDERED COMPLETE WHEN REVIEWED AND STAMPED BY CONTRACTOR'S PROJECT MANAGE

UBMISSION. LEMESSURIER WILL REVIEW, AND COMMENT AS RELATED TO THE OVERALL DESIGN INTENT AND NOT FOR STYLE, COLOR OR DIMENSIONAL ACCURACY. CONTRACTO S RESPONSIBLE FOR THE ACCURACY OF THE TERM

"MATCH EXISTING" AND WILL BE EXPECTED TO PROVIDE TO THIS LEVEL OF "STANDARD OF CARE". A SUBSTITUTION I NOT A SUBMITTAL. A SUBSTITUTION REQUEST MUST HAVE A COVER SHEET INDICATING IT IS A "REQUEST FOR SUBSTITUTION". ALL PERTINENT DATA FOR THE SUBSTITUTED

PRODUCT AND THE SPECIFIED PRODUCT MUST BE PART OF THE REQUEST. A REQUEST MADE WITHOUT ALL THE INFORMATION INDICATED WILL BE REJECTED. REQUESTS FOR SUBSTITUTION WILL HAVE A MINIMUM OF TWO WEEKS FOR REVIEW.

#### BASIS OF DESIGN MANUFACTURERS:

REPLACEMENT BRICK: ARE TO MATCH EXISTING. BRICKS WITH UNUSED LUGS ARE TO BE REPLACED (DO NOT PATC OR BROKEN BRICK TO BE REPLACED IN ALL LOCATIONS, IF CIRCUMSTANCES MAKE REMOVAL DETRIMENTAL TO ADJACENT AREAS, DISCUSS WITH LEMESSURIER BEFORE PL

CONTRACTOR TO CARRY 2500 REPLACEMENT BRICK UNIT ALLOWANCE

- PROVIDE A UNIT PRICE IN BIDDING FOR BRICK REPLACEMENT. (PRO RATED) STORE ALL MASONRY MATERIAL AS PER THE RECOMMENDATIONS OF THE BRICK INDUSTRY ASSOCIATION AND THE INSTITUTE OF AMERICA.

# MORTAR- BASE BID IS PROPORTIONALLY MIXED TYPE "N"

CONTRACTOR IS RESPONSIBLE FOR MORTAR SAMPLE REMOVAL AND TESTING. MORTAR SAMPLES ARE TO BE GATHERED BY CONTRACTOR AT INDICATED AREAS OF DESTRUCTIVE INVESTIGATION (APPROVED MORTAR RECIPE WILL BE SUBJECT TO FINDINGS FROM THE MORTAR SAMPLE TESTING.) CONTRACTOR TO MATCH ORIGINAL MORTAR COLOR, TEXTURE AND COMPOSITION.

ENSURE ALL MORTAR INGREDIENTS ARE FRESH WITH DOCUMENTED DATES OF MANUFACTURE SUBMITTED TO LEM APPROVAL.

NO LIME OR CEMENT PRODUCTS INCLUDING PATCHING MORTAR SHALL BE OLDER THAN 6 MONTHS FROM TIME OF

1 PART CEMENT.1 PART HYDRATED LIME, 6 PARTS SHARP SAND.

TYPE "N" POINTING MORTAR RECIPE:

# MASONRY WATER REPELLENT (FOR BRICK WATER TABLE ONLY)

MASONRY WATER REPELLENT- PROTECTOSIL CHEM-TRETE PB100

- APPLY WATER REPELLANT TO ALL INDICATED MASONRY AFTER WORK AND WASHING IS COMPLETE

#### ALLOWANCES


CONTRACTOR TO CARRY 500 REPLACEMENT BRICKS FOR EACH BRICK PROFILE . REPLACEMENT BRICKS ARE TO MATCH EXISTING LIKENESS AND KIND.

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LS GER TOR <u>N IS</u>	SUNABRA C1 BE1 BE2 BE3 BE4	COVER SHEET, LEGEND, SPECIFICATIONS AND GENERAL NOTES         ENTRANCE 1 PLANS, ELEVATIONS AND LEGEND         ENTRANCE 1 ROOF PLANS, ELEVATIONS AND LEGEND         ENTRANCE 2 PLANS, ELEVATIONS AND LEGEND         DETAILS	SUBMISSION 07/06/22 07/06/22 08/01/22 08/01/22	INE CRIMINAL JUSTICE ACADEMY STORATION   CONNECTORS & ENTRANCES 15 OAK GROVE RD , VASSALBORO , ME 04989	COVER SHEET, LEGEND AND GENERAL NOTES	
ATCH) ALL CRACKED E PROCEEDING. THE MASONRY	APPROV	REQUIRED MOCKUPS ACTOR TO PROVIDE THE FOLLOWING MOCKUPS ON SITE FOR LEMESSURIER (AL PRIOR TO FULL INSTALLATION: T 2 LINEAR FEET - PROVIDE PULL TEST RESULTS SUBMITTAL PRIOR TO WORK	/LOCATIC MAI	DWG NAME COVE		
ion. .emessurier for DF Manufacturing.	MORTAF POINTIN REPLAC REPLAC REPLAC LIME STO MASONF	ER CAP JOINT INSTALLATION R RAKE OUT DEPTH INSPECTION IG MORTAR, JOINT PROFILE ON 2'X2' ON THE BUILDING EMENT BRICK FOR EACH PROFILE EMENT WINDOW SURROUND EMENT LIMESTONE ARCHITECTURAL ELEMENTS ONE PATCH AND REPAIR RY PRE-WASH RY FINAL WASH		NOISSIMANS CIA NOISSIMANS CIA HVC WC WC WC WC WC WC WC WC WC W		
	BUILDIN MULTI W	<u>O ESIGN CRITERIA</u> <u>O TYPE</u> YTHE BRICK MASONRY WITH LIMESTONE ELEMENTS.				
			C1 SCALE: AS NOTED / NTS PROJECT No : 21.0240.001			








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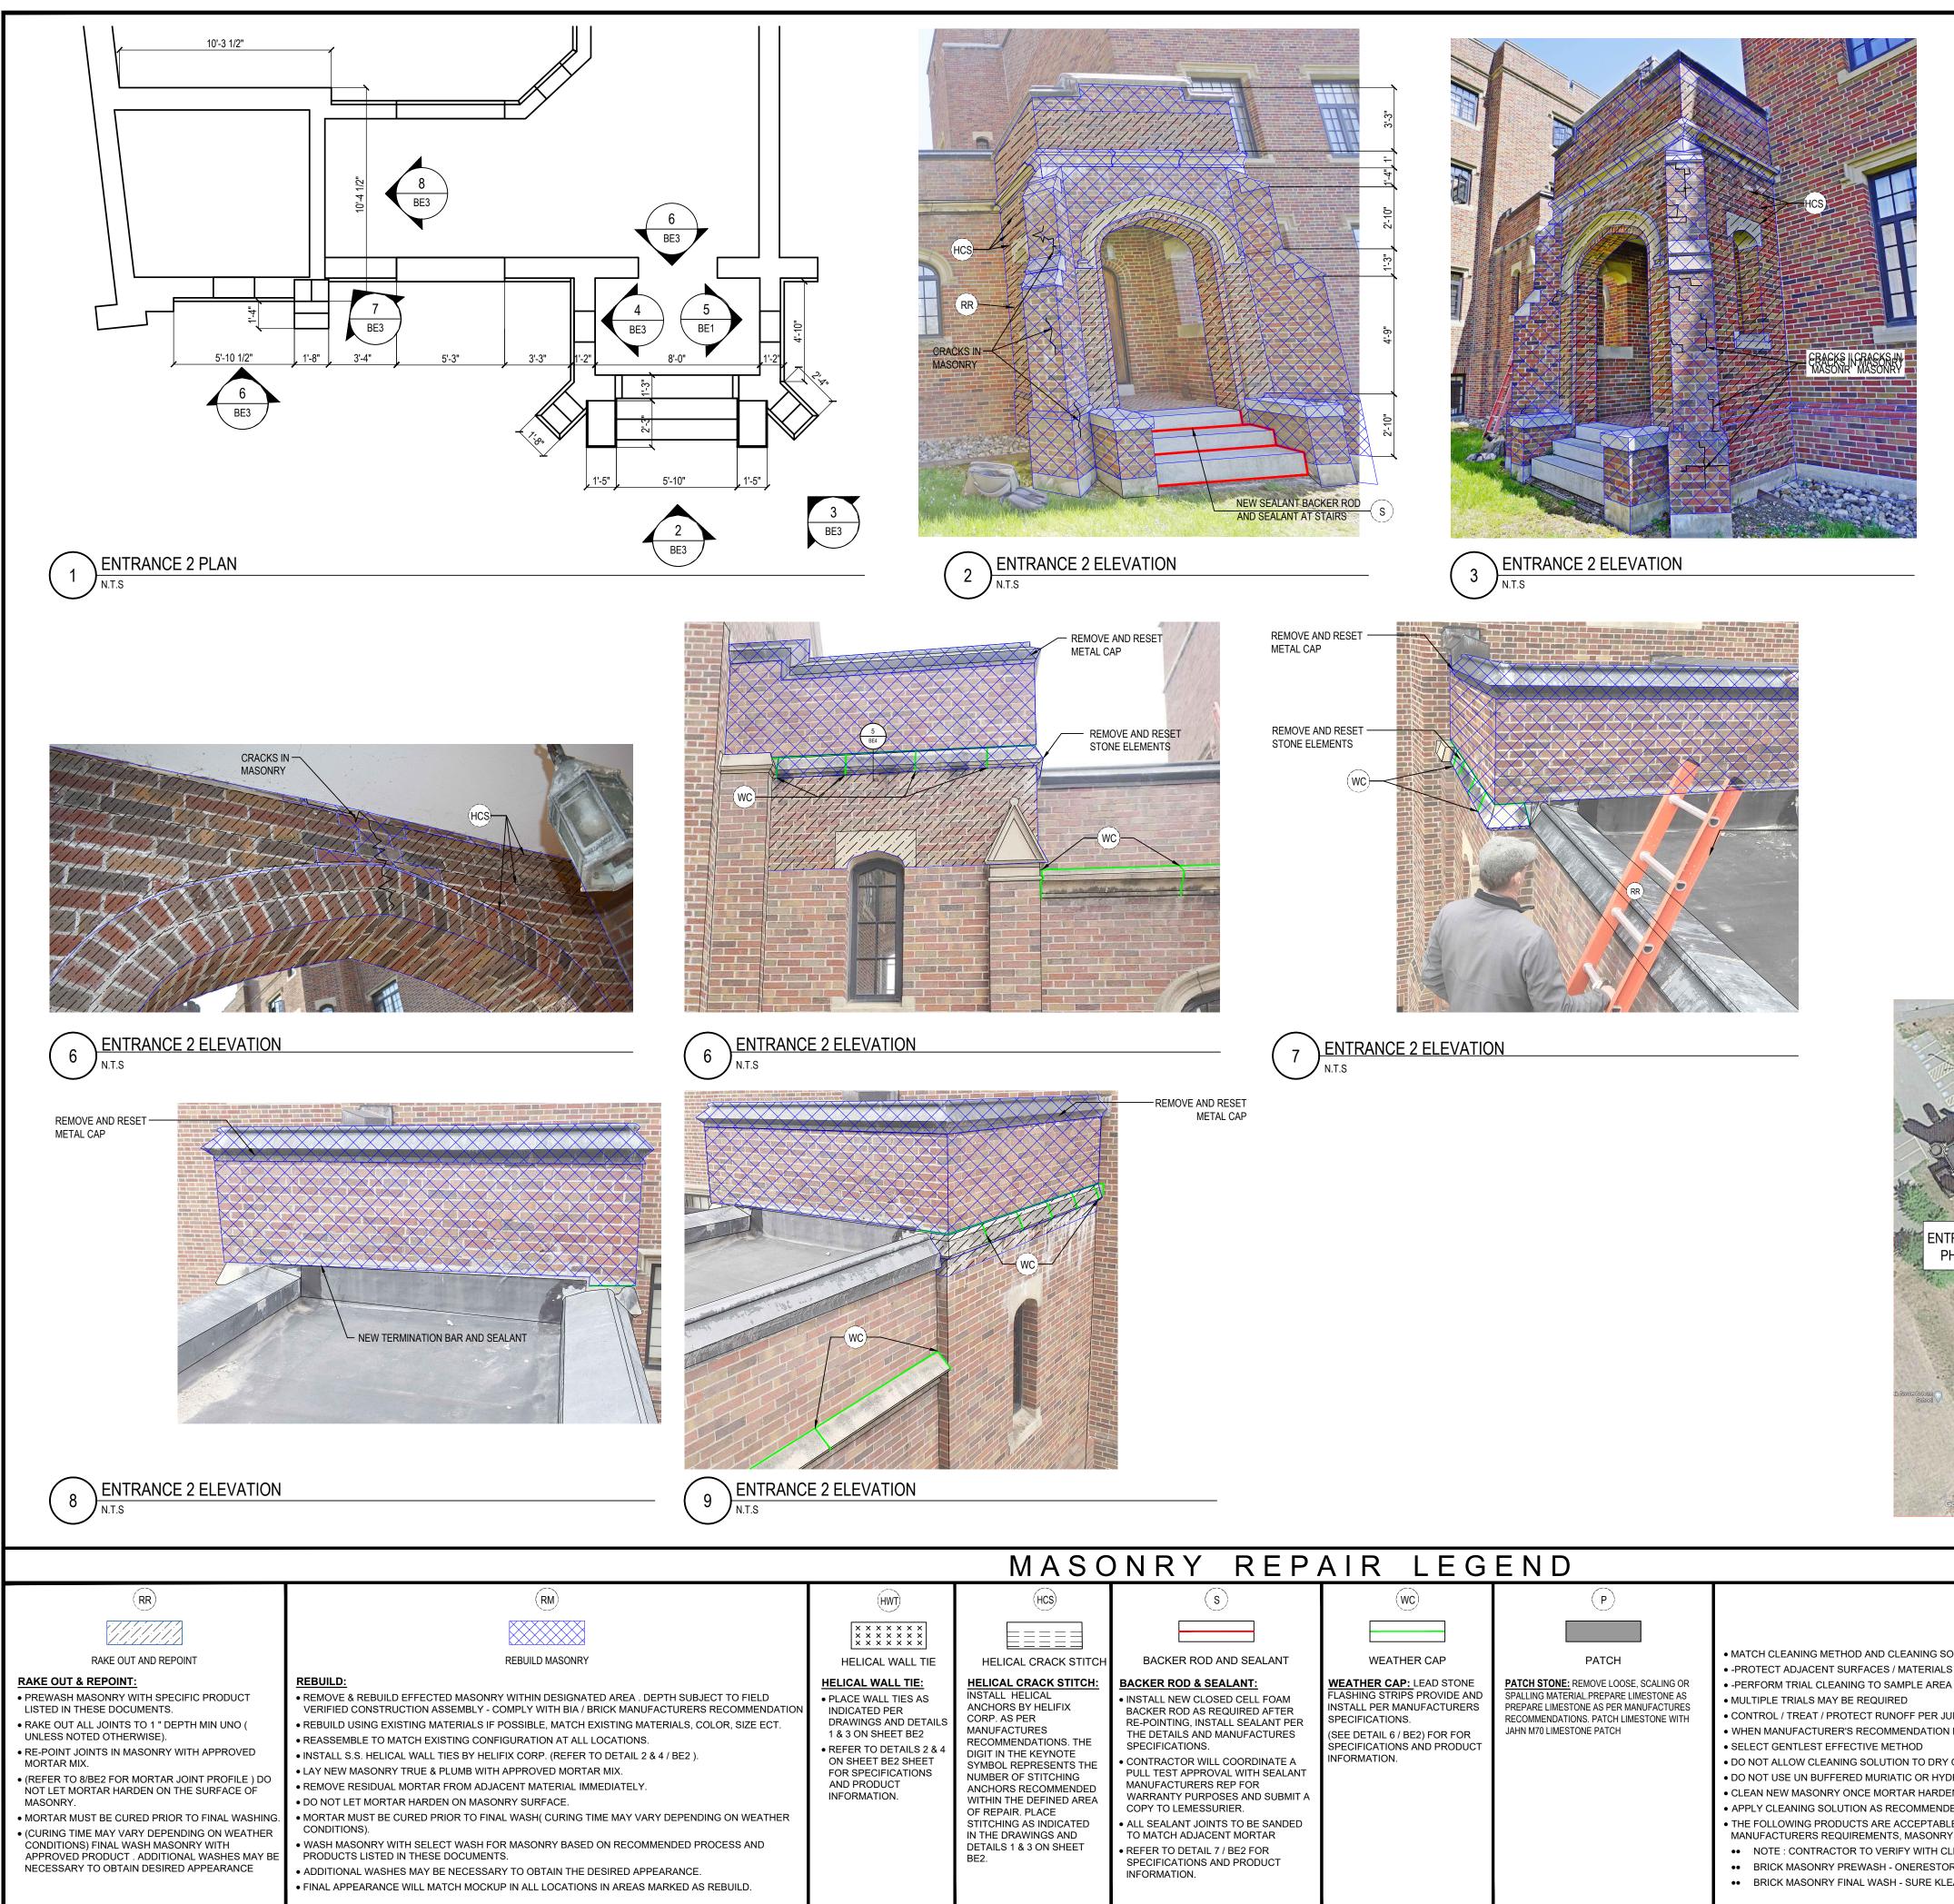


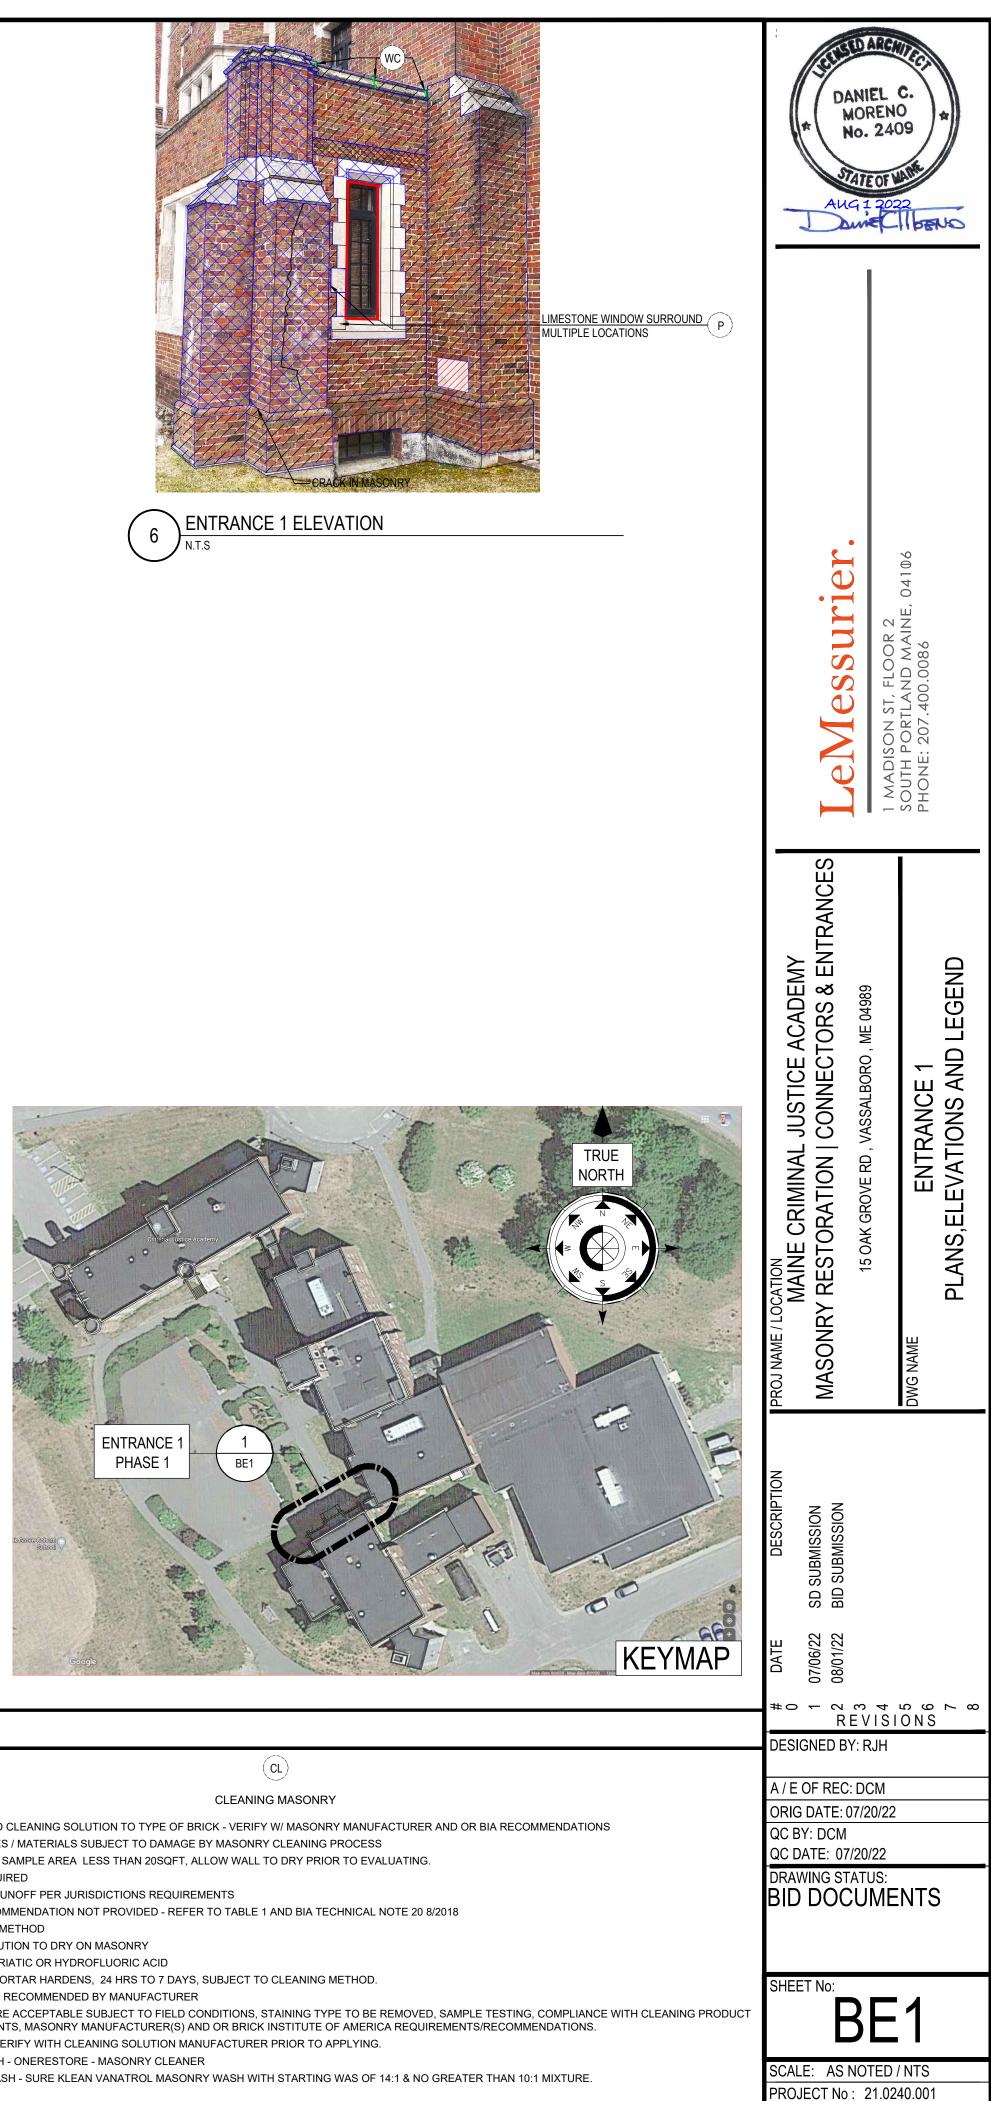
MASONRY REPAIR LEGEND									
HWT X X X X X X X X X X X X X X X X X X	HCS HCS HELICAL CRACK STITCH HELICAL CRACK STITCH HELICAL CRACK STITCH INSTALL HELICAL ANCHORS BY HELIFIX CORP. AS PER MANUFACTURES RECOMMENDATIONS. THE DIGIT IN THE KEYNOTE SYMBOL REPRESENTS THE NUMBER OF STITCHING ANCHORS RECOMMENDED WITHIN THE DEFINED AREA OF REPAIR. PLACE STITCHING AS INDICATED IN THE DRAWINGS AND DETAILS 1 & 3 ON SHEET BE2.	S BACKER ROD AND SEALANT BACKER ROD AND SEALANT BACKER ROD & SEALANT SEACKER ROD & SEALANT BACKER ROD & SEALANT POINTING, INSTALL SEALANT PER THE DETAILS AND MANUFACTURES SPECIFICATIONS. CONTRACTOR WILL COORDINATE A PULL TEST APPROVAL WITH SEALANT MANUFACTURERS REP FOR WARRANTY PURPOSES AND SUBMIT A COPY TO LEMESSURIER. ALL SEALANT JOINTS TO BE SANDED TO MATCH ADJACENT MORTAR REFER TO DETAIL 7 / BE2 FOR SPECIFICATIONS AND PRODUCT INFORMATION.	WC WEATHER CAP WEATHER CAP: LEAD STONE FLASHING STRIPS PROVIDE AND INSTALL PER MANUFACTURERS SPECIFICATIONS. (SEE DETAIL 6 / BE2) FOR FOR SPECIFICATIONS AND PRODUCT INFORMATION.	P PATCH PATCH STONE: REMOVE LOOSE, SCALING OR SPALLING MATERIAL PREPARE LIMESTONE AS PREPARE LIMESTONE AS PER MANUFACTURES RECOMMENDATIONS. PATCH LIMESTONE WITH JAHN M70 LIMESTONE PATCH	<ul> <li>MATCH CLEANING METHOD AND CLEANING SOL</li> <li>-PROTECT ADJACENT SURFACES / MATERIALS 3</li> <li>-PERFORM TRIAL CLEANING TO SAMPLE AREA</li> <li>MULTIPLE TRIALS MAY BE REQUIRED</li> <li>CONTROL / TREAT / PROTECT RUNOFF PER JUF</li> <li>WHEN MANUFACTURER'S RECOMMENDATION N</li> <li>SELECT GENTLEST EFFECTIVE METHOD</li> <li>DO NOT ALLOW CLEANING SOLUTION TO DRY C</li> <li>DO NOT USE UN BUFFERED MURIATIC OR HYDF</li> <li>CLEAN NEW MASONRY ONCE MORTAR HARDEN</li> <li>APPLY CLEANING SOLUTION AS RECOMMENDE</li> <li>THE FOLLOWING PRODUCTS ARE ACCEPTABLE MANUFACTURERS REQUIREMENTS, MASONRY</li> <li>NOTE : CONTRACTOR TO VERIFY WITH CLE</li> <li>BRICK MASONRY FINAL WASH - SURE KLEAR</li> </ul>				



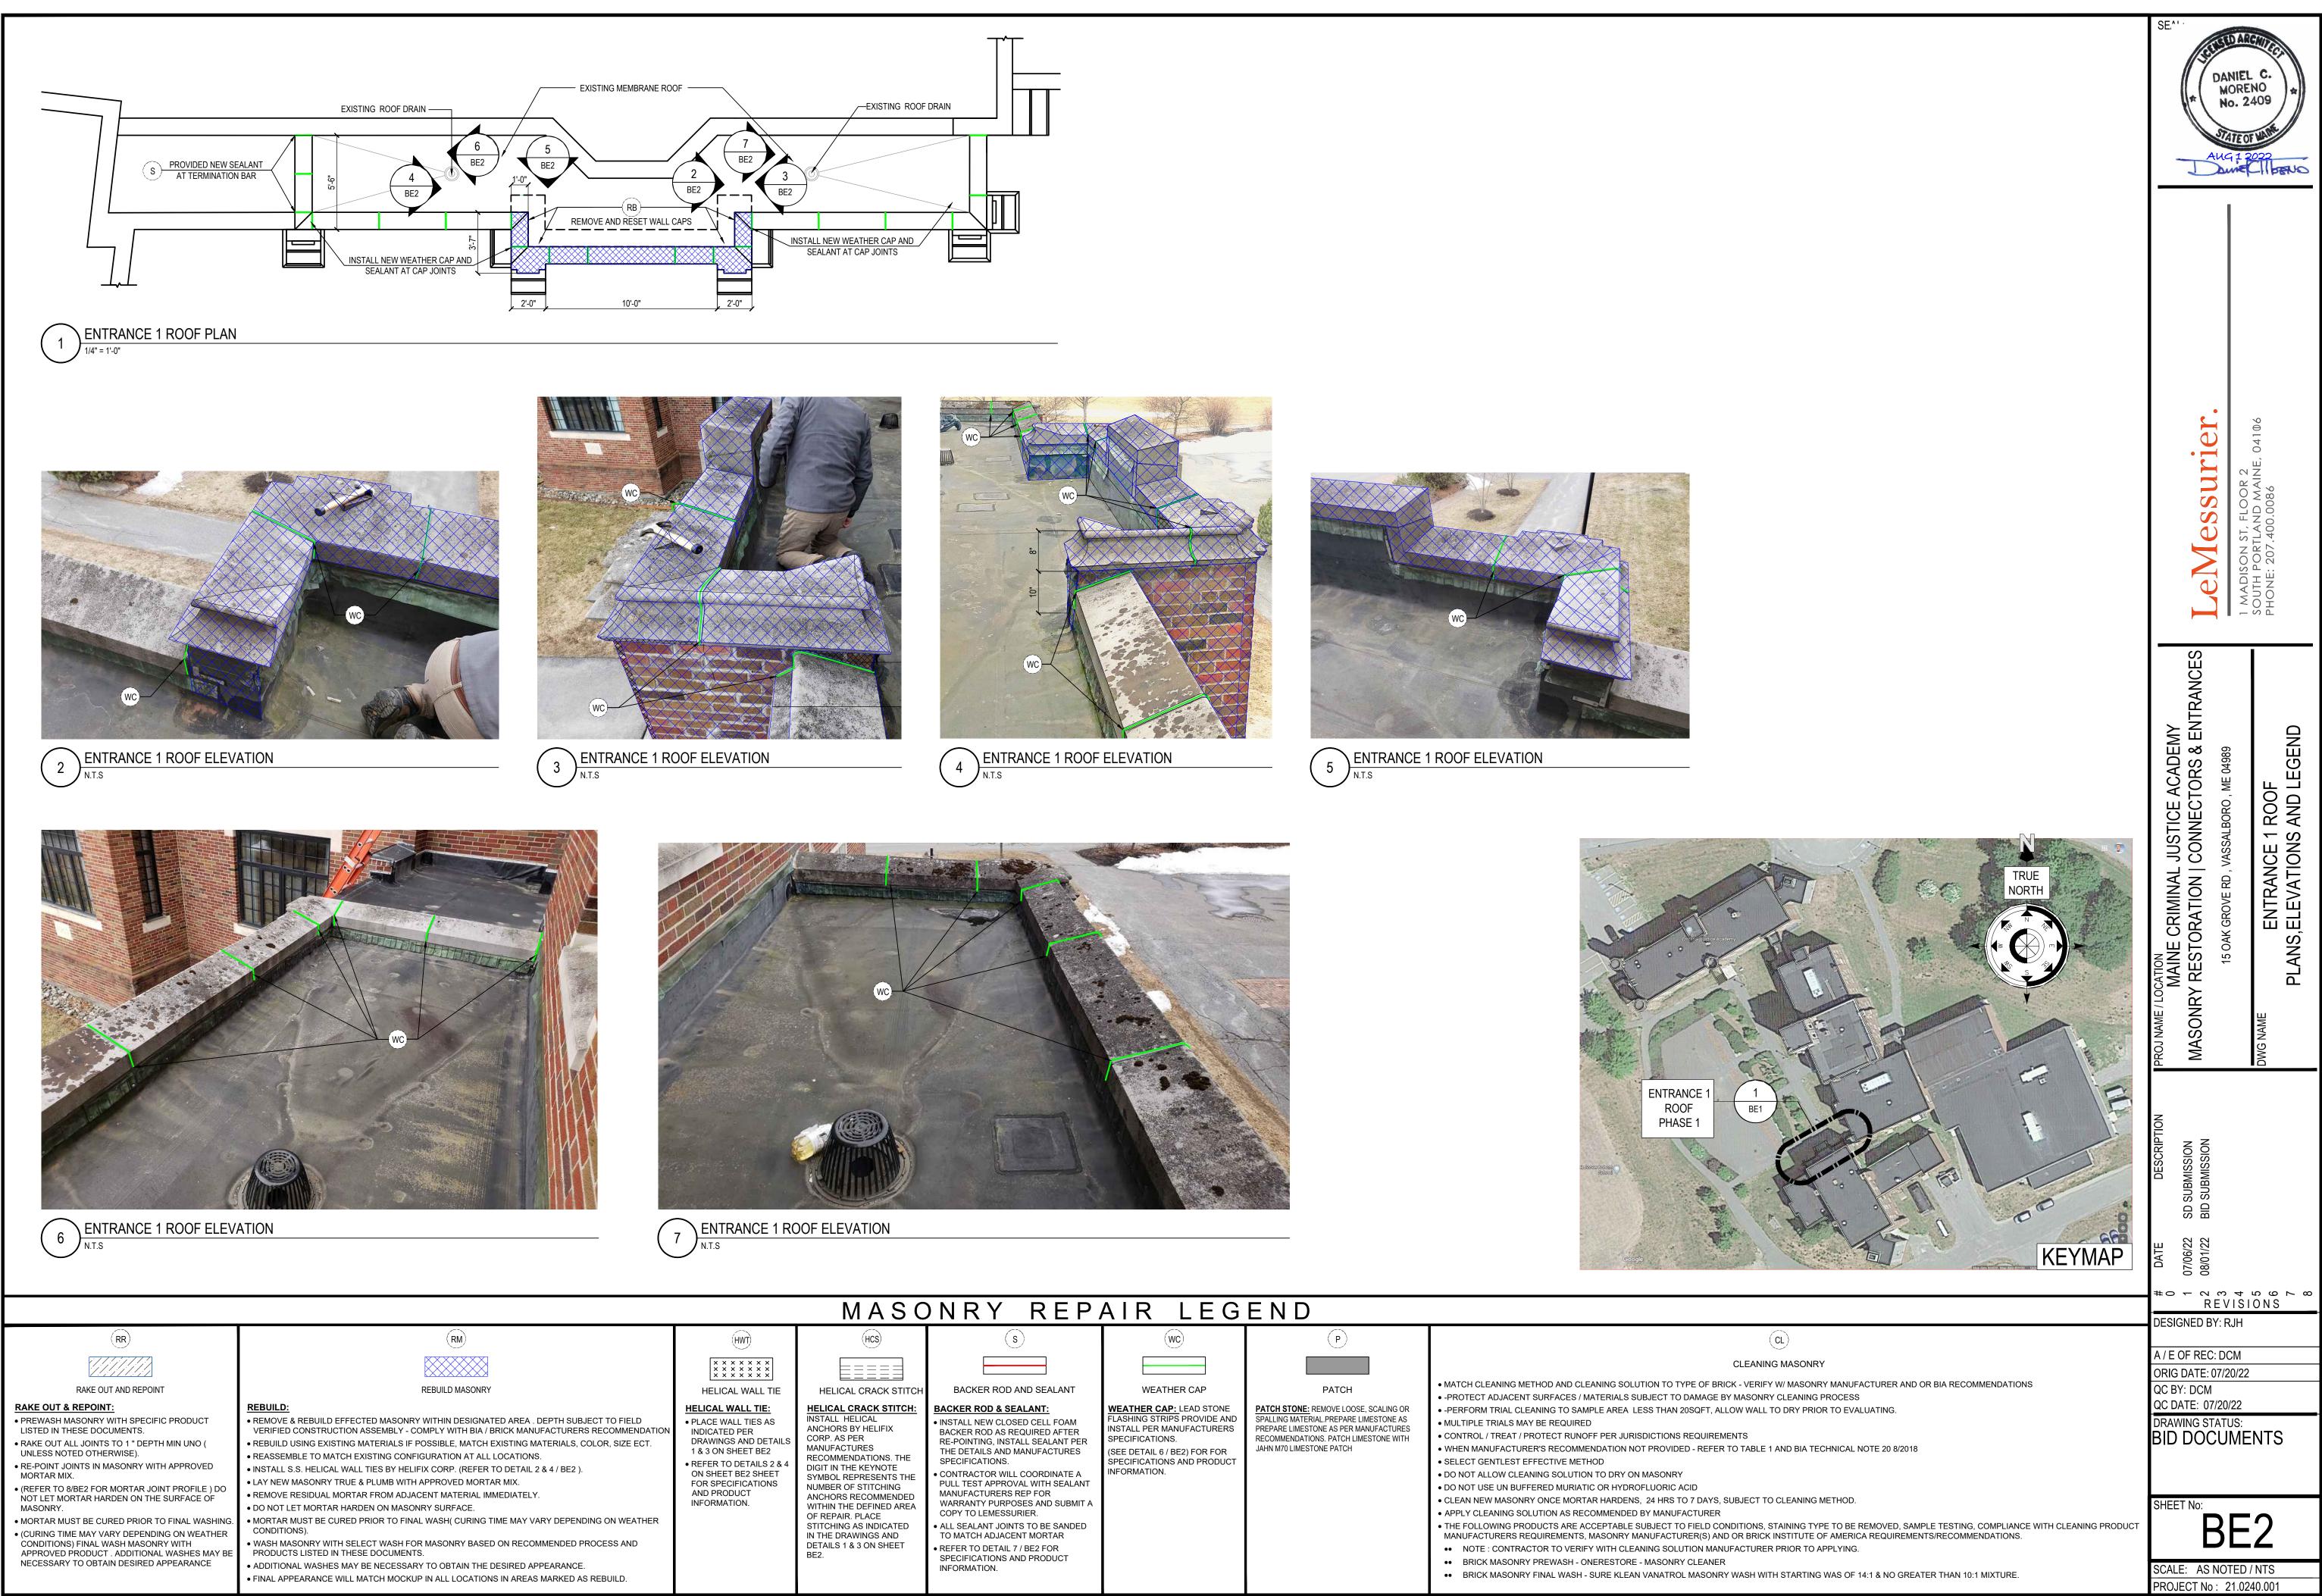

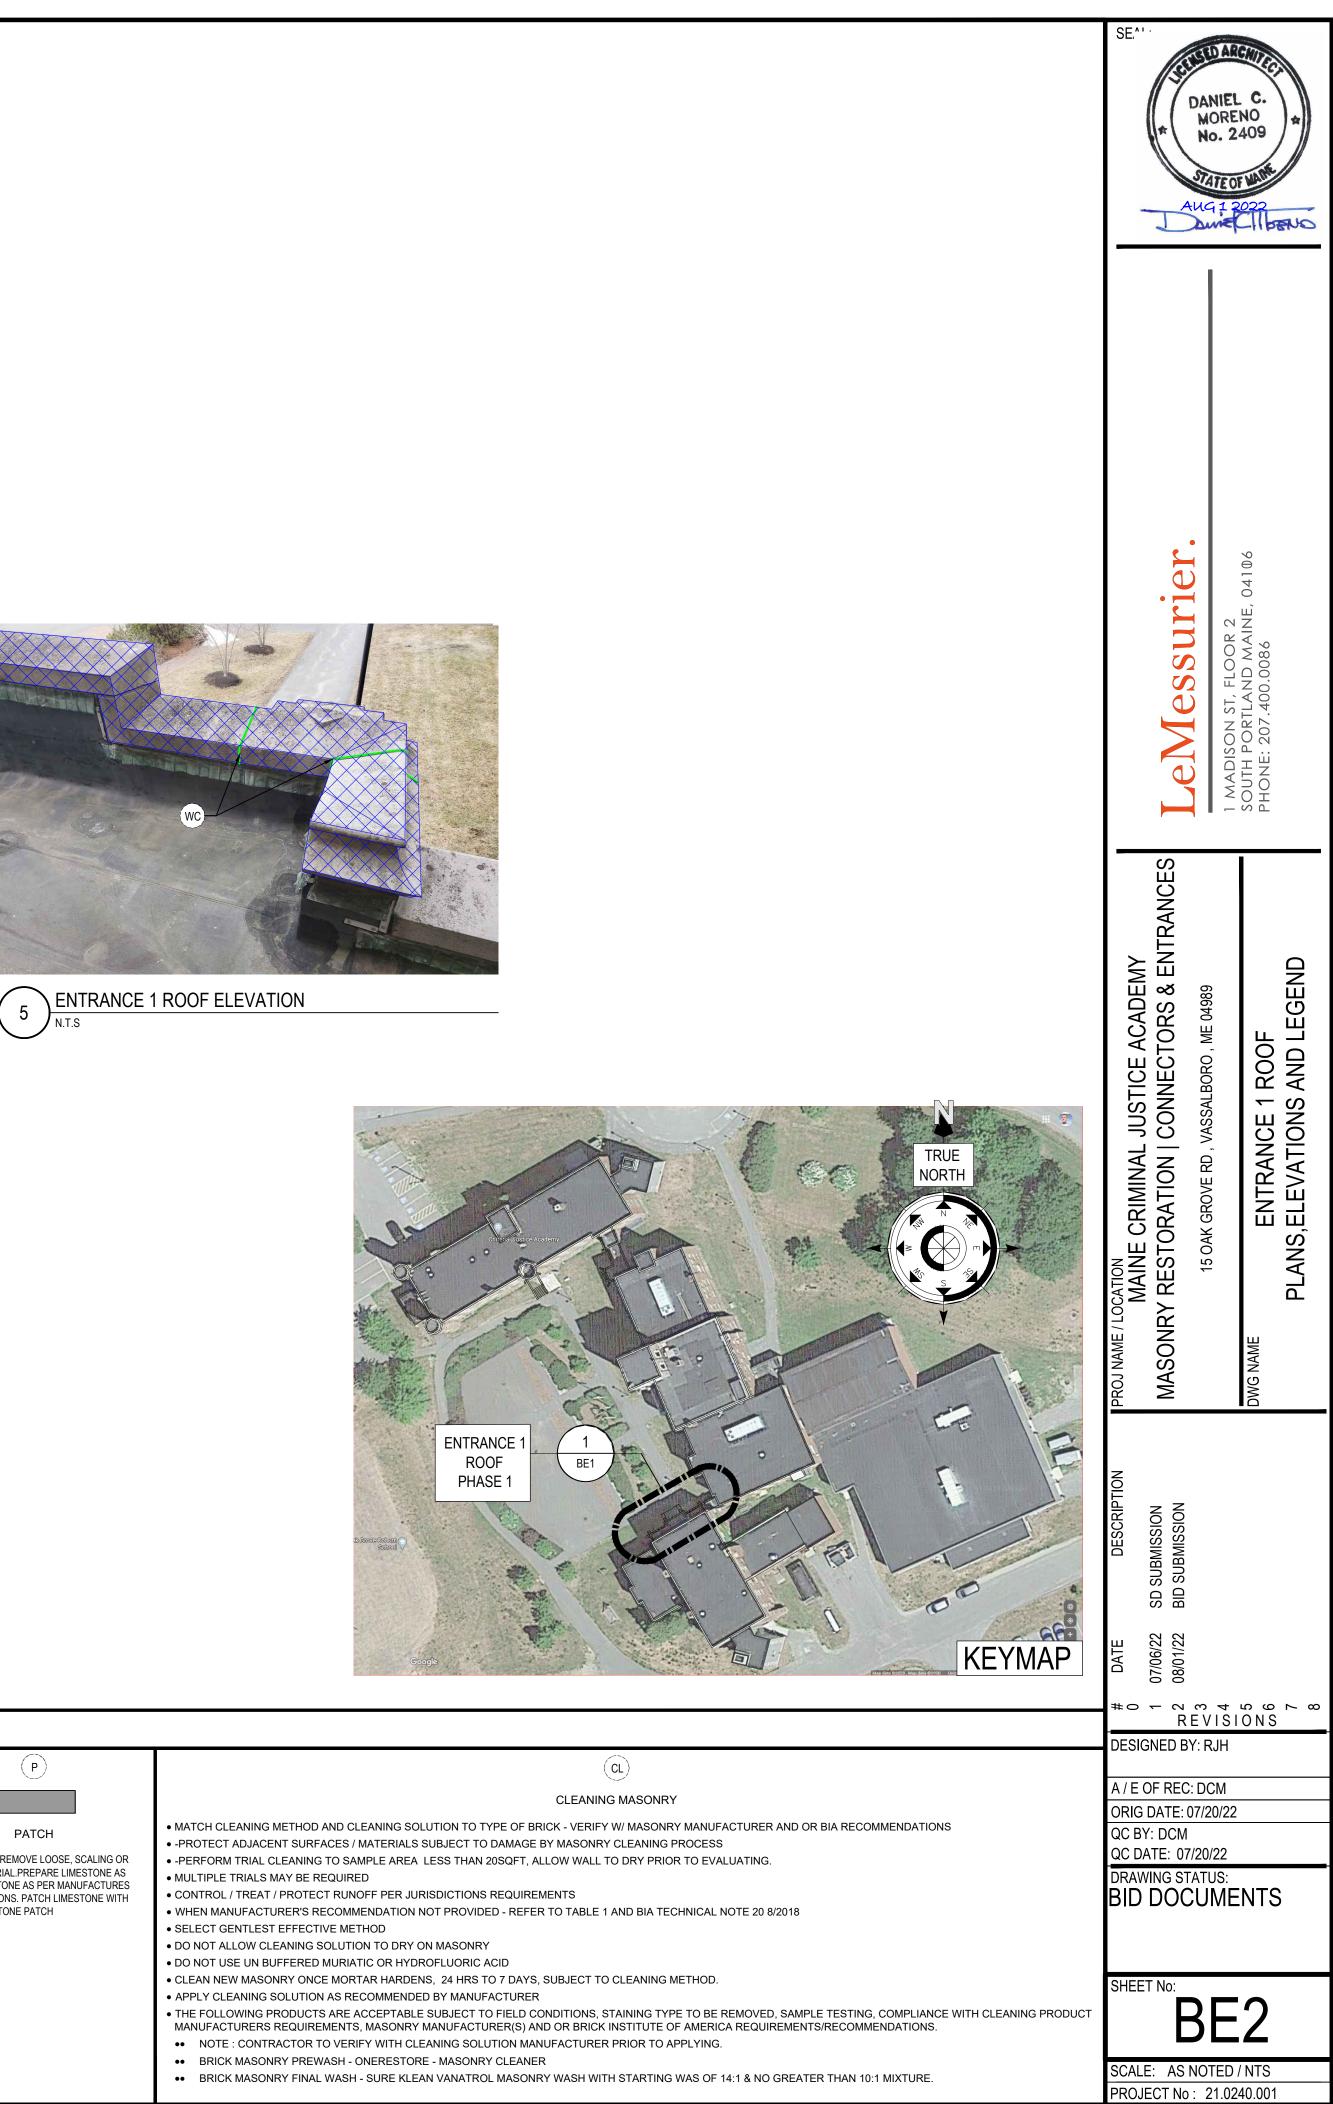

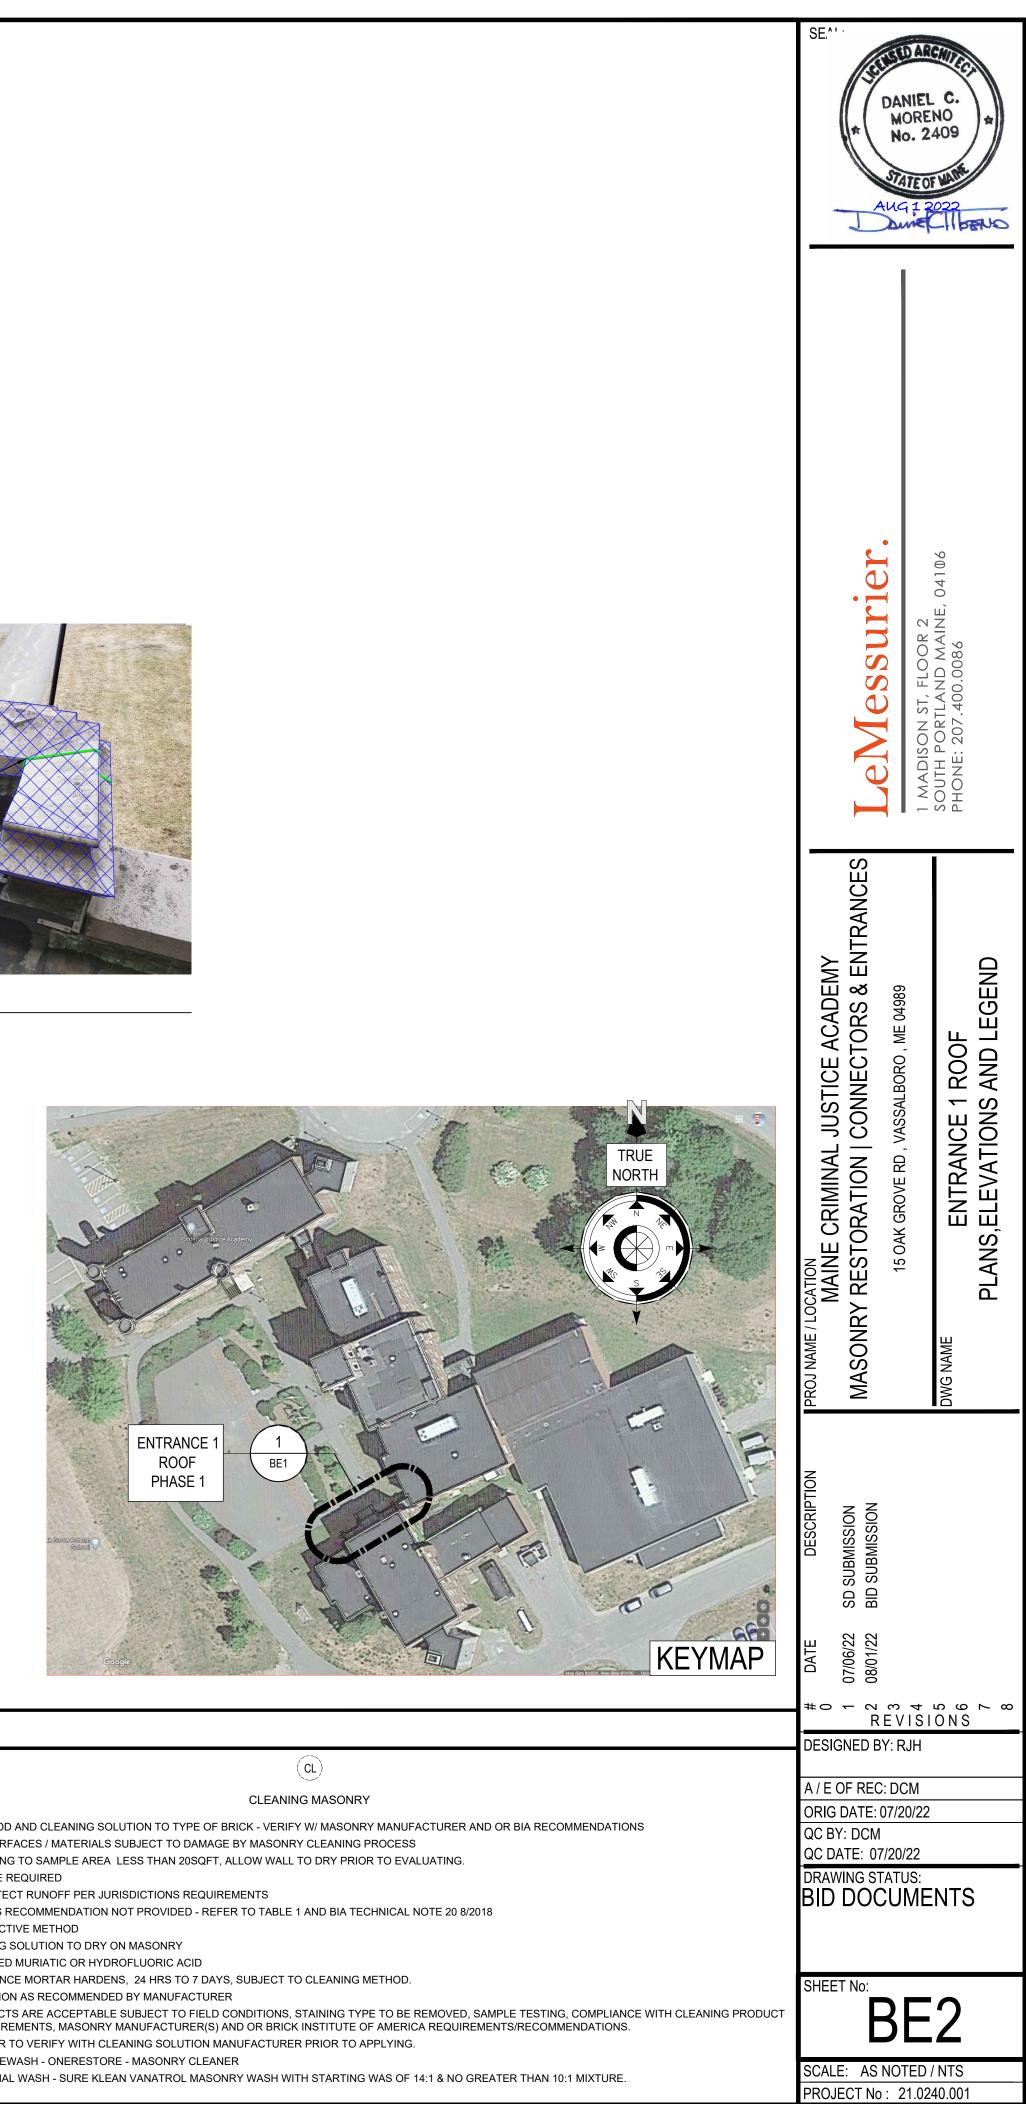

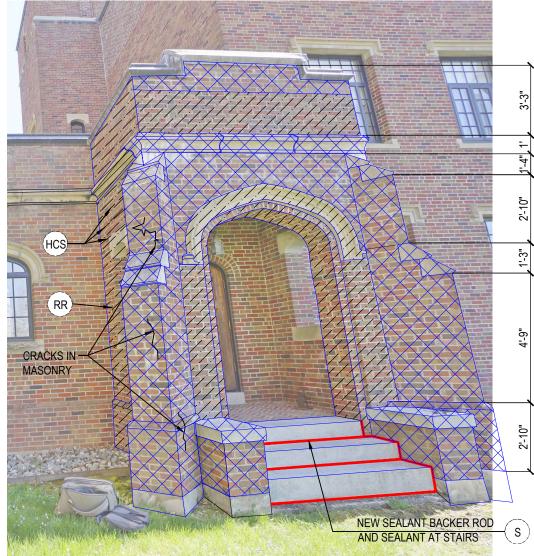










Purpose 1     Purpose 2           Purpose 2	SE DARCING DANIEL C. MORENO No. 2409 Dure 12022 Dure 100 VAINE, 04100 VAINE, 04100 VAINE, 04100 VAINE, 04100	
	<b>CONTRACT</b> <b>CONTRAND</b> <b>CONTRAND</b> <b>CONTRAND</b> <b>CONTRAND</b> <b>CONTRAND</b> <b>CONTRAND</b> <b>CONTRAND</b> <b>CONTRANT</b> <b>CONTRANT</b> <b>CONTRACT</b>	
	Lemessing floor 2 south portland maine, phone: 207.400.0086	
<image/>	PROJ NAME / LOCATION MAINE CRIMINAL JUSTICE ACADEMY MASONRY RESTORATION   CONNECTORS & ENTRANCES 15 OAK GROVE RD , VASSALBORO , ME 04989 DWG NAME FUTRANCE 2	PLANS, ELEVATIONS AND LEGEND
Cogle	DATE DESCRIPTION 07/06/22 SD SUBMISSION 08/01/22 BID SUBMISSION	
Mag forth £2020, Mag data £2020 Unit	#0 - ۲ ۳ ۴ ۳ ۳ REVISION	200
CL CLEANING MASONRY	DESIGNED BY: RJH A / E OF REC: DCM ORIG DATE: 07/20/22	
SOLUTION TO TYPE OF BRICK - VERIFY W/ MASONRY MANUFACTURER AND OR BIA RECOMMENDATIONS LS SUBJECT TO DAMAGE BY MASONRY CLEANING PROCESS EALLESS THAN 20SQFT, ALLOW WALL TO DRY PRIOR TO EVALUATING.	QC BY: DCM QC DATE: 07/20/22 DRAWING STATUS:	
JURISDICTIONS REQUIREMENTS N NOT PROVIDED - REFER TO TABLE 1 AND BIA TECHNICAL NOTE 20 8/2018 Y ON MASONRY	BID DOCUMENT	S
/DROFLUORIC ACID DENS, 24 HRS TO 7 DAYS, SUBJECT TO CLEANING METHOD. DED BY MANUFACTURER BLE SUBJECT TO FIELD CONDITIONS, STAINING TYPE TO BE REMOVED, SAMPLE TESTING, COMPLIANCE WITH CLEANING PRODUCT RY MANUFACTURER(S) AND OR BRICK INSTITUTE OF AMERICA REQUIREMENTS/RECOMMENDATIONS.	SHEET NO: BE3	
CLEANING SOLUTION MANUFACTURER PRIOR TO APPLYING. ORE - MASONRY CLEANER LEAN VANATROL MASONRY WASH WITH STARTING WAS OF 14:1 & NO GREATER THAN 10:1 MIXTURE.	SCALE: AS NOTED / NTS PROJECT No : 21.0240.00	

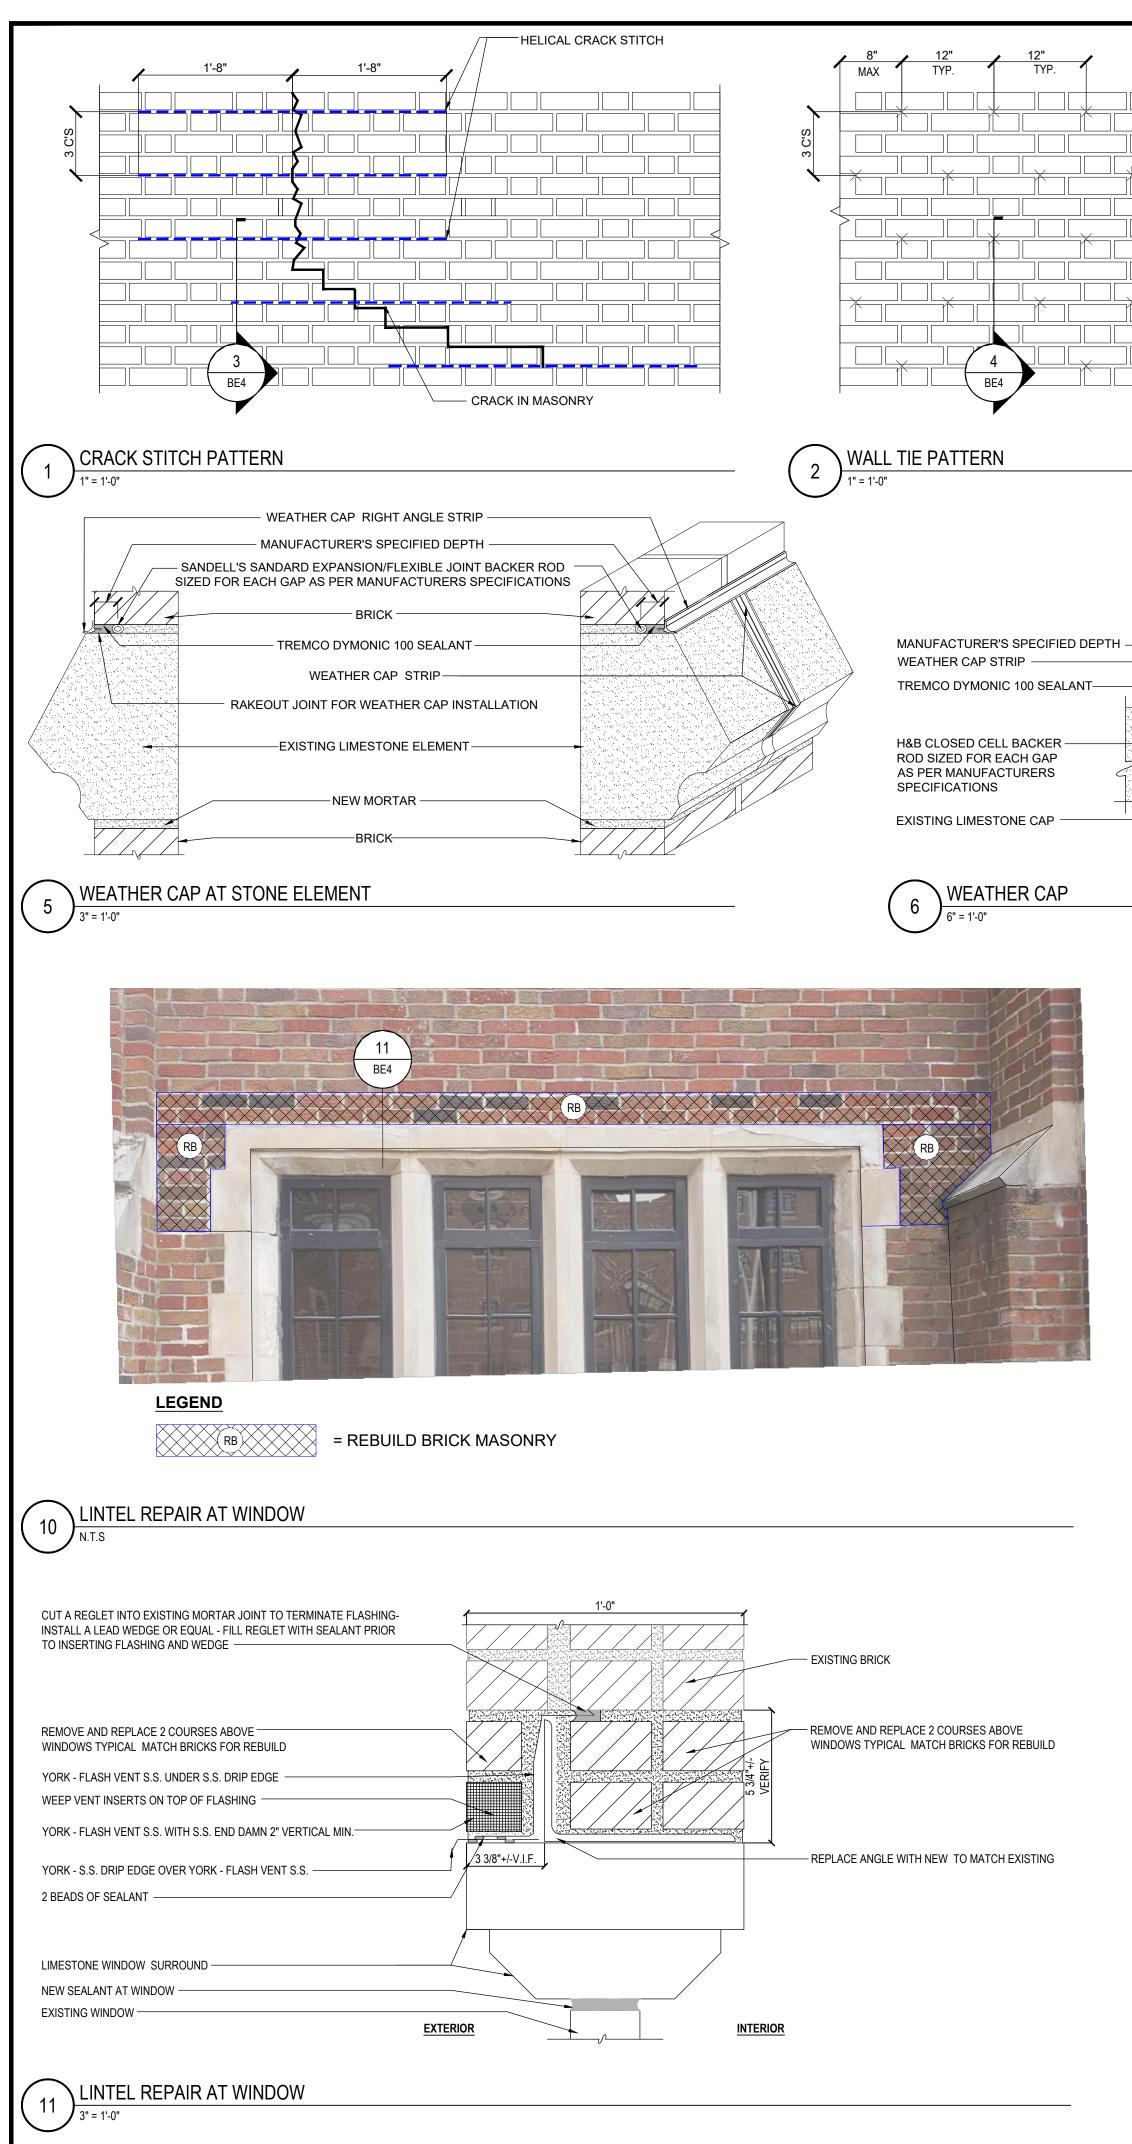



STAIR WALL CAP REBUILD 9) 3" = 1'-0"

ARRIS LINE **YBACKER ROD AND SEALANT JOINT** 8 6" = 1'-0" EXISTING CAP TO BE RESET CENTER LINE 

- INSTALL NEW PORTION OF

AND STONE CAP

LAP NEW MEMBRANE


REMOVE PORTION OF EXITING MEMBRANE

OVER EXISTING

EXISTING ROOF MEMBRANE AND INSULATION TO REMAIN

MEMBRANE UP AND OVER PARAPET WALL UNDER PAN

12

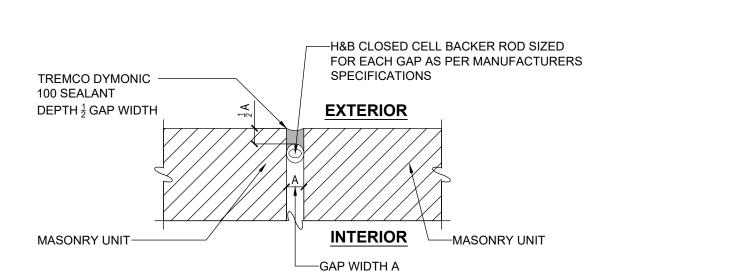


SPECIFICATIONS. INSTALL 2 RODS IF CONDITIONS ALLOW


3

3" = 1'-0"

CRACK STITCH DETAIL

VERIFY ACTUAL DEPTH REQUIREMENTS WITH MANUFACTURER'S SPECIFICATIONS MAINTAIN MIN 1" FROM FACE -6MM S.S. HELICAL TIE RODS IN BONDING -ADHESIVE, INSTALL AS PER MANUFACTURERS

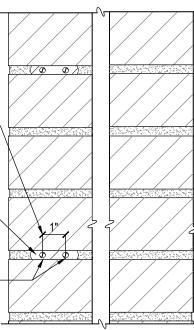

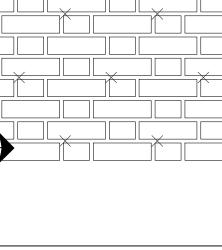

HELICAL

