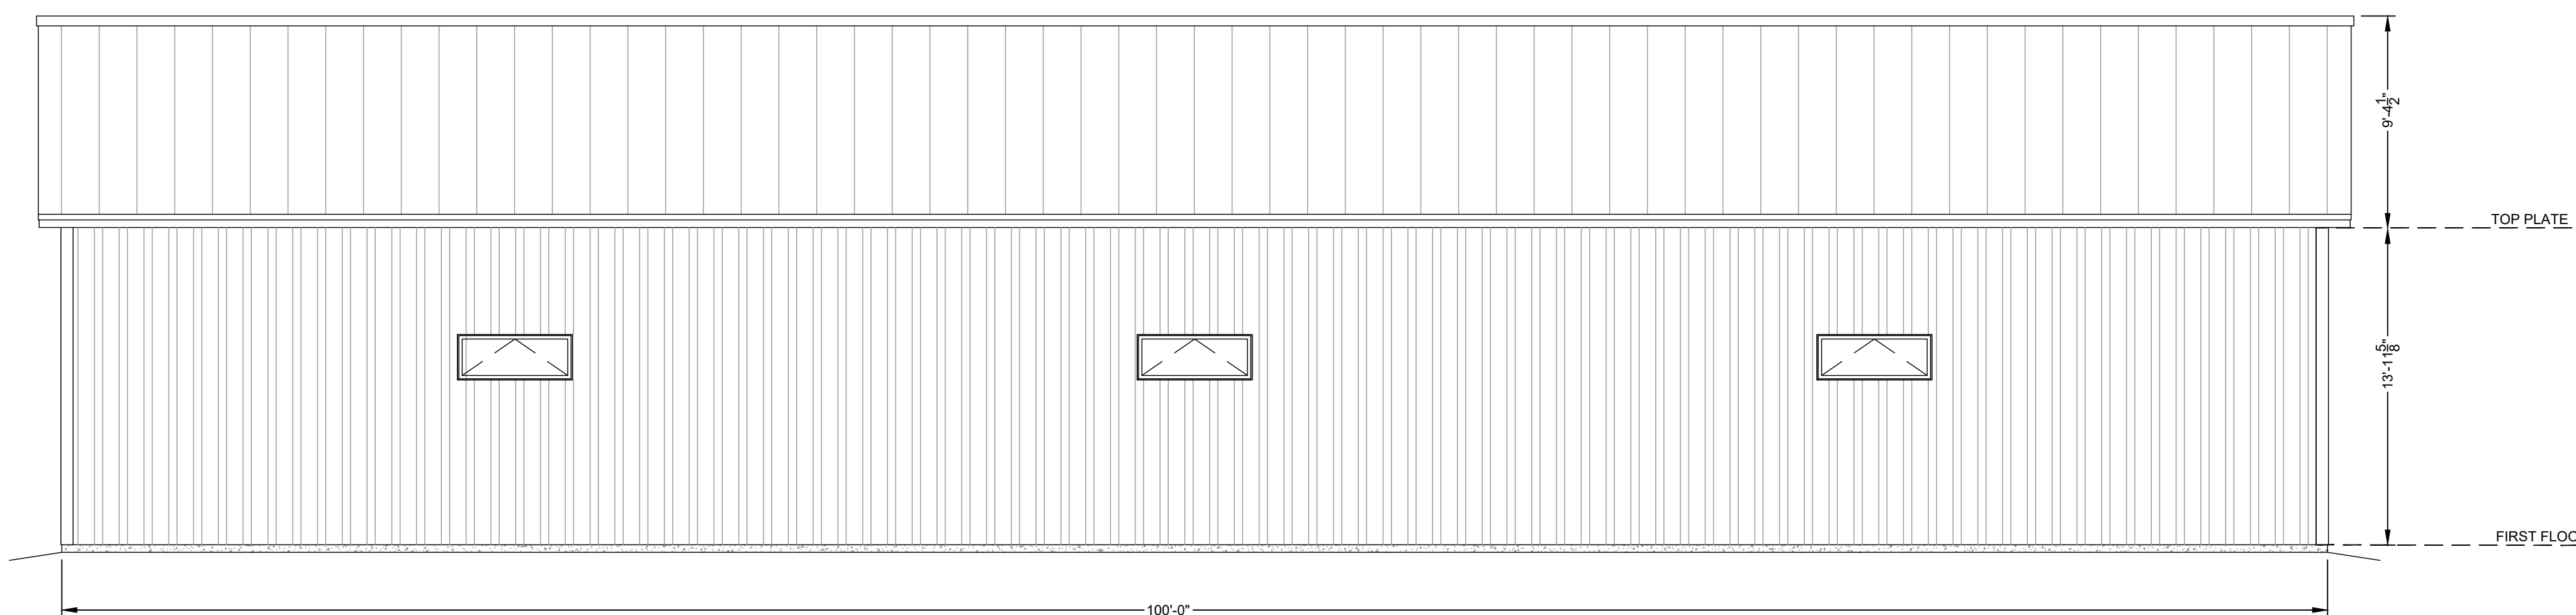


STORAGE


WINDOW SCHEDULE					
NO.	QUANTITY	SIZE	TYPE	FRAME	REMARKS
(A)	6	5'-0" x 2'-0"	AWNING	ALUMINUM	

FIRST FLOOR PLAN
SCALE 3/16" = 1'-0"

DOOR SCHEDULE					
NO.	QUANTITY	SIZE	TYPE	FRAME	REMARKS
(1)	2	3'-0" x 6'-8"	METAL INSULATED	METAL	HINGES, LEVER HARDWARE, THRESHOLD, CLOSER, DEAD BOLT ENTRY LOCKSET
(2)	2	12'-0" x 12'-0"	OVERHEAD	NA	TRACK, AUTOMATIC OPENER



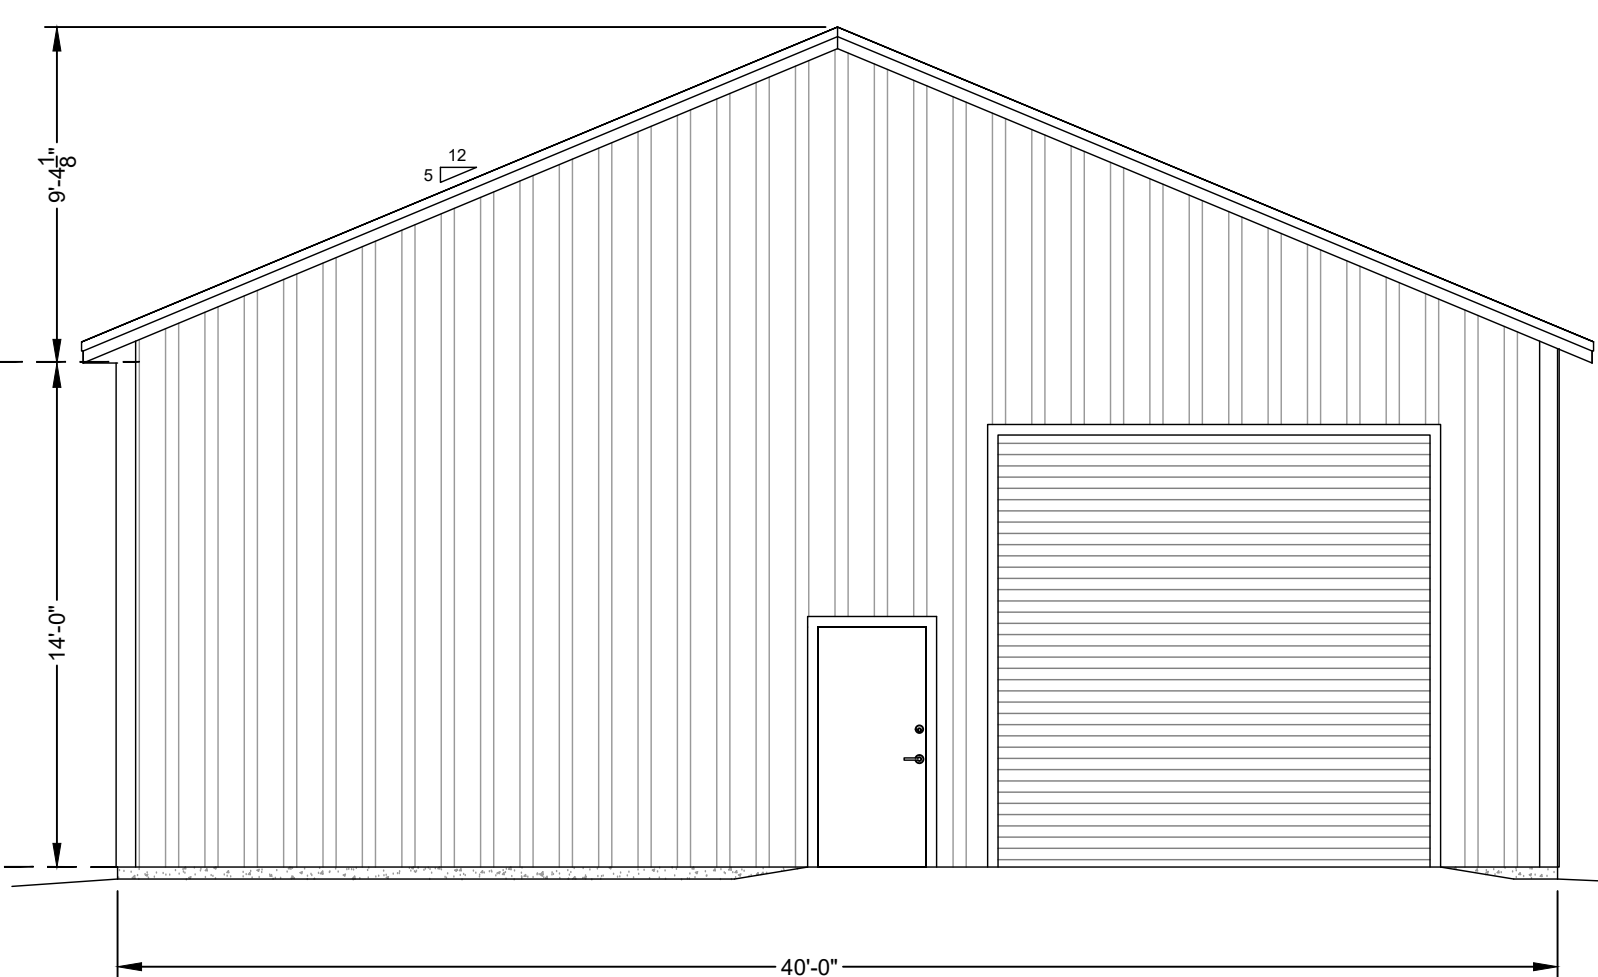EAST ELEVATION
SCALE 3/16" = 1'-0"




NORTH ELEVATION
SCALE 3/16" = 1'-0"

ISSUED FOR BID



REV.	APPD	DATE	STATUS
2	BEM	08-19-2022	ISSUED FOR BID
1	AEH	05-13-2021	UPDATED DOOR SCHEDULE & FOUNDATION DETAILS
0	AEH	04-01-2021	ISSUED FOR REVIEW
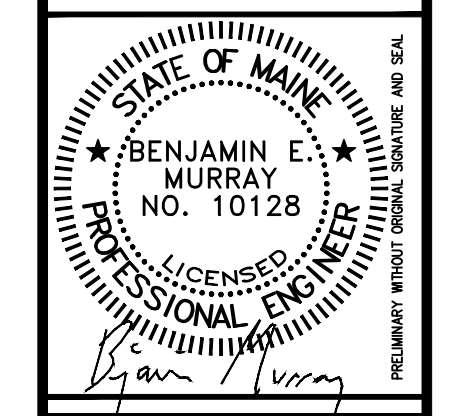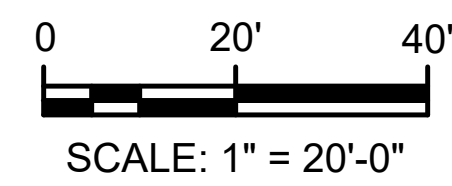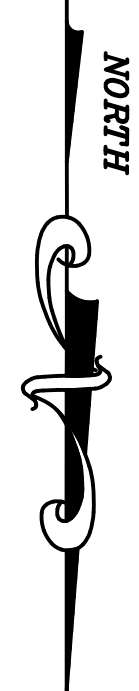
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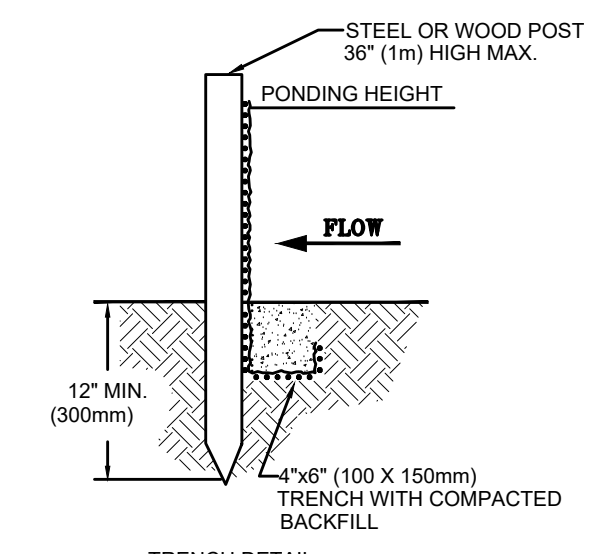
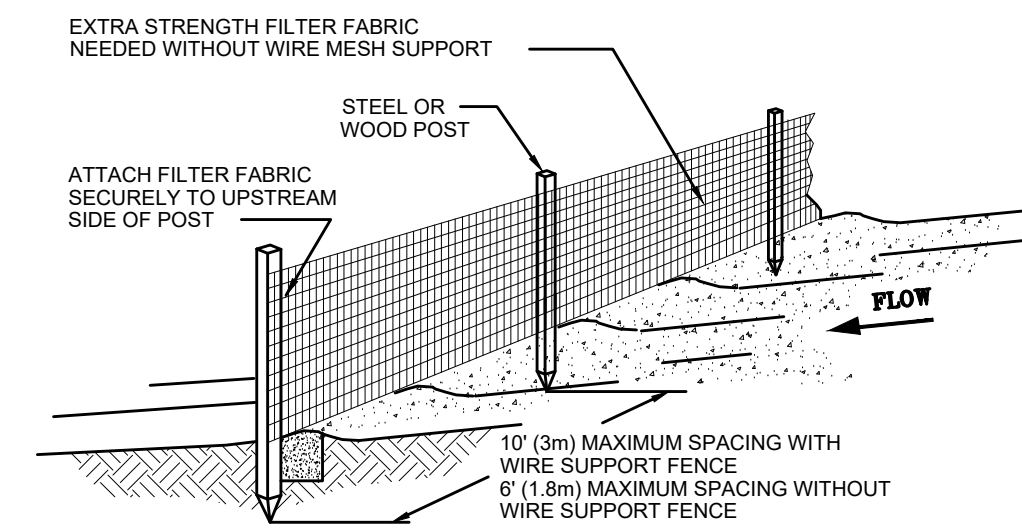
FLOOR/ELEVATION PLAN
OF
ENFIELD STORAGE BARN
COBB ROAD
ENFIELD, MAINE
FOR:
MAINE DEPT OF INLAND FISHERIES & WILDLIFE
41 STATE HOUSE STATION
AUGUSTA, MAINE

DRAWN	CHECKED
MG	AEH
SCALE	DATE
AS NOTED	04-01-2021



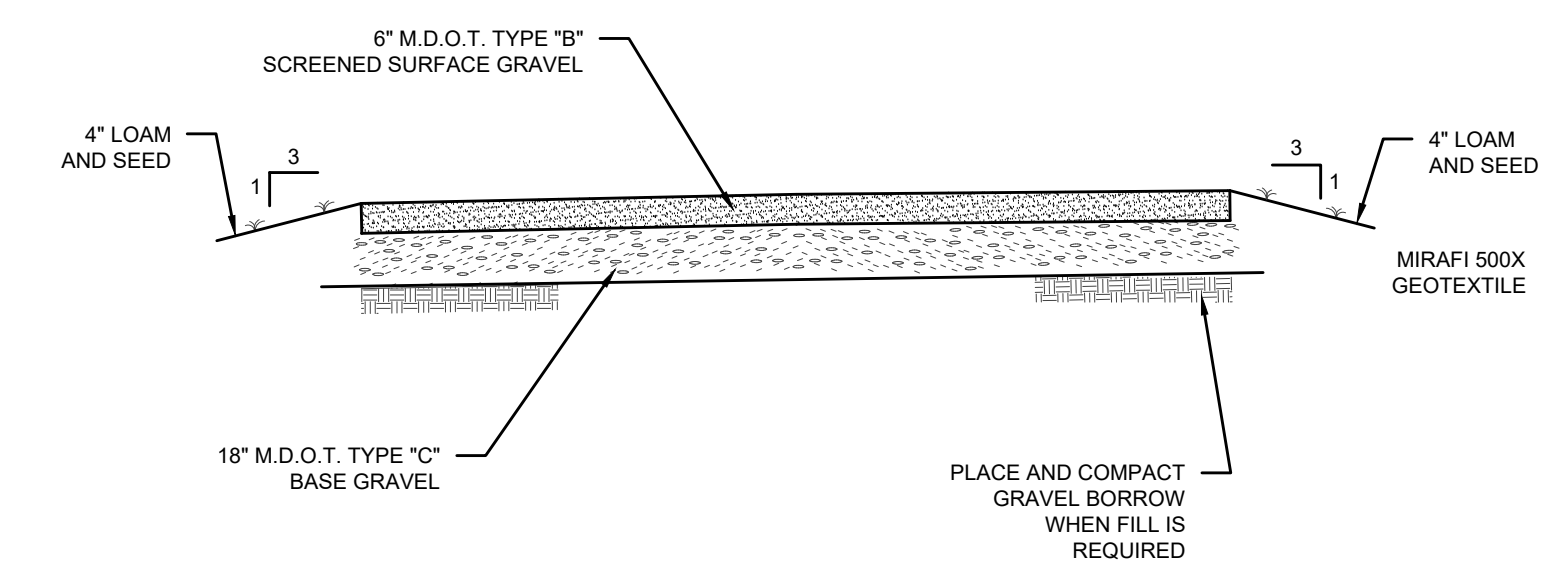
General Site Notes

- EXISTING UTILITIES: EXISTING UTILITIES HAVE BEEN IDENTIFIED FROM FIELD SURVEYS AND EXISTING RECORDS. THE ENGINEER AND OWNER MAKE NO GUARANTEE OF THE ACCURACY OF THE LOCATIONS AS SHOWN ON THE PLANS. IN ADDITION, UTILITIES THAT EXIST MAY NOT BE SHOWN ON THE PLANS. INDIVIDUAL WATER OR SEWER SERVICES ARE GENERALLY NOT SHOWN ON THE PLANS. THE CONTRACTOR IS RESPONSIBLE FOR THE INTEGRITY OF ALL EXISTING UTILITIES INCLUDING INDIVIDUAL SERVICES WHETHER OR NOT THEY ARE SHOWN CORRECTLY OR SHOWN AT ALL ON THE PLANS. CONTRACTOR IS RESPONSIBLE FOR FOLLOWING ALL DIG-SAFE PROCEDURES AND CONTACTING NON DIG-SAFE UTILITIES TO MARK THEIR UNDERGROUND UTILITIES BEFORE CONSTRUCTION BEGINS. REPAIR OF DAMAGED UTILITIES SHALL BE AT THE CONTRACTOR'S EXPENSE. NO DAMAGED UTILITIES SHALL BE BACKFILLED UNTIL THE OWNER'S REPRESENTATIVE INSPECTS AND APPROVES THE REPAIR.
- NO TRENCH SHALL BE LEFT OPEN OVERNIGHT. IF TRENCH IS NOT BACKFILLED, SECURE WITH CONCRETE BARRIERS AND STEEL PLATE OVER TRENCH.
- CONTRACTOR SHALL COORDINATE WITH ELECTRICAL UTILITY FOR HOLDING UTILITY POLES AS NEEDED. COST FOR THIS WORK WILL BE PAID BY THE CONTRACTOR.
- CONTRACTOR SHALL PROTECT AND AVOID DISTURBING PROPERTY PINS AND MONUMENTS. IF DISTURBED, THE PROPERTY PINE OR MONUMENT SHALL BE RESET AT CONTRACTOR'S EXPENSE BY A REGISTERED LAND SURVEYOR APPROVED BY THE ENGINEER.
- CONTRACTOR IS RESPONSIBLE FOR THE LAYOUT OF ALL PROPOSED WORK. ENGINEER WILL ASSIST ONLY IN PROVIDING REFERENCE POINTS AND ELEVATION DATA FOR INITIAL LAYOUT ONLY. CONTRACTOR SHALL MAINTAIN LAYOUT THROUGHOUT PROJECT.
- CONTRACTOR SHALL INSTALL AND MAINTAIN APPROPRIATE EROSION AND SEDIMENT CONTROL MEASURES DURING CONSTRUCTION IN ACCORDANCE WITH ACCEPTED PRACTICE, APPLICABLE LAWS AND REGULATIONS AND REQUIREMENTS OF THESE CONTRACT DOCUMENTS.
- CONTRACTOR SHALL CONTROL DUST GENERATED DURING THE PROJECT TO A LEVEL SATISFACTORY TO THE OWNER AND ENGINEER.
- IMMEDIATELY REPAIR ANY EXISTING UTILITIES DAMAGE DURING CONSTRUCTION.
- LOAM AND SEED ALL DISTURBED GRASSED AREAS WITH 4" LOAM, SEED AND MULCH WITHIN 5 DAYS OF REACHING FINAL GRADE.
- ALL AREAS DISTURBED BY CONTRACTOR'S OPERATIONS SHALL BE RESTORED TO THEIR ORIGINAL CONDITION UNLESS OTHERWISE NOTED. COST OF RESTORATION IS INCIDENTAL TO CONTRACT OUTSIDE OF PAY LIMITS.
- CONTRACTOR SHALL HAVE THE SOLE RESPONSIBILITY OF ENSURE THAT ALL WORK MEETS ALL OSHA AND OTHER APPLICABLE CODE, HEALTH AND SAFETY REQUIREMENTS.



- NOTES:
- SILT FENCE SHALL BE PLACED ON SLOPE CONTOURS TO MAXIMIZE PONDING EFFICIENCY. SILT FENCE MUST BE INSTALLED WITH THE ENDS TURNED UP SLOPE.
 - INSPECT AND REPAIR FENCE AFTER EACH STORM EVENT AND REMOVE SEDIMENT WHEN NECESSARY. 9" (225mm) MAXIMUM RECOMMENDED STORAGE HEIGHT.
 - REMOVED SEDIMENT SHALL BE DEPOSITED TO AN AREA THAT WILL NOT CONTRIBUTE SEDIMENT OFF-SITE AND CAN BE PERMANENTLY STABILIZED.

SILT FENCE
Not To Scale



TYPICAL GRAVEL PARKING LOT
Not To Scale

ISSUED FOR BID

AEHodsdon
CONSULTING ENGINEERS

10 Common Street Waterville, Maine 04901
(207) 873-5164
(207) 872-0645

1	BEM	06-19-2022	ISSUED FOR BID
	REV: APPD	DATE:	STATUS:


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STATE OF MAINE
BENJAMIN F. MURRAY
NO. 10128
LICENSED PROFESSIONAL ENGINEER
REGULATORY WITHOUT MENTAL, DOMESTIC AND SEA


SITE PLAN
OF
STORAGE BARN
COBB HATCHERY ROAD
ENFIELD, MAINE
FOR
MAINE DEPT OF INLAND FISHERIES & WILDLIFE
41 STATE HOUSE STATION
AUGUSTA, MAINE

DRAWN	CHECKED
PLS	BEM
SCALE	DATE
AS NOTED	04-20-2021

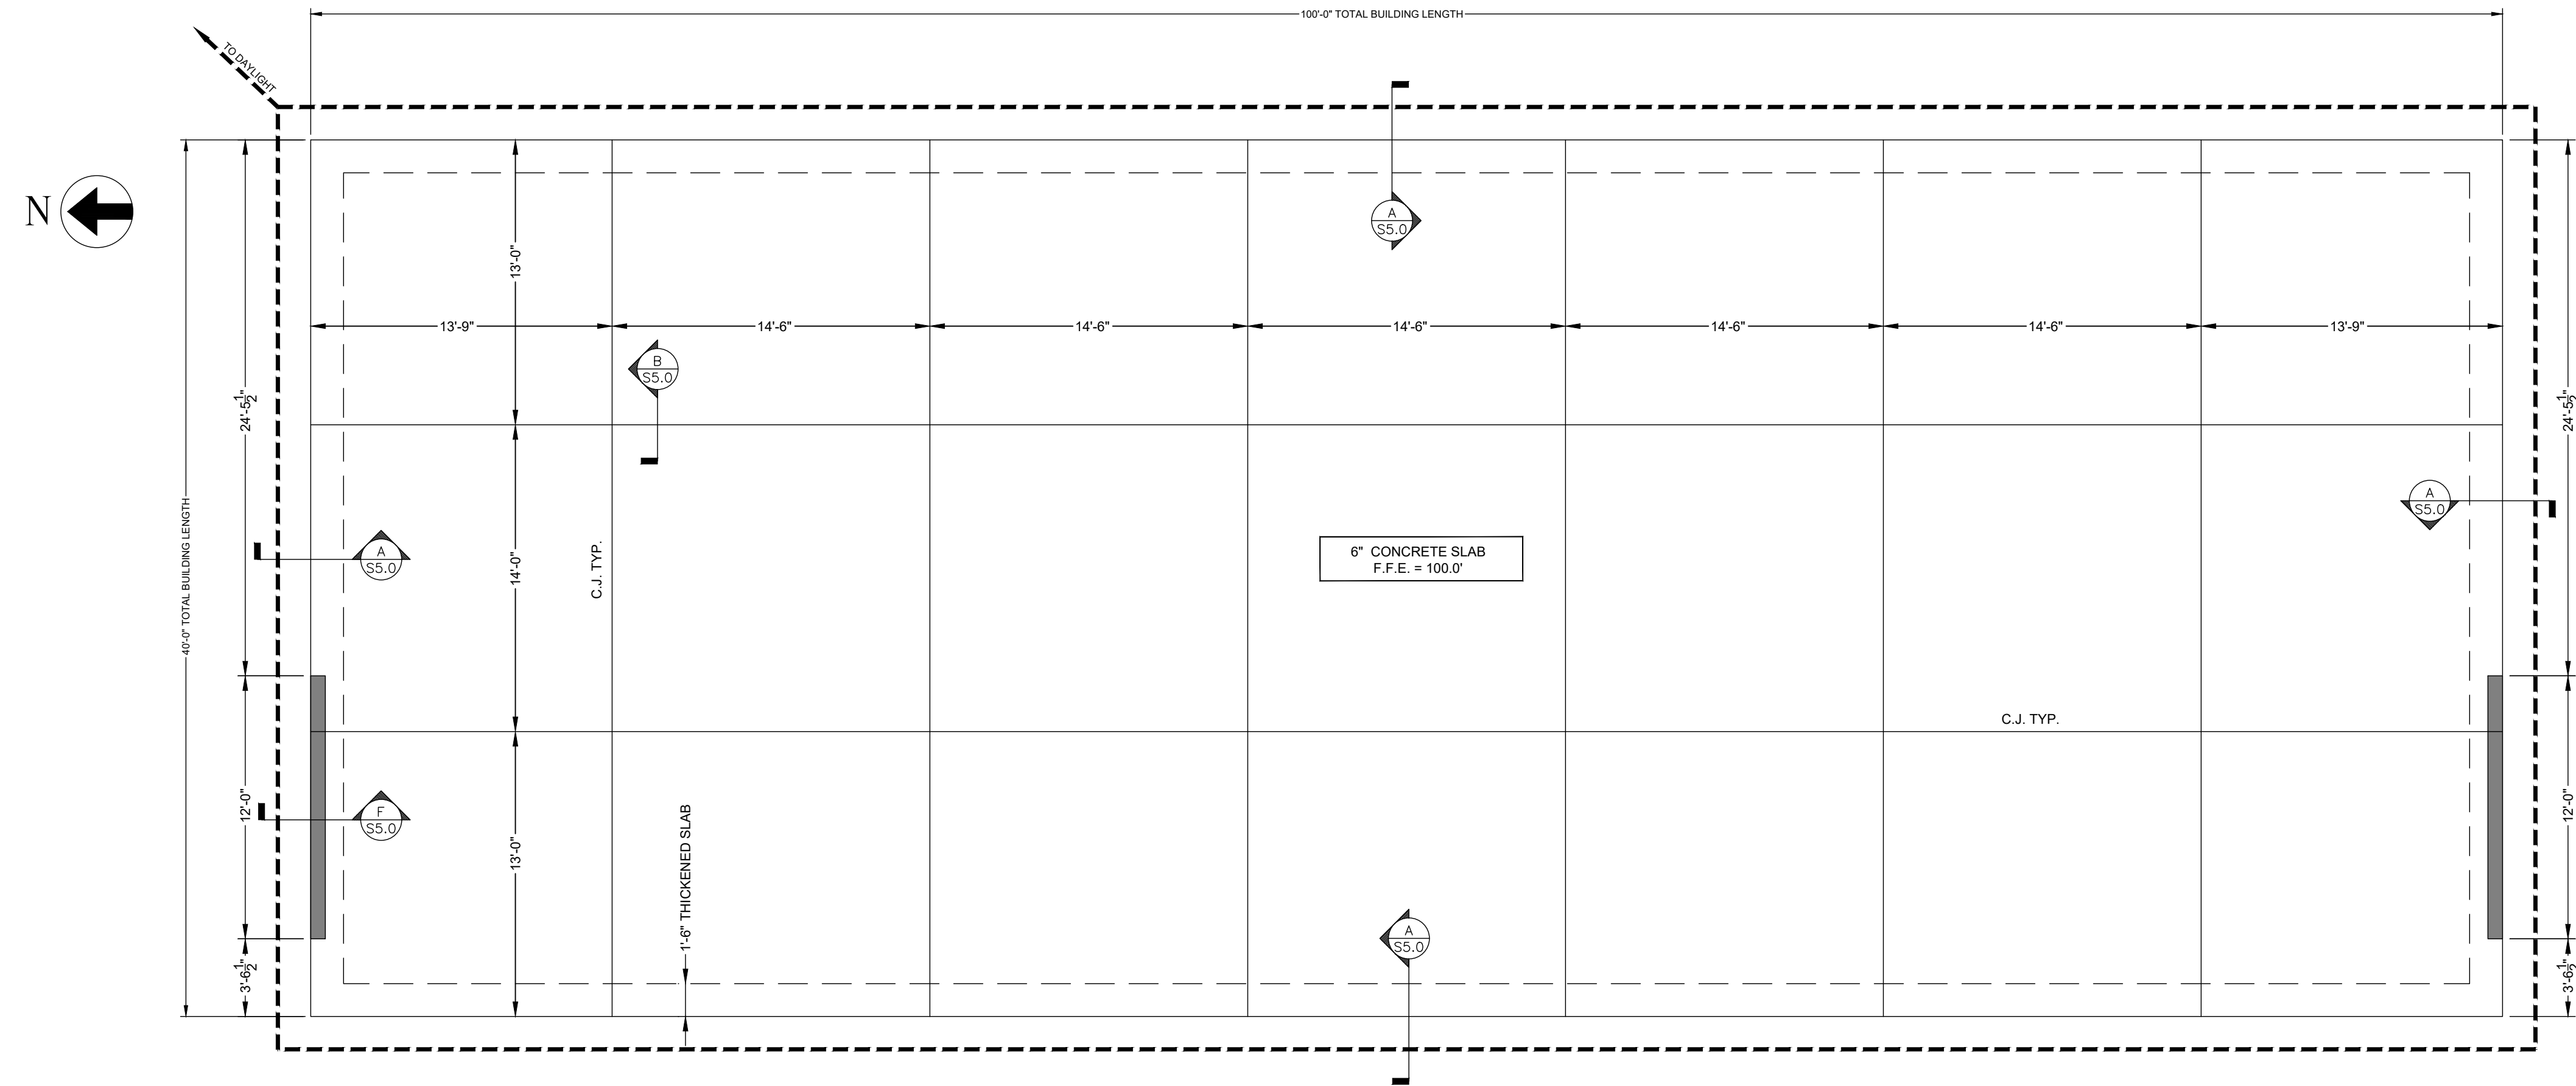C0.1
PROJECT#: 59-21



FOUNDATION PLAN
SCALE 3/16" = 1'-0"

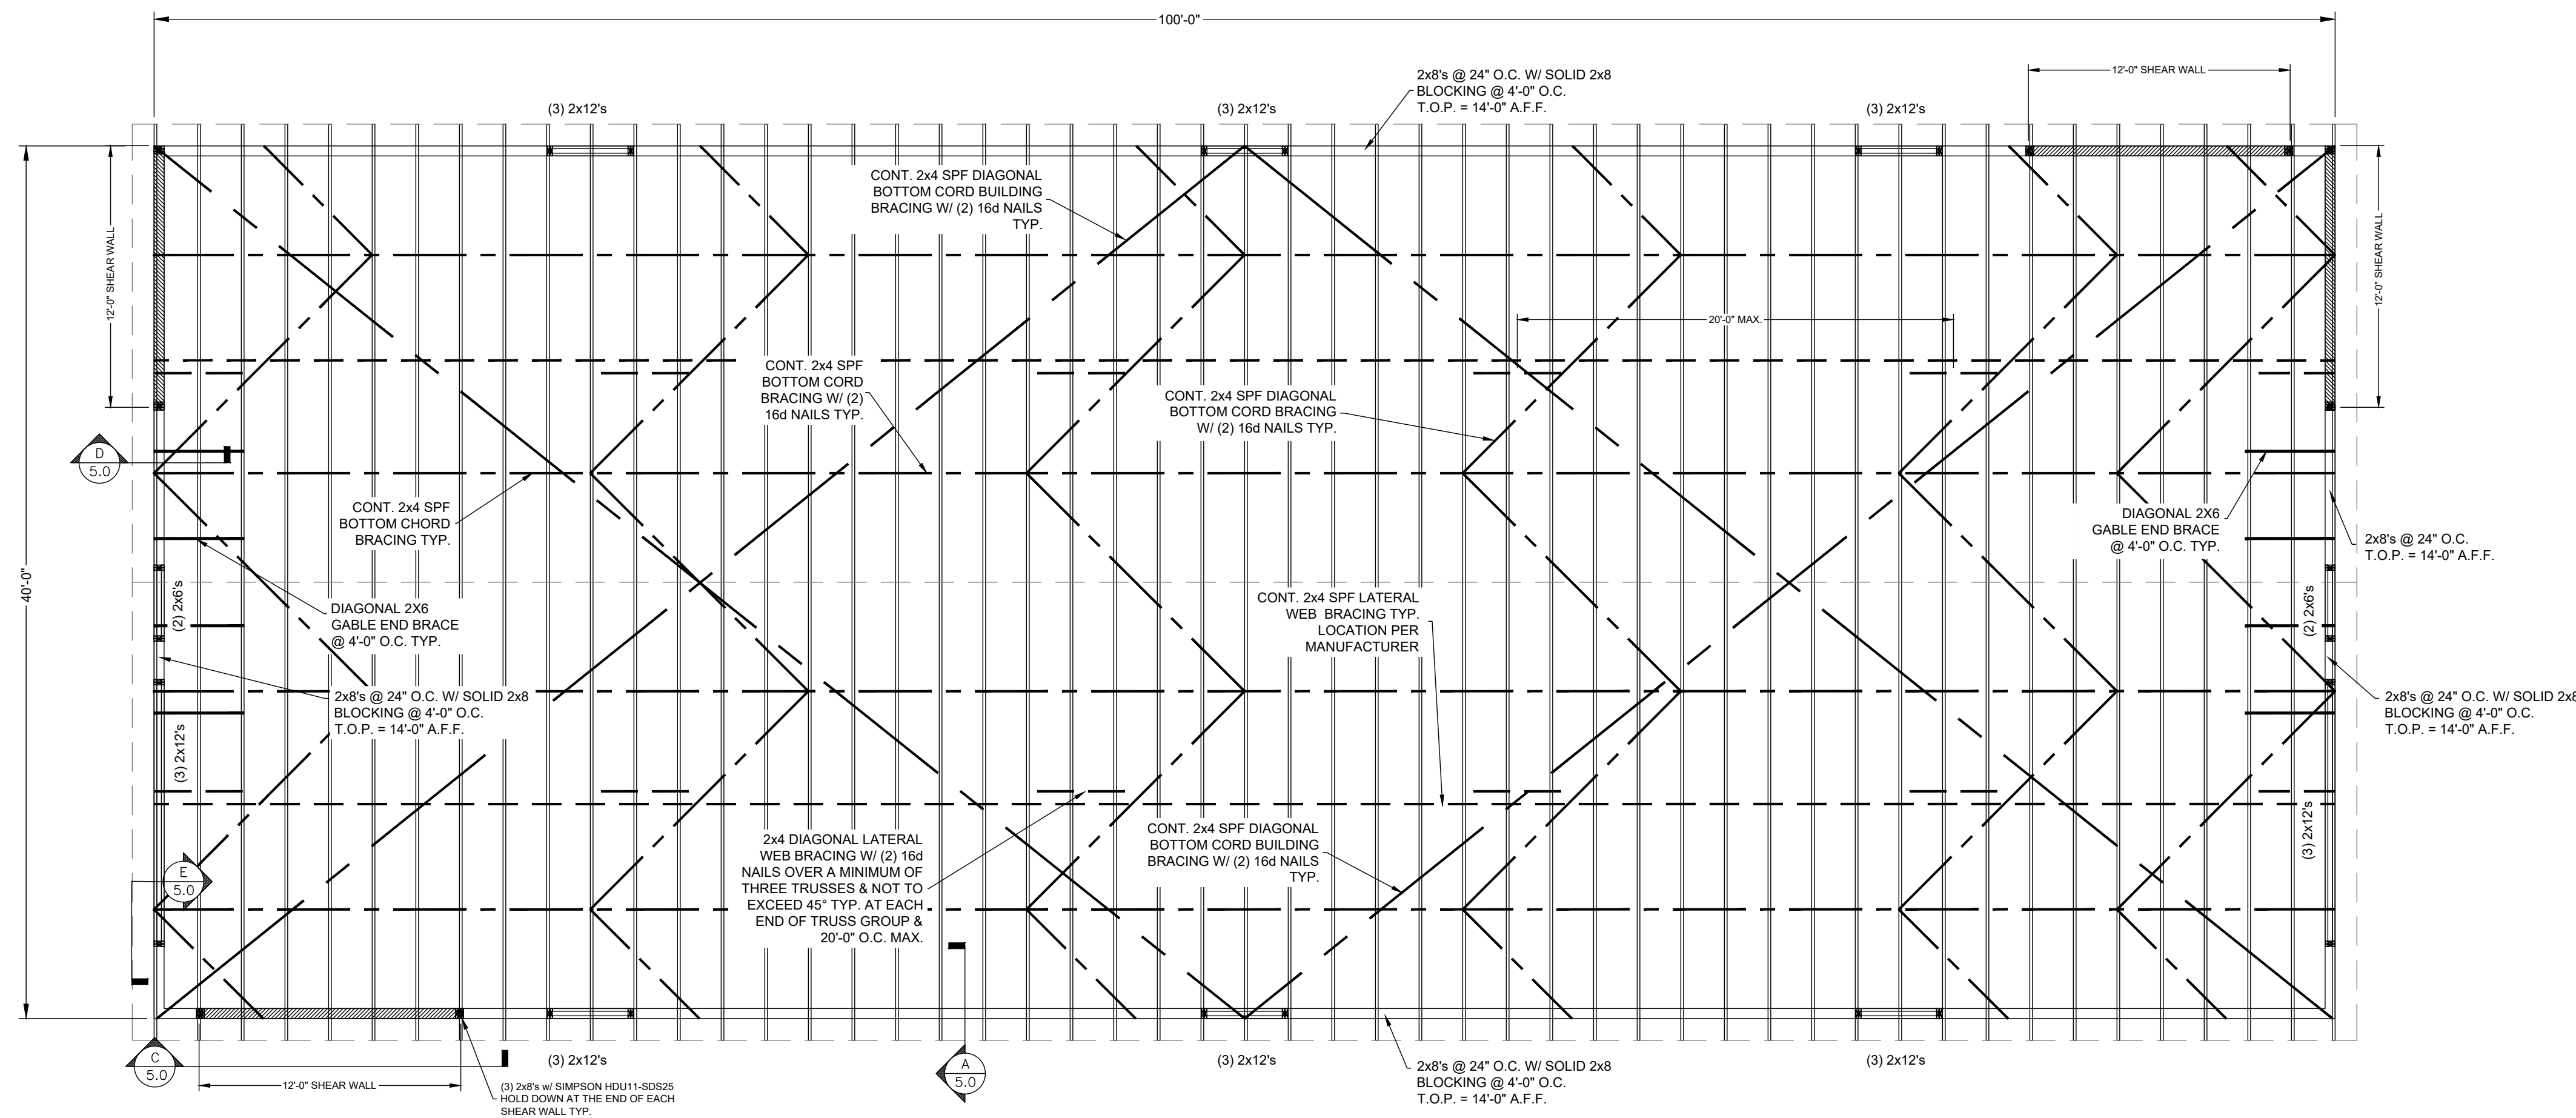


ROOF FRAMING PLAN
SCALE 3/16" = 1'-0"

BRACING LEGEND	
	GABLE END BRACE
	LATERAL WEB BRACE
	LATERAL DIAGONAL WEB BRACE
	BOTTOM CHORD BRACE

ISSUED FOR BID

REV.	APPD	DATE	STATUS
3	BEM	08-19-2022	ISSUED FOR BID
2	AEH	06-15-2021	UPDATED DETAILS PER OWNERS COMMENTS
1	AEH	05-13-2021	UPDATED DOOR SCHEDULE & FOUNDATION DETAILS
0	AEH	04-01-2021	ISSUED FOR REVIEW








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FOUNDATION & ROOF FRAMING PLAN
OF
ENFIELD STORAGE BARN
COBB ROAD
ENFIELD, MAINE
FOR
MAINE DEPT OF INLAND FISHERIES & WILDLIFE
41 STATE HOUSE STATION
AUGUSTA, MAINE

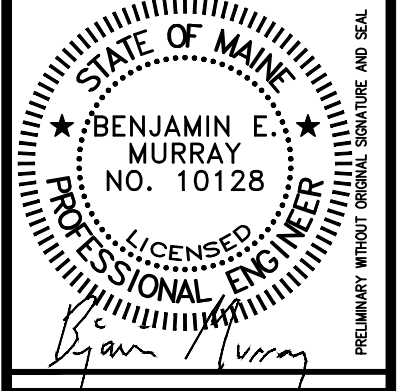
DRAWN	CHECKED
MG	AEH
SCALE	DATE
AS NOTED	04-01-2021

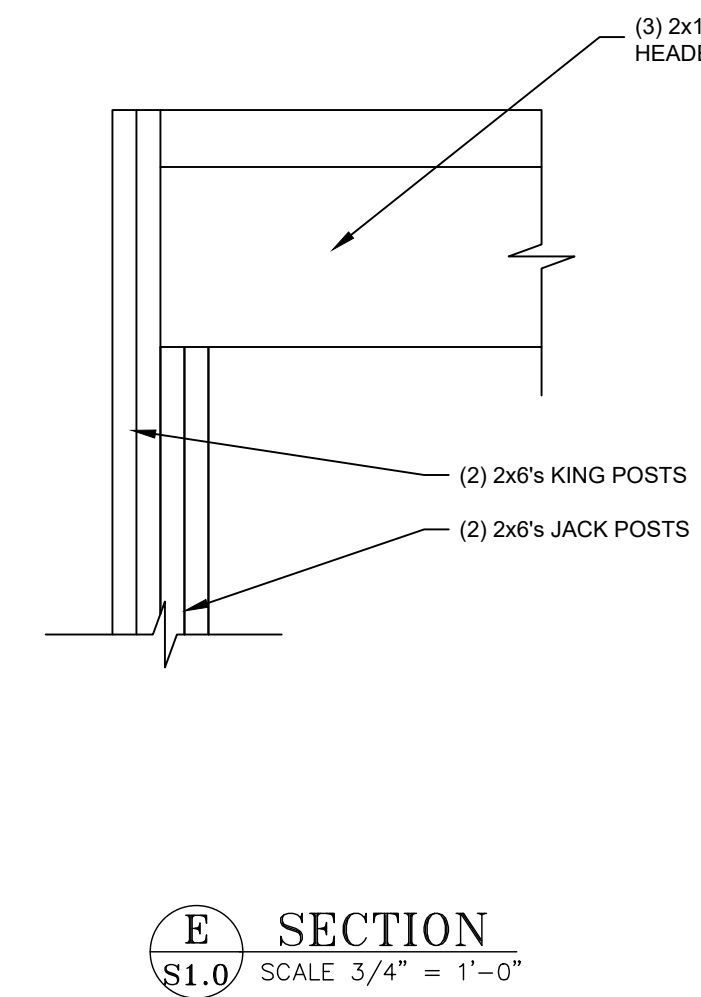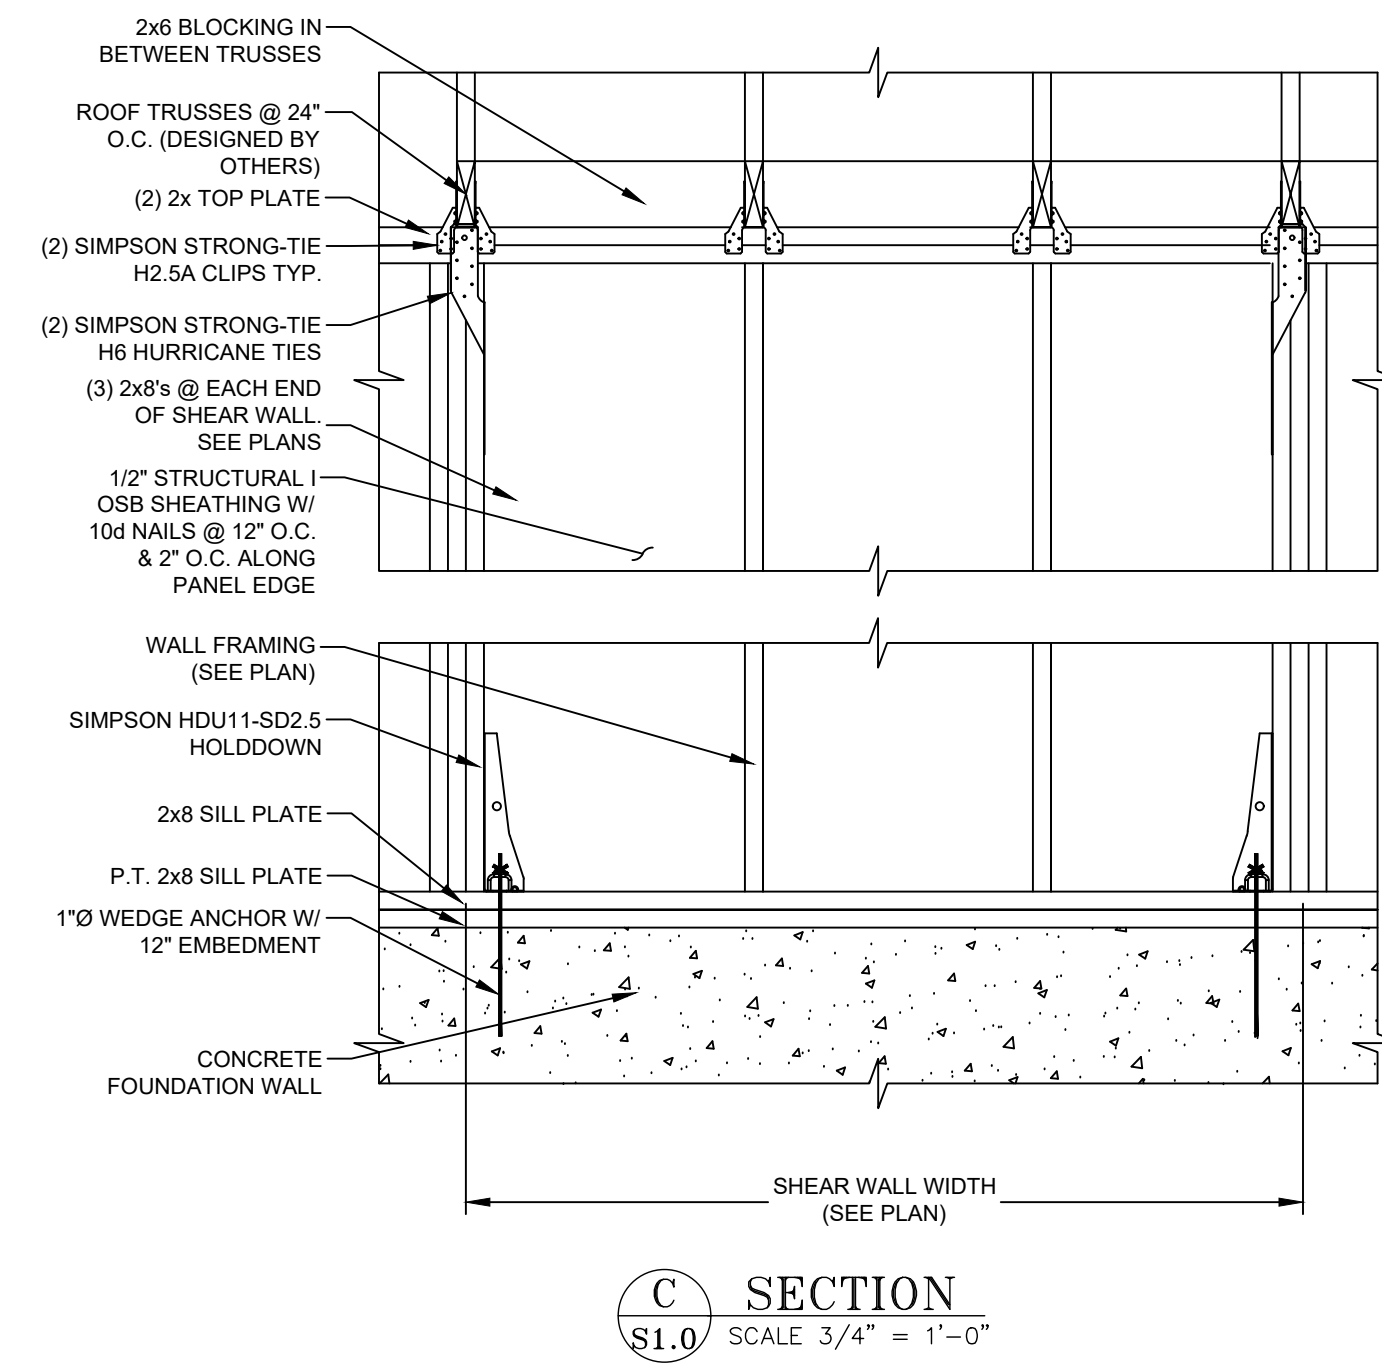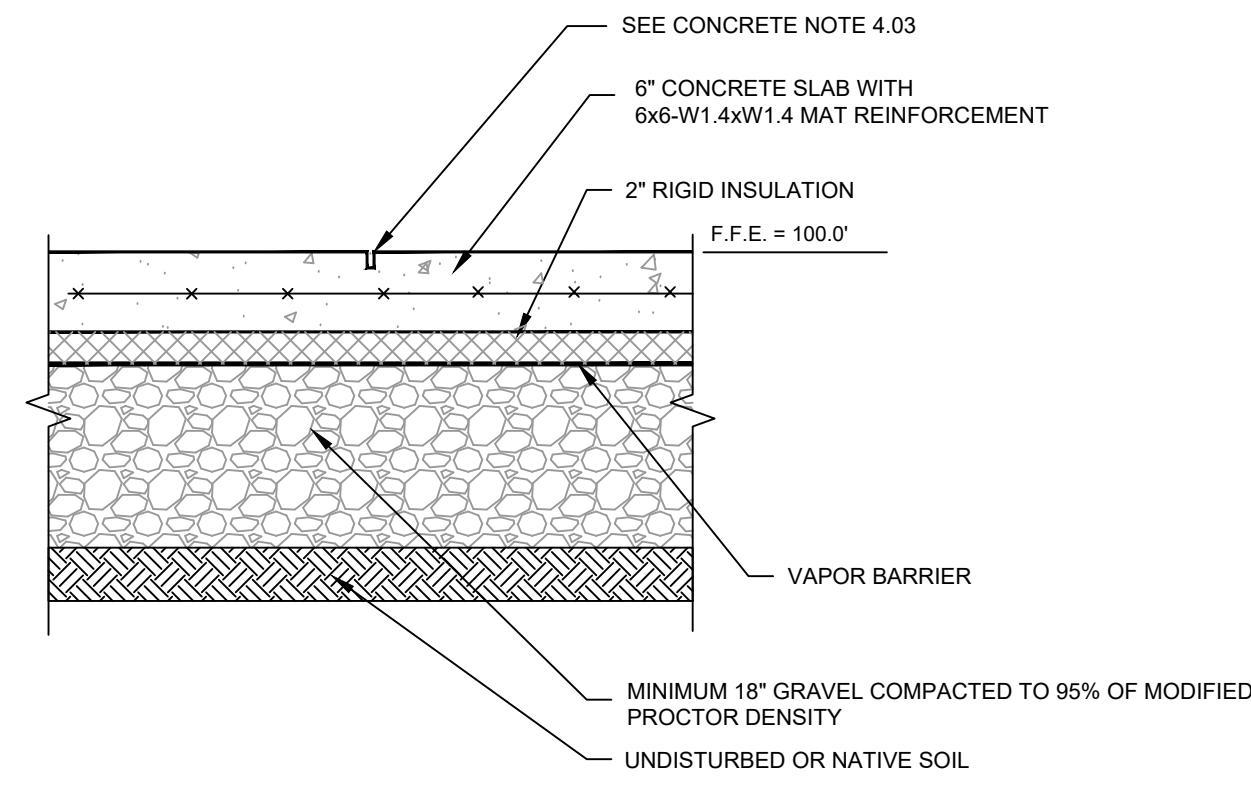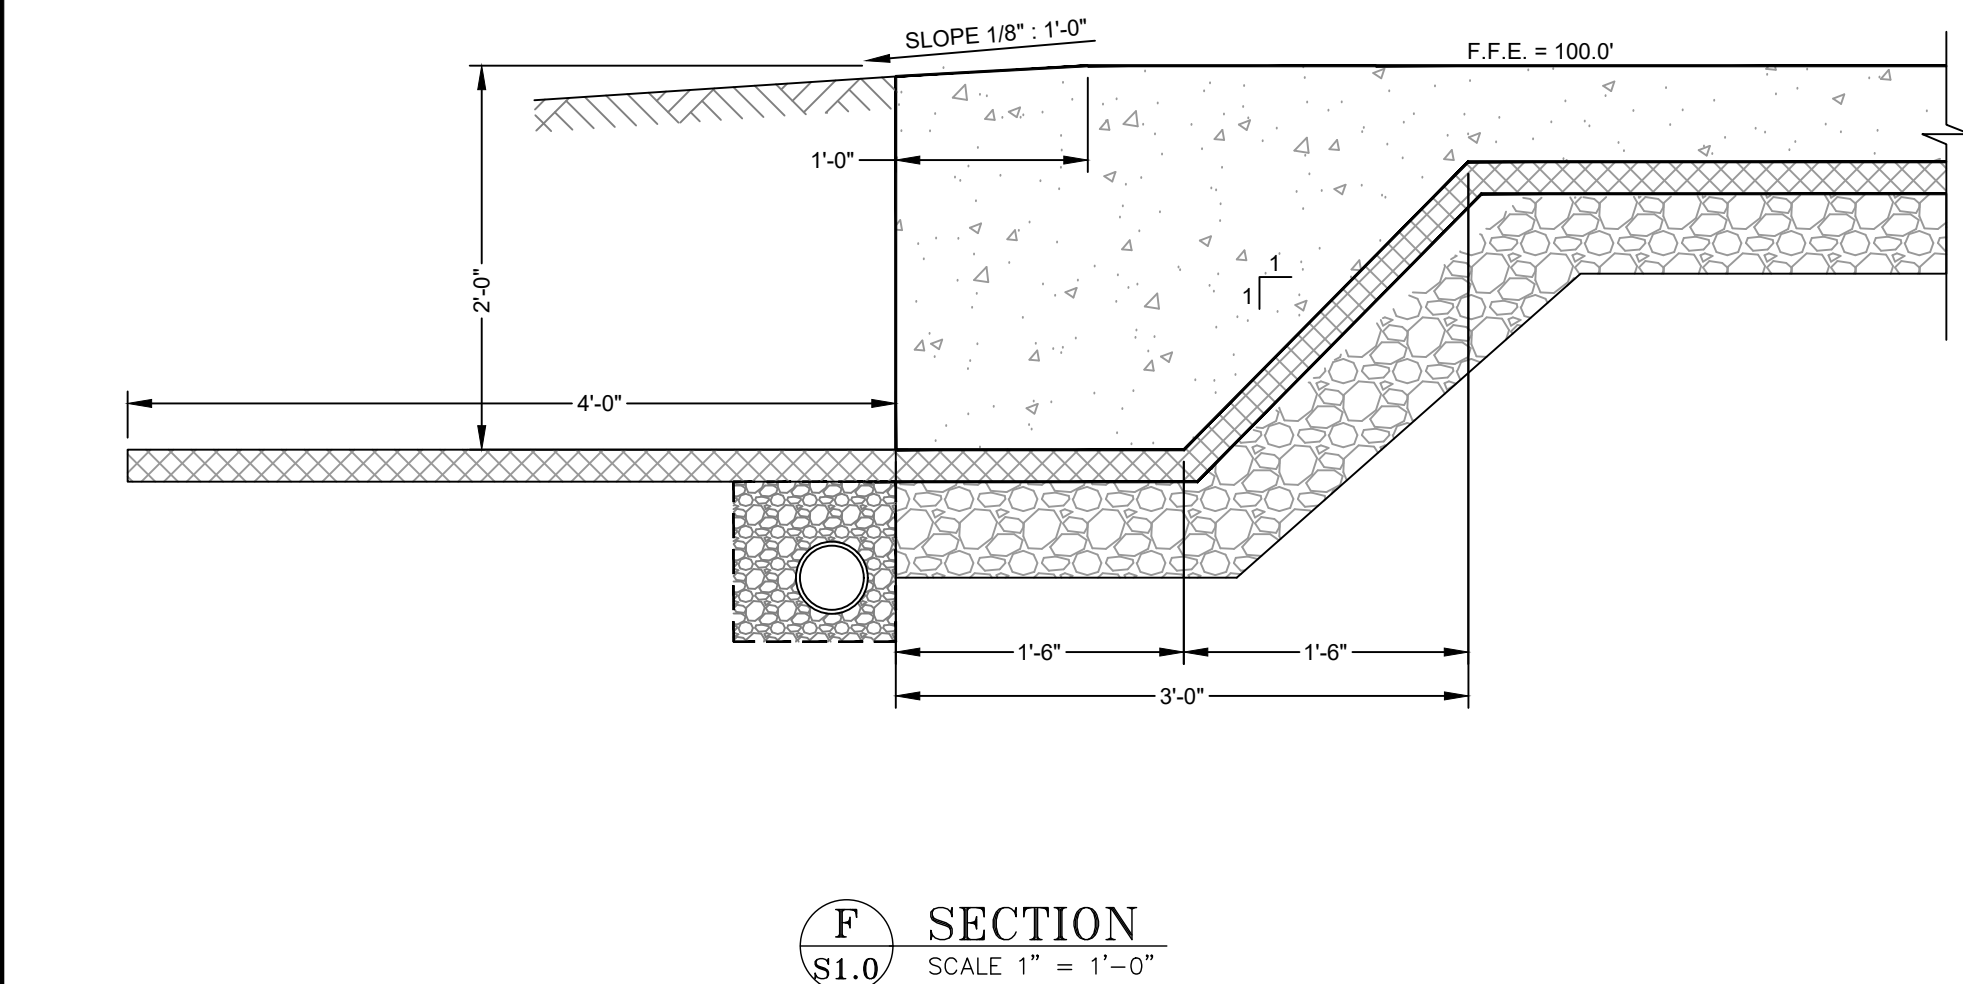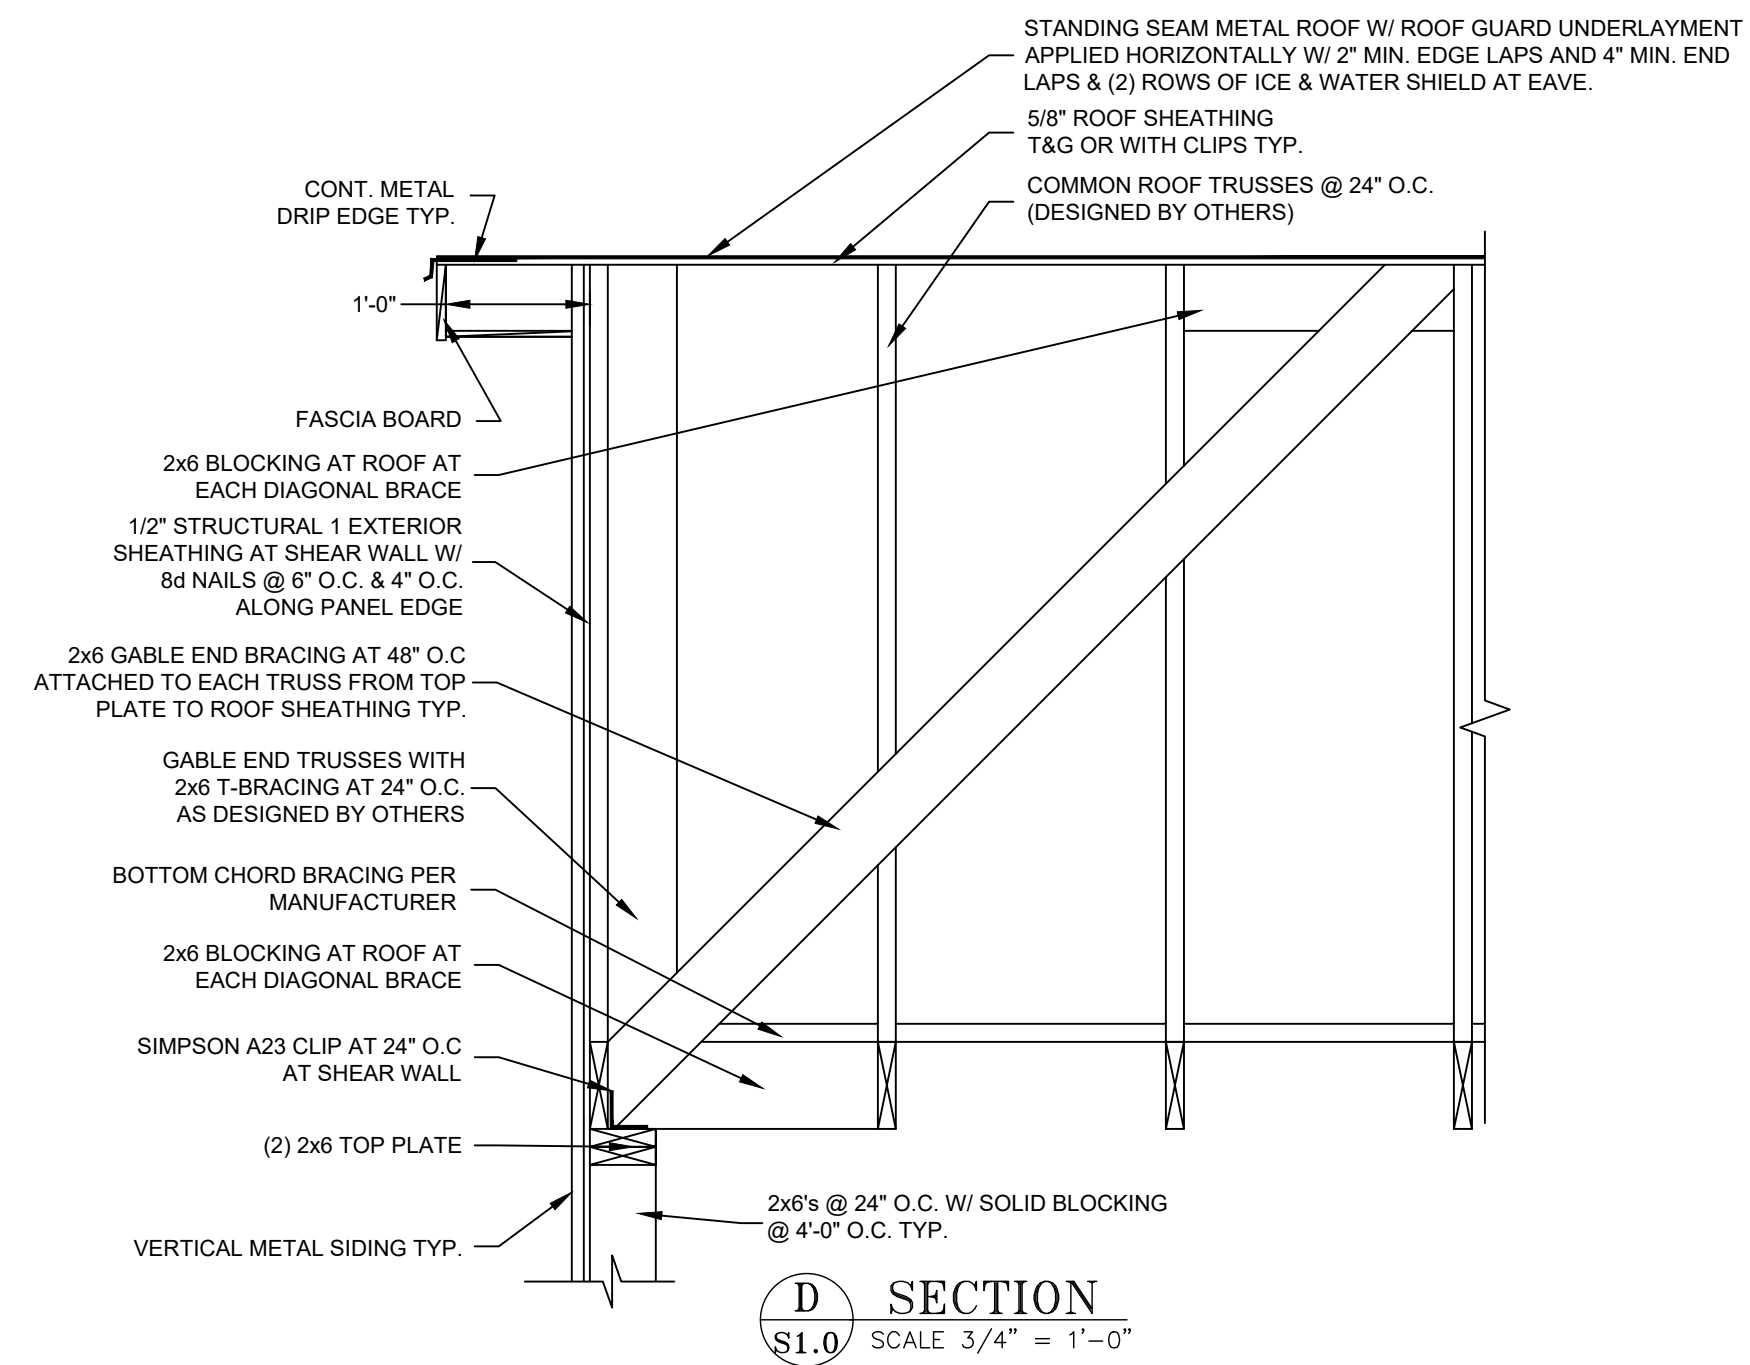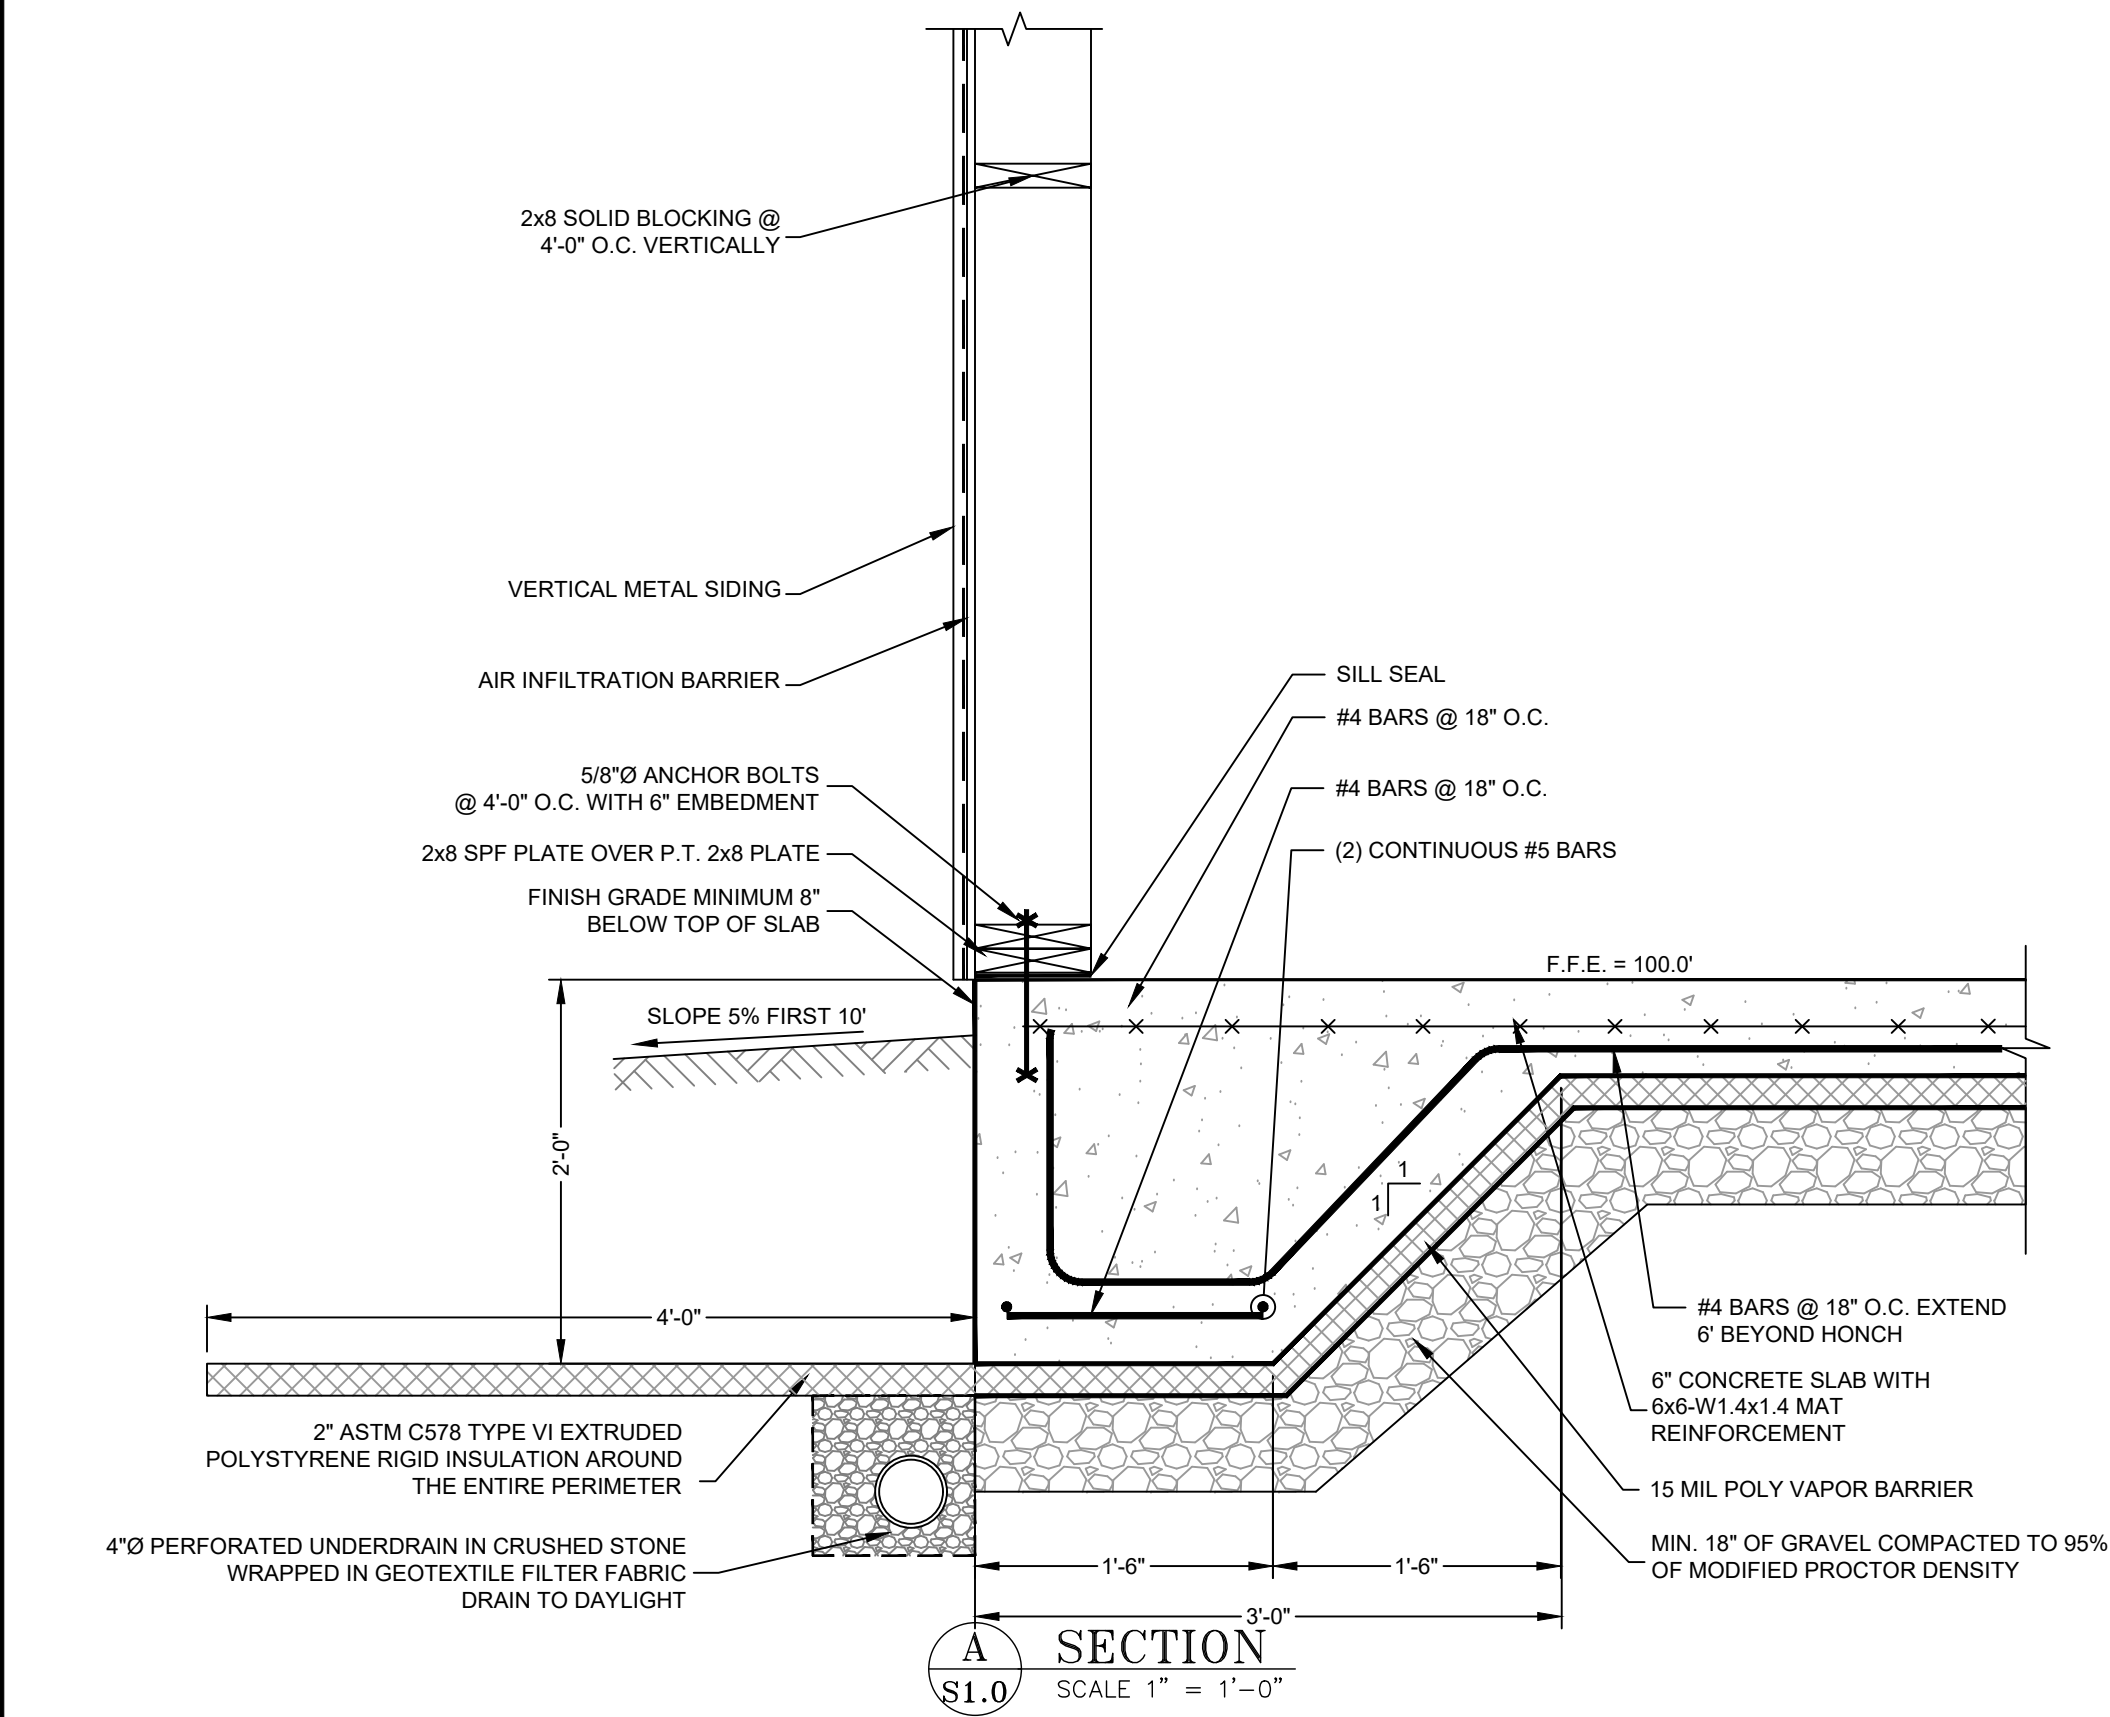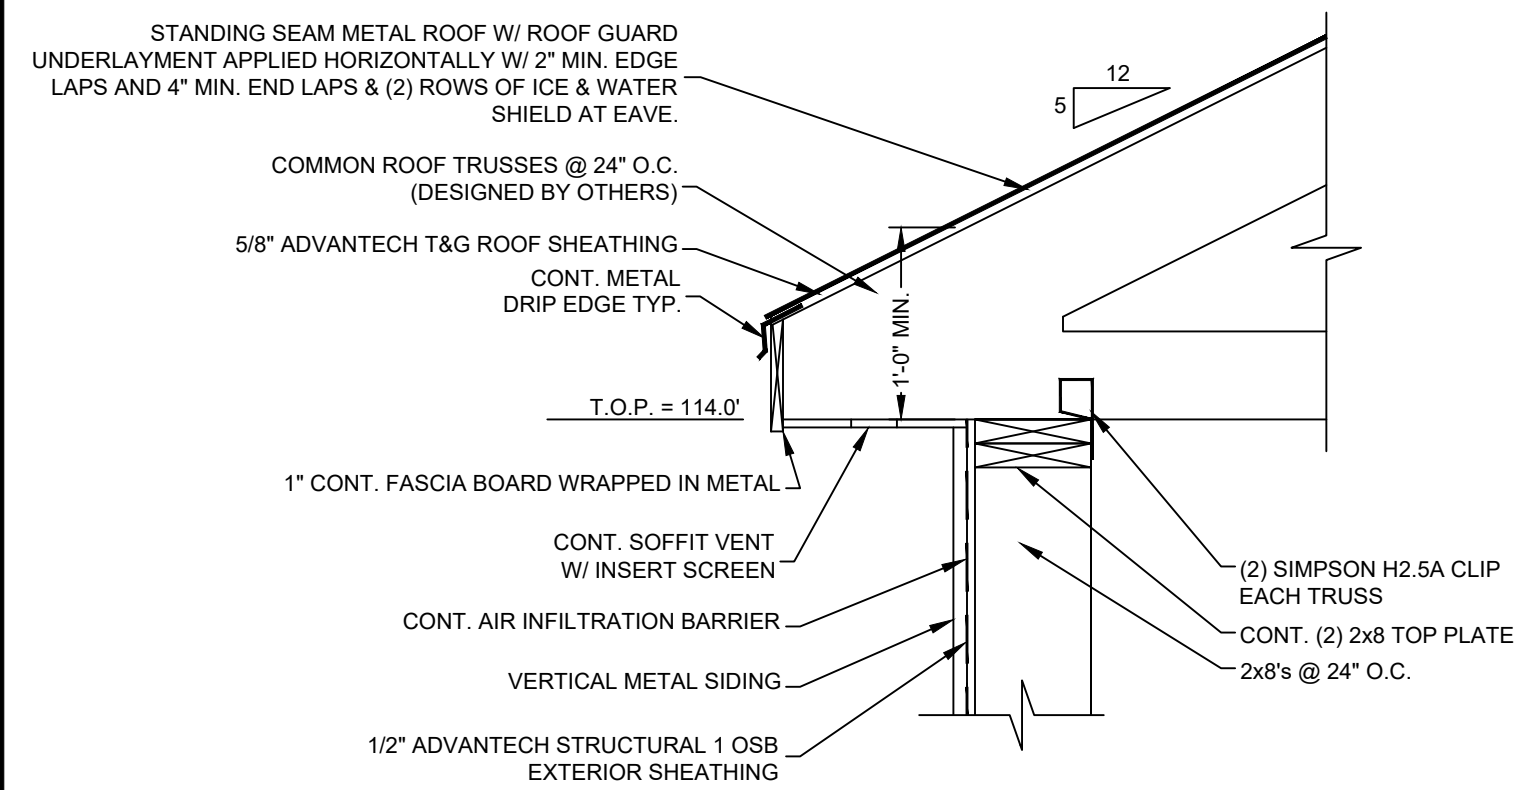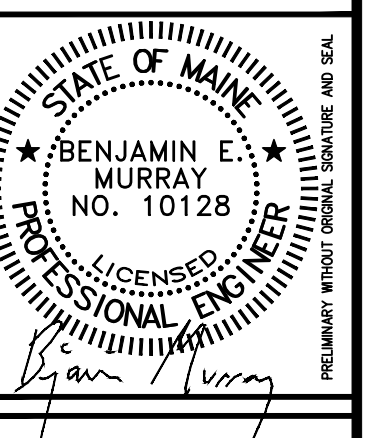S1.1
PROJECT#: 59-21



REV.	APPD	DATE	STATUS	ISSUED FOR BID
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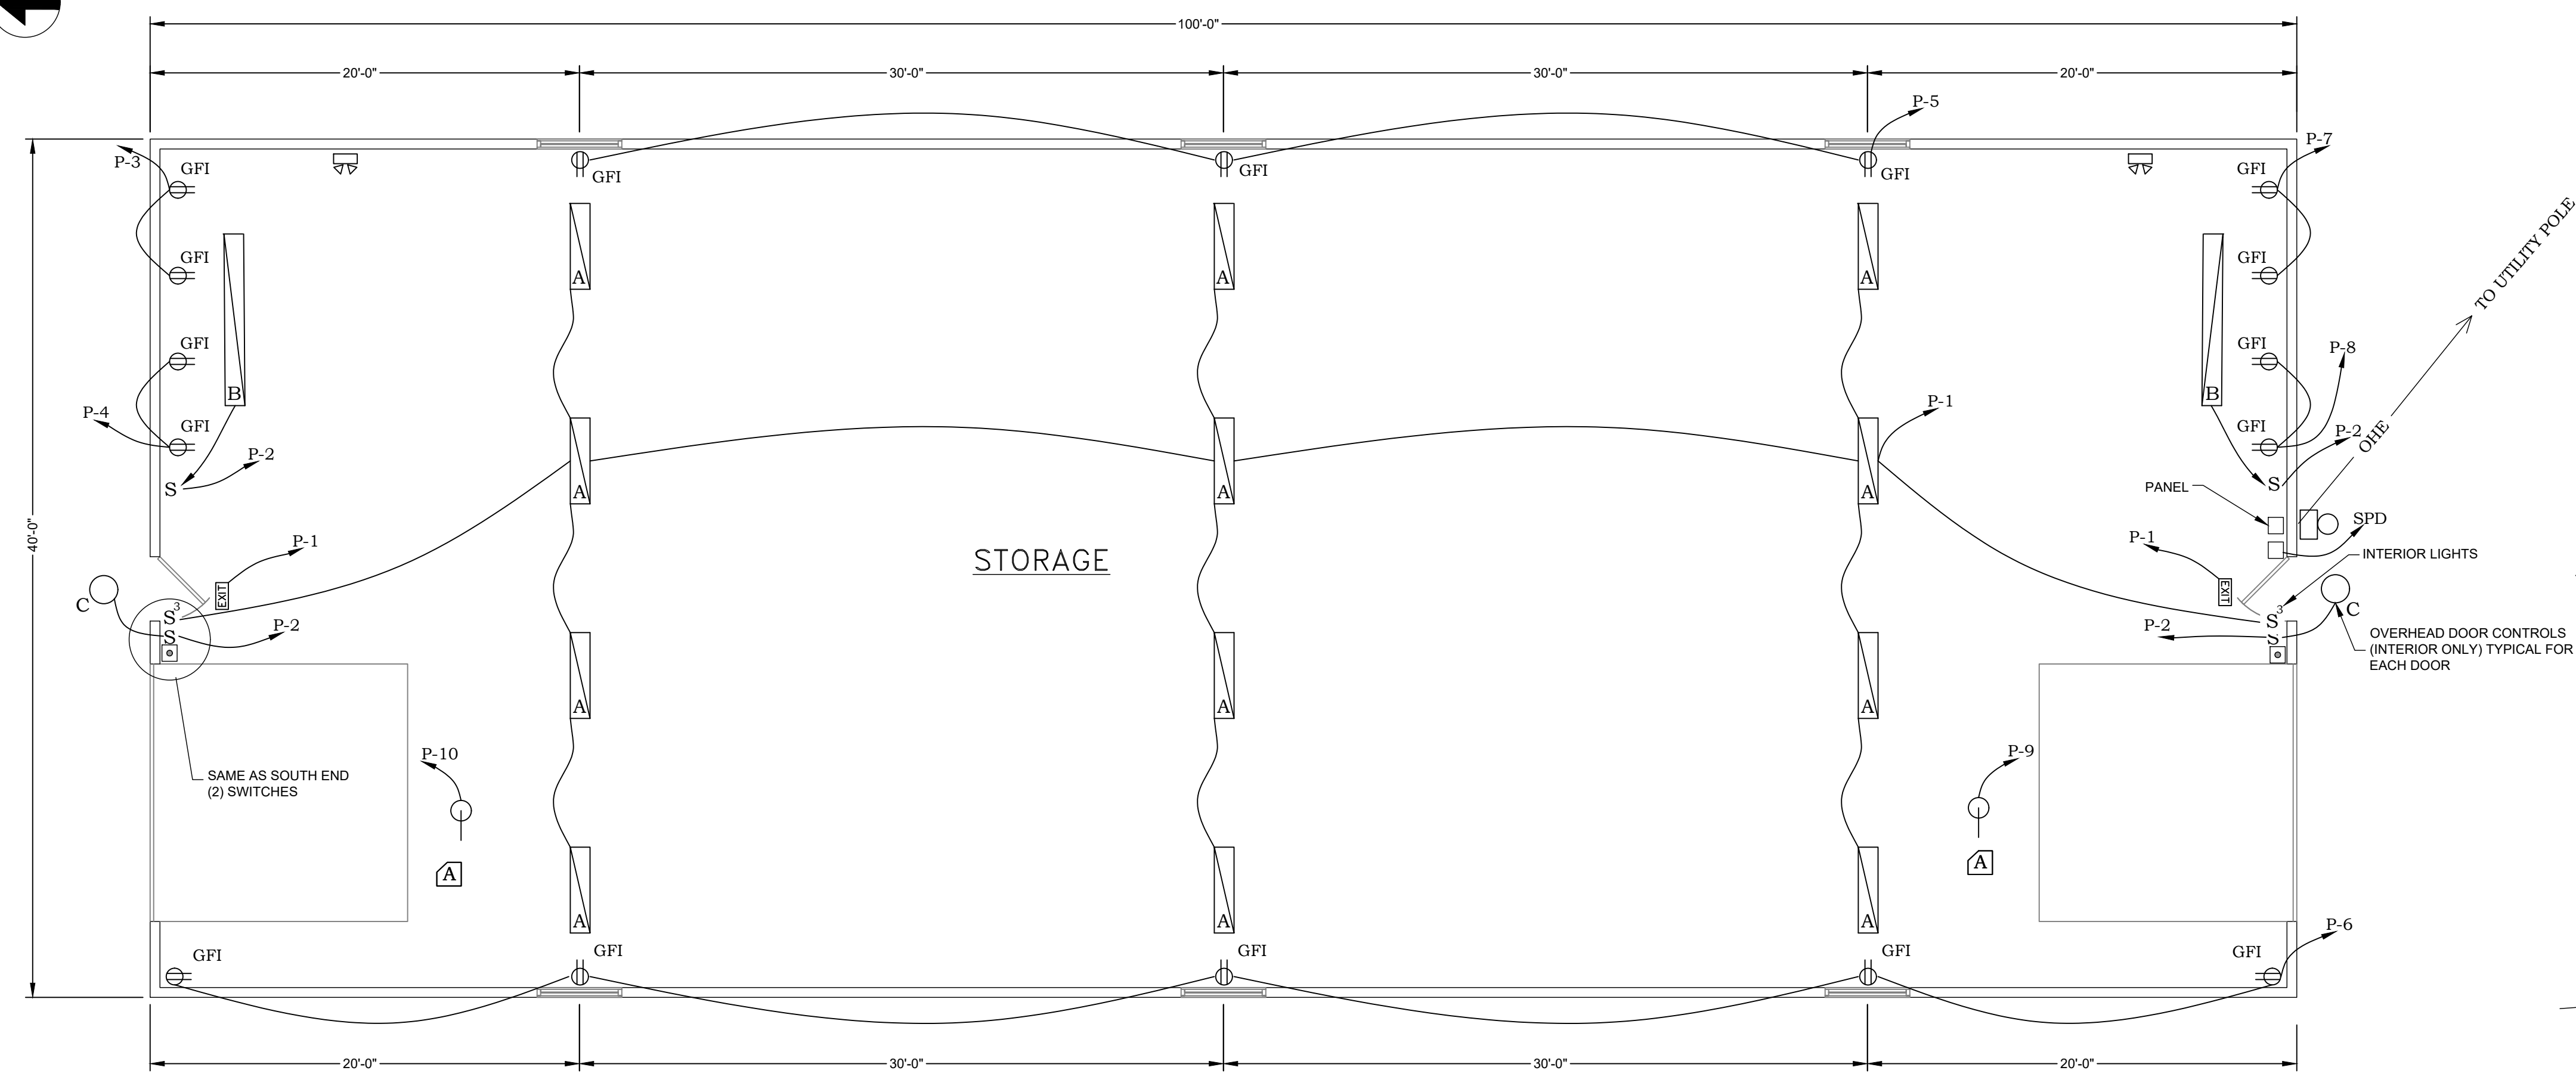
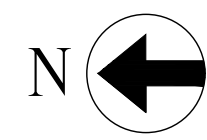
ISSUED FOR BID

DETAILS
OF
ENFIELD STORAGE BARN
COBB ROAD
ENFIELD, MAINE
FOR
MAINE DEPT OF INLAND FISHERIES & WILDLIFE
41 STATE HOUSE STATION
AUGUSTA, MAINE

DRAWN	CHECKED
MG	AEH
SCALE	DATE
AS NOTED	04-01-2021

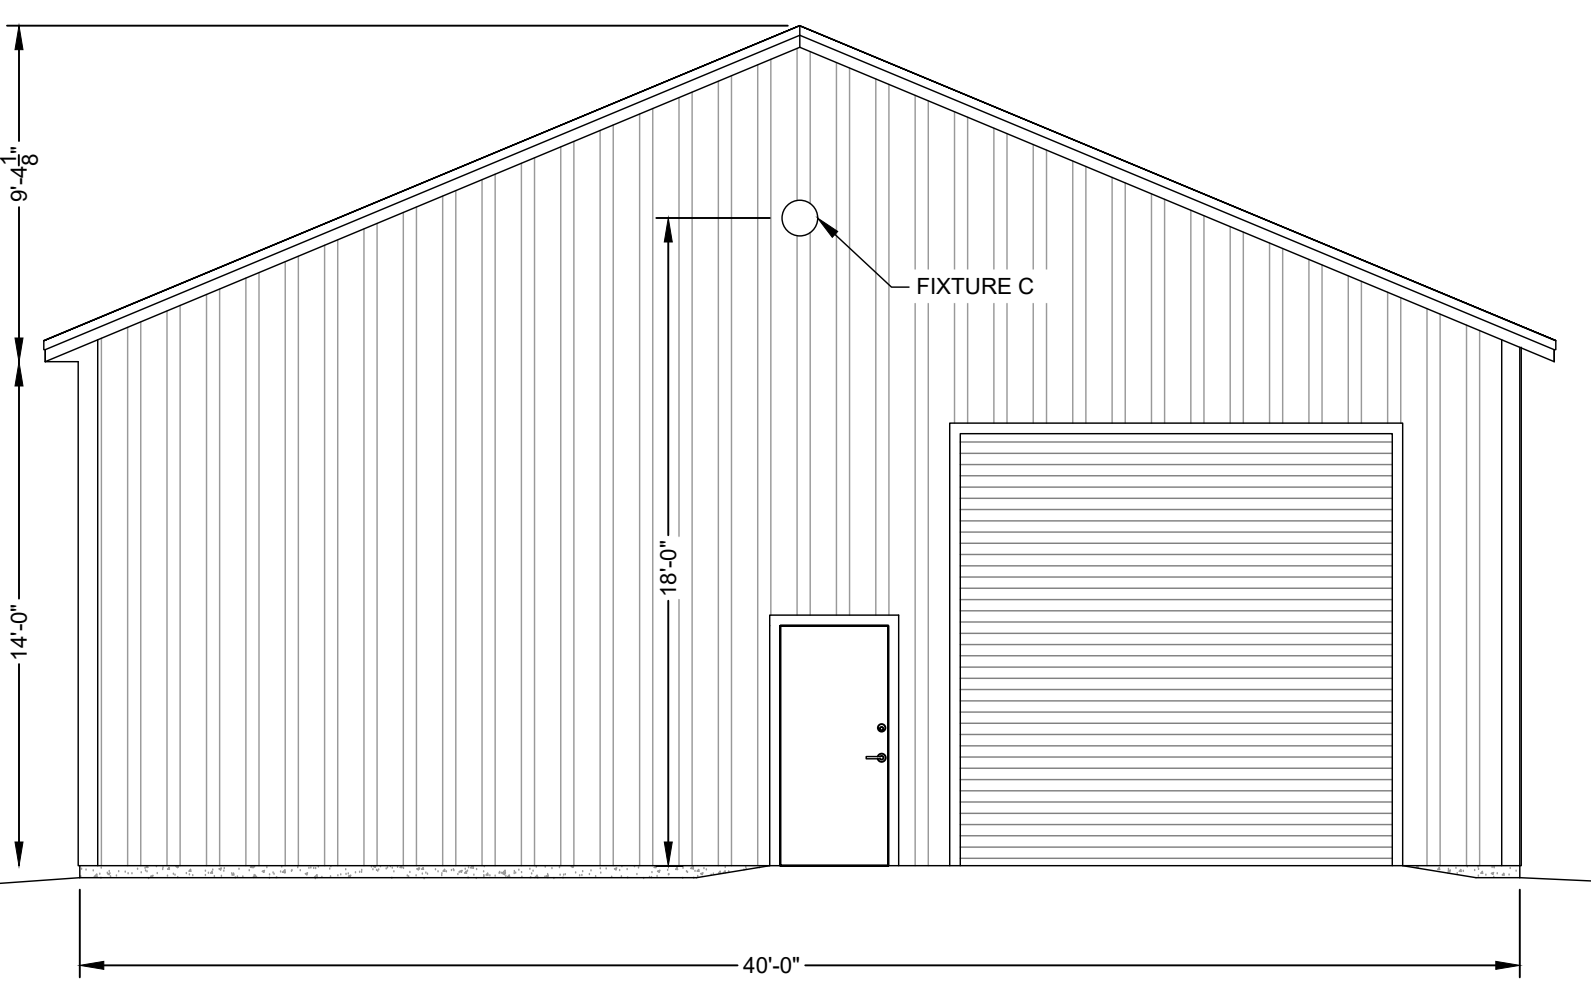
S5.0

PROJECT#: 59-21



NOTE:
CONTRACTOR SHALL PERFORM VOLTAGE DROP CALCULATIONS FOR INTERIOR LIGHTING CIRCUIT AND RECEPTACLE CIRCUITS AND PROVIDE CONDUCTORS THAT LIMIT THE VOLTAGE DROP TO A MAXIMUM OF 3%. CALCULATIONS SHALL BE SUBMITTED WITH SHOP DRAWINGS FOR ENGINEERS APPROVAL.

ELECTRICAL PLAN
SCALE 3/16" = 1'-0"





NORTH ELEVATION
SCALE 3/16" = 1'-0"


FIXTURE SCHEDULE				
TYPE	FIXTURE MAKE	FIXTURE MODEL	MOUNTING	LAMPING
A	LITHONIA	ZL1N L48 5000LM FST MVOLT 50K 80 CRI WH	SURFACE ON BOTTOM OF TRUSS	21.7W/LED
B	LITHONIA	TZL1N L96 6000LM FST MVOLT 50K 80CRI WH	BRACKET FROM WALL AT 10FT AFF	64W/LED
C	RAB	WPLED 4T 78 N WITH SMS 500 MOTION CONTROLLER	WALL 18 FT AFG	78W/LED
EXIT	LITHONIA	LV S W I R 120 UM CW	WALL ABOVE DOOR	2.3W/LED

PANEL SCHEDULE - A SURFACE MOUNTED				
100 AMP MCB, 240/120 VOLT, 1 PHASE, 3 WIRE, 60 HZ				
CIRCUIT NO.	DESCRIPTION	NO. POLES	RATING	LOAD
1	INTERIOR LIGHTS	1	20*	0.9
2	INTERIOR BENCH AND EXTERIOR LIGHTS	1	20*	0.3
3	RECEPT - M	1	20	0.4
4	RECEPT - M	1	20	0.6
5	RECEPT - E	1	20	1.0
6	RECEPT - W	1	20	0.4
7	RECEPT - S	1	20	0.4
8	RECEPT - S	1	20	0.5
9	OH DOOR S	1	20	0.5
10	OH DOOR N	1	20	
11,13	SPD	2	**	
12-14	SPARE	1	20	
15,16	SPARE	1	20	
17-24	SPACE	-	20	

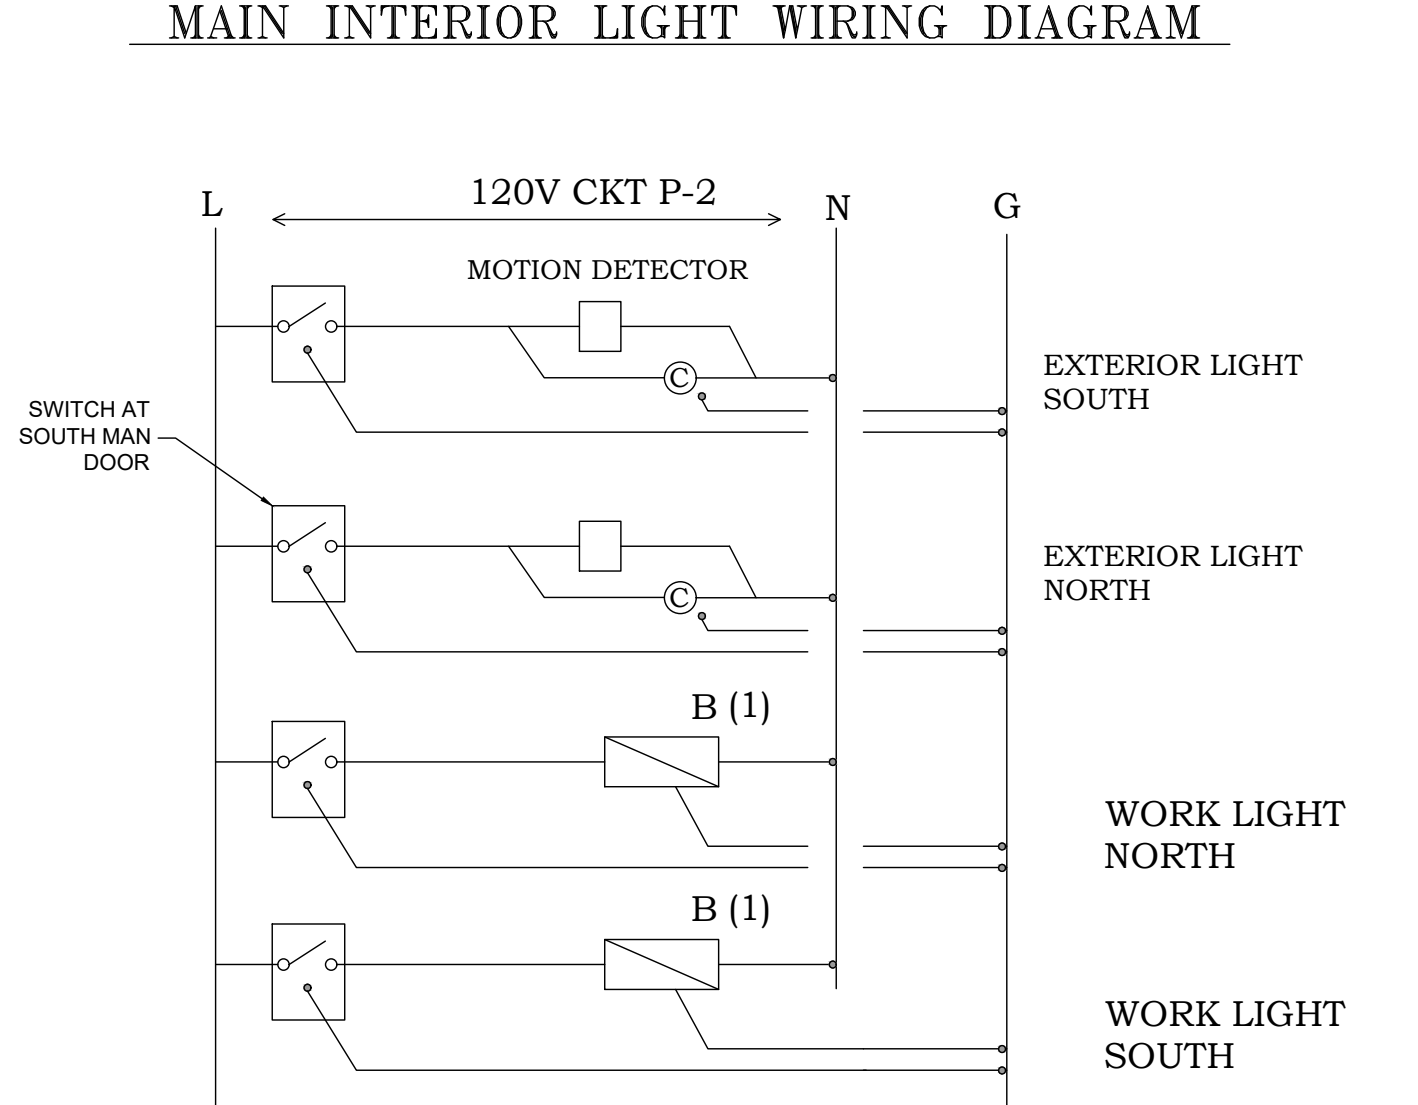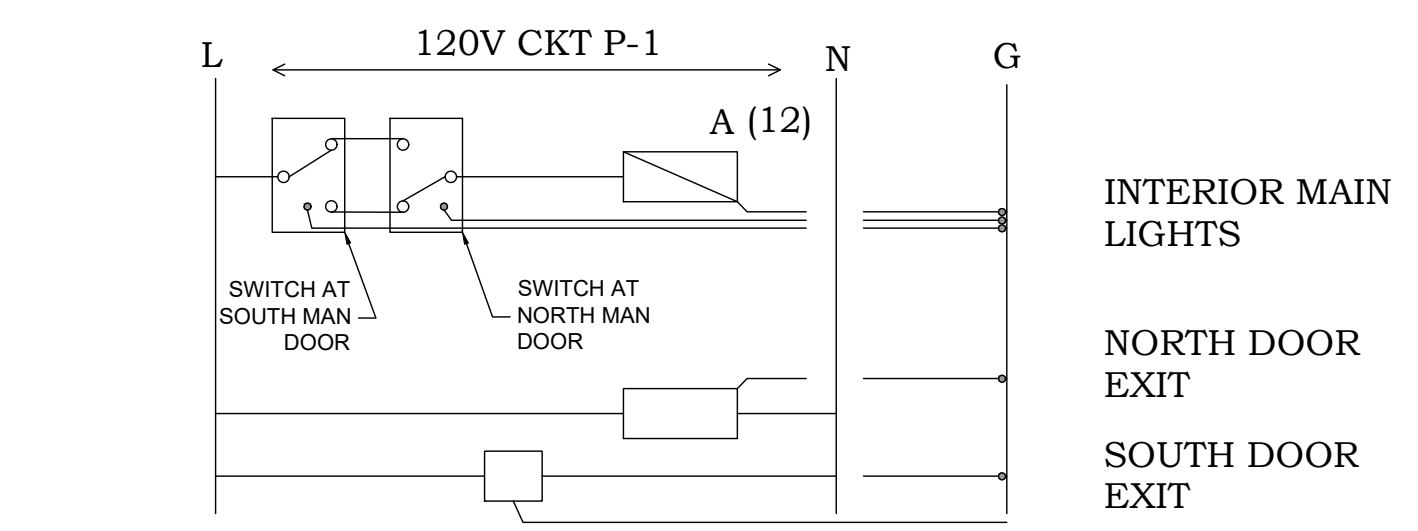
* PROVIDE HANDLE LOCK ON CIRCUITS
** RATING PER SPD MANUFACTURER RECOMMENDATION



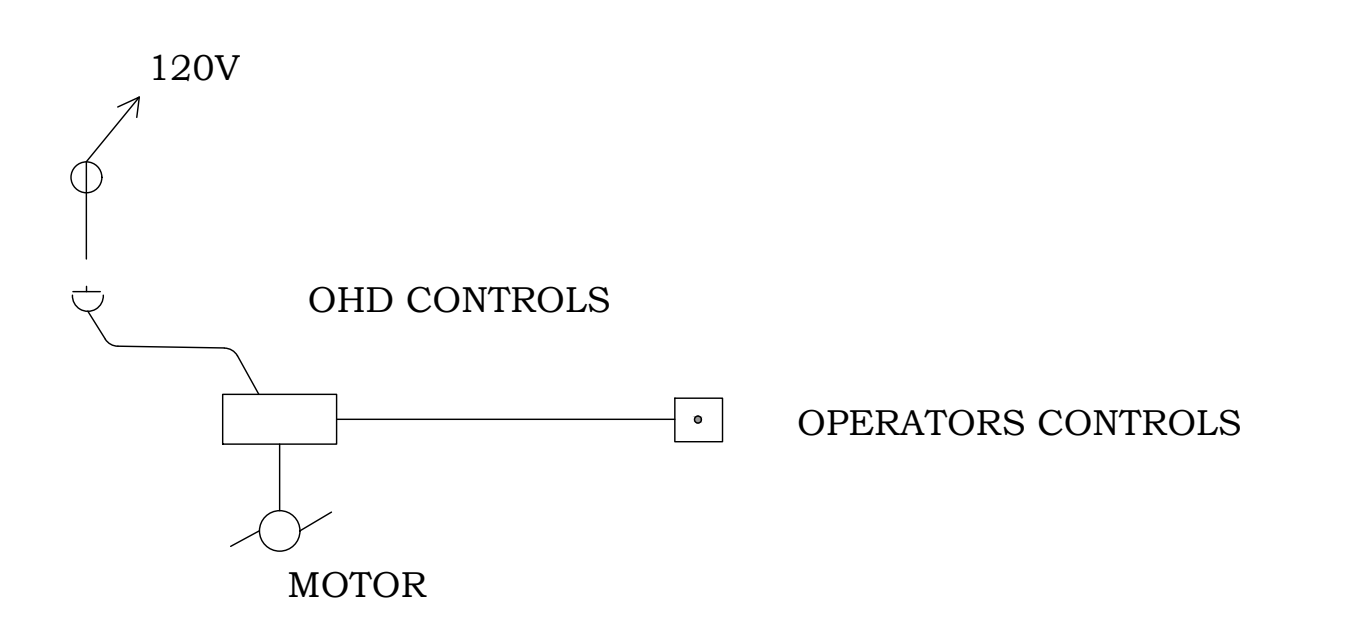
WORK AND EXTERIOR LIGHTING WIRING DIAGRAM



TYPICAL OHD INTERCONNECTION DIAGRAM

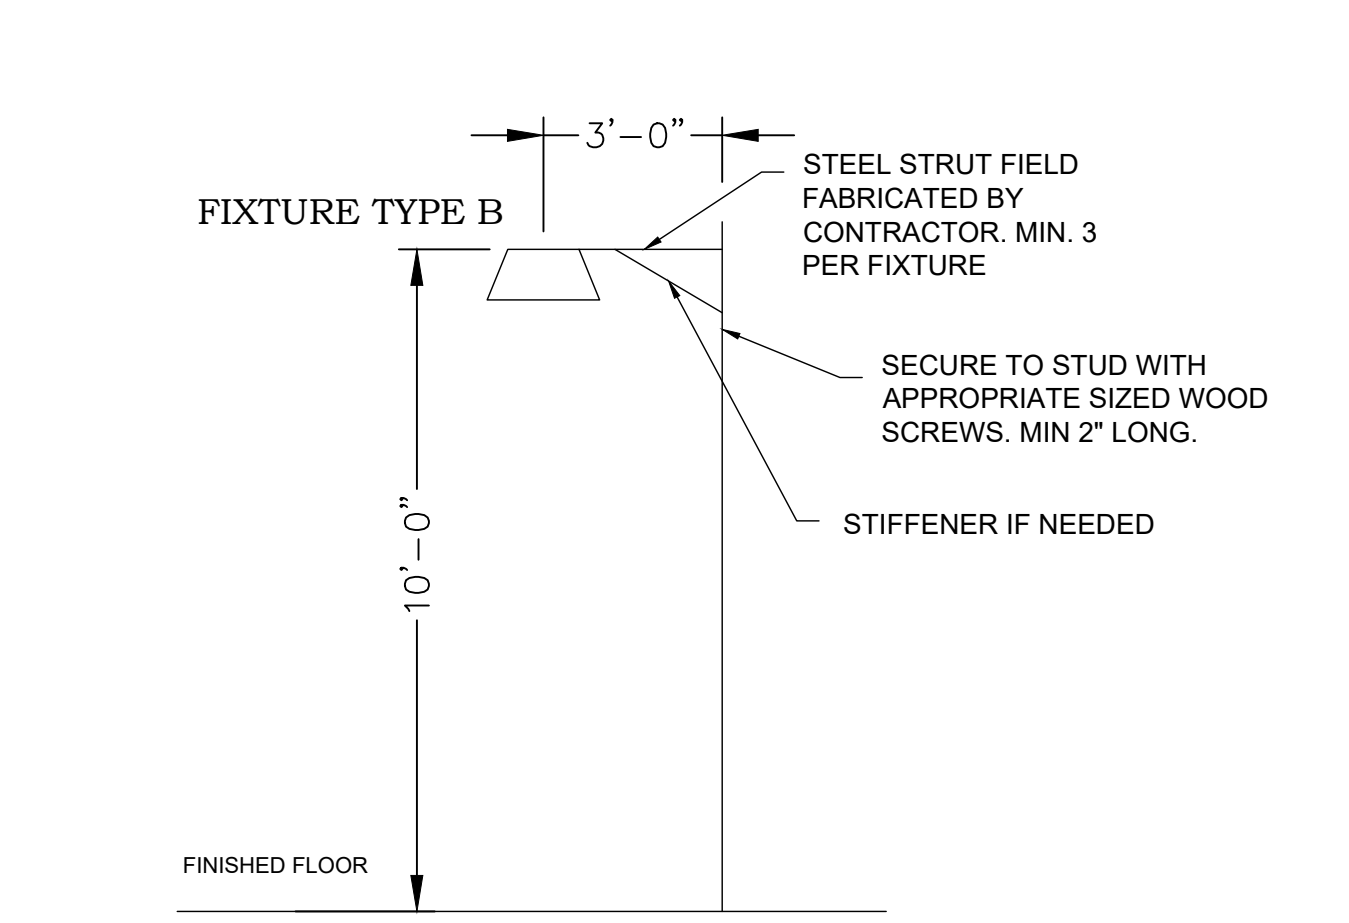

TYPICAL WORK LIGHT MOUNTING PROPOSED

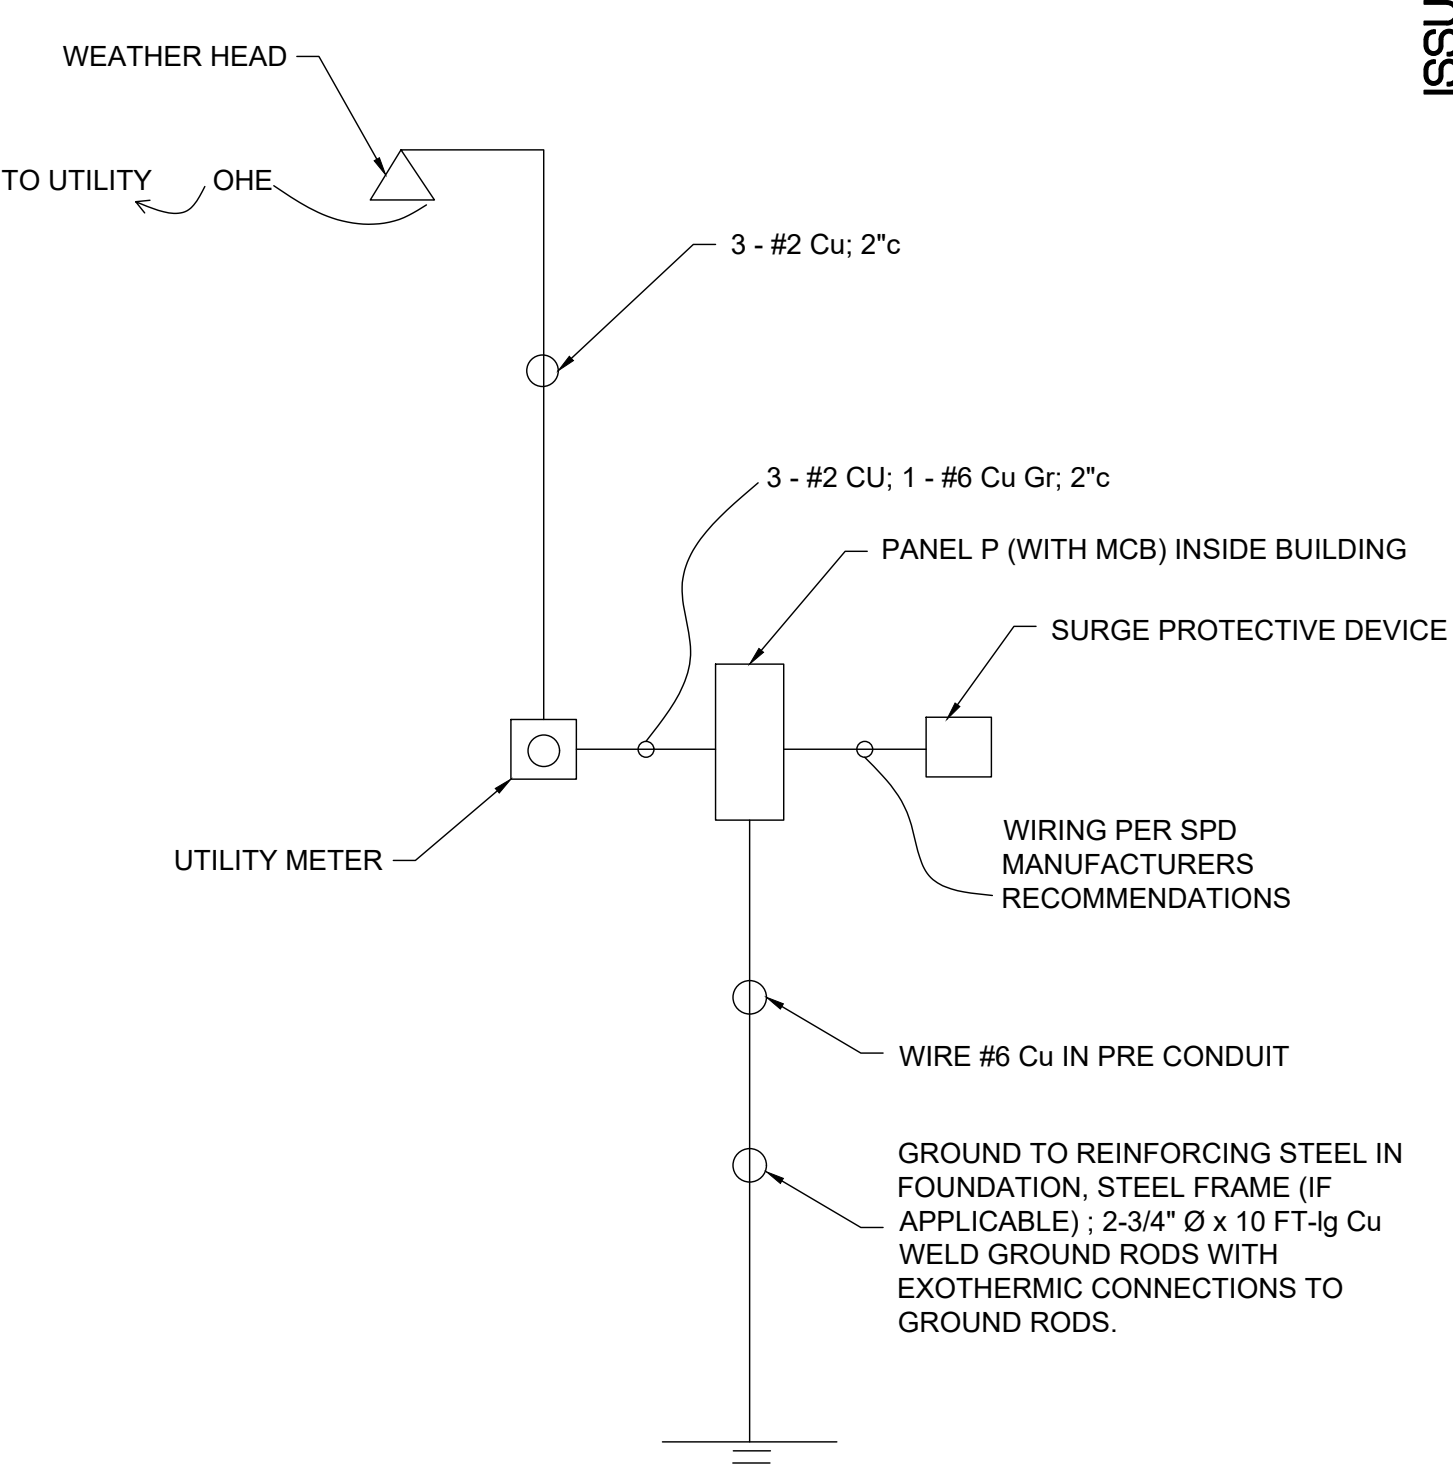

ELECTRIC SERVICE INTERCONNECTION DIAGRAM

AEHodsdon
CONSULTING ENGINEERS
10 Common Street Waterville, Maine 04901
(207) 873-5164
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STATE OF MAINE
BENJAMIN E. MURRAY
NO. 10128
LICENSED PROFESSIONAL ENGINEER
PRELIMINARY WITHOUT FINALLY SEAL AND SIGN

ELECTRICAL PLAN
OF
ENFIELD STORAGE BARN
COBB ROAD
ENFIELD, MAINE
FOR
MAINE DEPT OF INLAND FISHERIES & WILDLIFE
41 STATE HOUSE STATION
AUGUSTA, MAINE

DRAWN	CHECKED
MG	AEH
SCALE	DATE
AS NOTED	04-01-2021

E1.0
PROJECT#: 59-21

ISSUED FOR BID